

APPROVED AS TO IMPACT ON STATE FACILITIES AND CONFORMANCE WITH APPLICABLE  
STATE STANDARDS AND PRACTICES AND THAT TECHNICAL OVERSIGHT WAS PERFORMED.

DATE SIGNED

LICENSE EXP. DATE

REGISTRATION NO.

CALTRANS DESIGN OVERSIGHT APPROVAL

CONSULTANT DESIGN ENGINEER

INDEX OF PLANS


SHEET No. INDEX OF SHEETS

1	TITLE AND LOCATION MAP
2-13	LAYOUT PLANS
14-16	ANTIOCH BRIDGE STRUCTURAL PLANS
17-32	ANTIOCH BRIDGE ELECTRICAL PLANS
33	CARQUINEZ BRIDGE STRUCTURAL PLANS
34-52	CARQUINEZ BRIDGE ELECTRICAL PLANS
53-55	DUMBARTON BRIDGE STRUCTURAL PLANS
56-70	DUMBARTON BRIDGE ELECTRICAL PLANS
71-73	RICHMOND-SAN RAFAEL BRIDGE STRUCTURAL PLANS
74-90	RICHMOND-SAN RAFAEL BRIDGE ELECTRICAL PLANS
91	SAN FRANCISCO-OAKLAND BAY BRIDGE STRUCTURAL PLANS
92-101	SAN FRANCISCO-OAKLAND BAY BRIDGE ELECTRICAL PLANS
102-103	SAN MATEO-HAYWARD BRIDGE STRUCTURAL PLANS
104-123	SAN MATEO-HAYWARD BRIDGE ELECTRICAL PLANS

STATE OF CALIFORNIA  
DEPARTMENT OF TRANSPORTATION  
PROJECT PLANS FOR CONSTRUCTION ON  
STATE HIGHWAY

IN ALAMEDA, CONTRA COSTA AND SOLANO COUNTIES  
ON ROUTES 80, 84, 92, 160, AND 580  
AT THE TOLL PLAZA SITES

TO BE SUPPLEMENTED BY STANDARD PLANS DATED MAY 2006

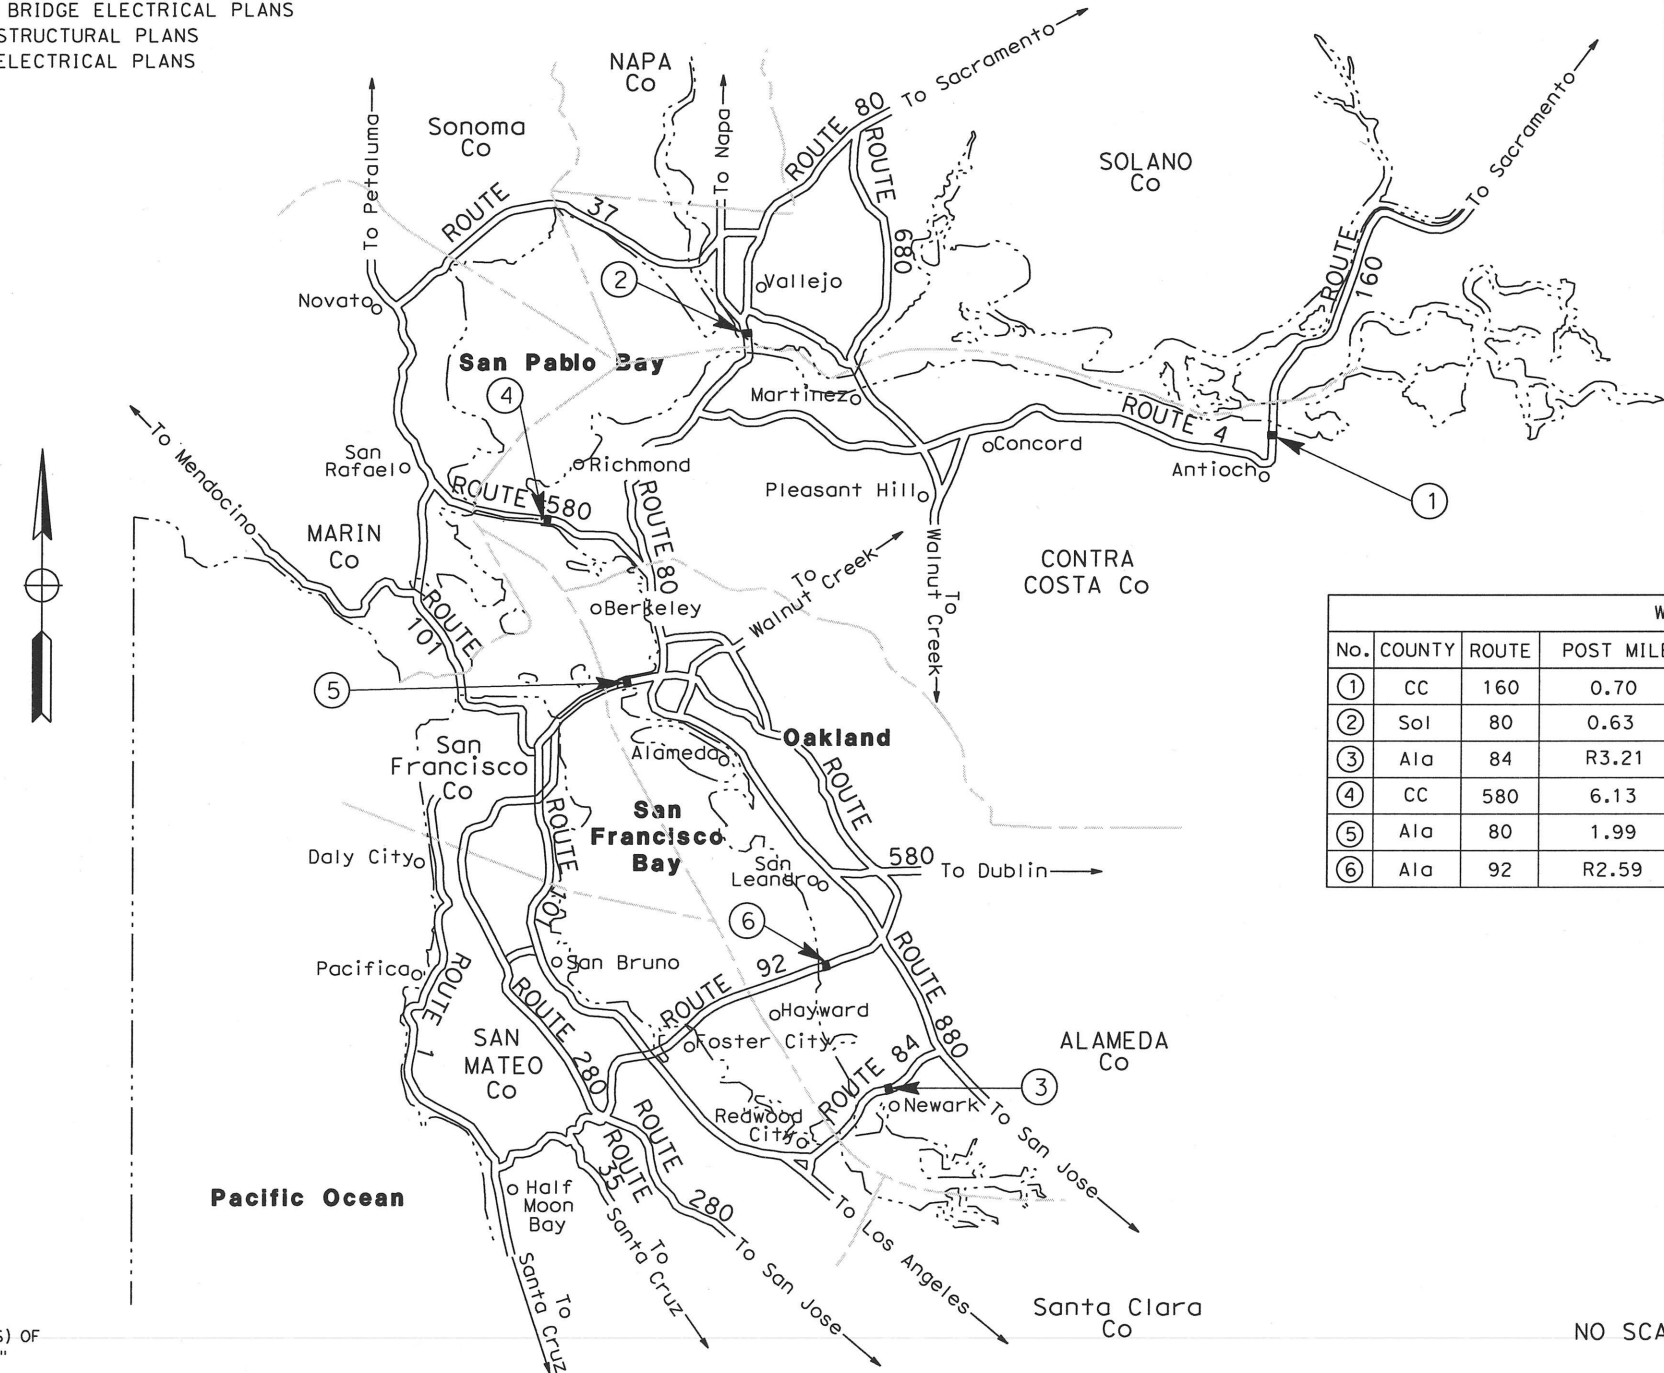

Dist	COUNTY	ROUTE	POST MILES TOTAL PROJECT	SHEET No.	TOTAL SHEETS
04	Ala, CC, Sol	80,84,92, 160,580	Var	1	123



WORK LOCATIONS				
No.	COUNTY	ROUTE	POST MILE	DESCRIPTION
①	CC	160	0.70	Antioch Bridge Toll Plaza
②	Sol	80	0.63	Carquinez Bridge Toll Plaza
③	Ala	84	R3.21	Dumbarton Bridge Toll Plaza
④	CC	580	6.13	Richmond-San Rafael Bridge Toll Plaza
⑤	Ala	80	1.99	San Francisco-Oakland Bay Bridge Toll Plaza
⑥	Ala	92	R2.59	San Mateo-Hayward Bridge Toll Plaza

PROJECT ENGINEER  
REGISTERED CIVIL ENGINEER  
DATE 3/12/10  
REGISTERED PROFESSIONAL ENGINEER  
RAMSEY J. HISSON  
No. C-39608  
Exp. 12-31-10  
CIVIL  
STATE OF CALIFORNIA  
PLANS APPROVAL DATE  
THE STATE OF CALIFORNIA OR ITS  
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BAY AREA TOLL AUTHORITY (BATA)  
101 EIGHTH STREET  
OAKLAND, CA 94607  
URS CORPORATION  
55 S. MARKET STREET, SUITE 1500  
SAN JOSE, CA 95113

CONTRACT No. 04-TBD


THE CONTRACTOR SHALL POSSESS THE CLASS (OR CLASSES) OF  
LICENSE AS SPECIFIED IN THE "NOTICE TO CONTRACTORS."

NO SCALE

BORDER LAST REVISED 2/1/2008

CALTRANS WEB SITE IS: [HTTP://WWW.DOT.CA.GOV/](http://www.dot.ca.gov/)

RELATIVE BORDER SCALE  
IS IN INCHES

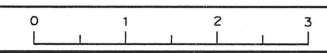

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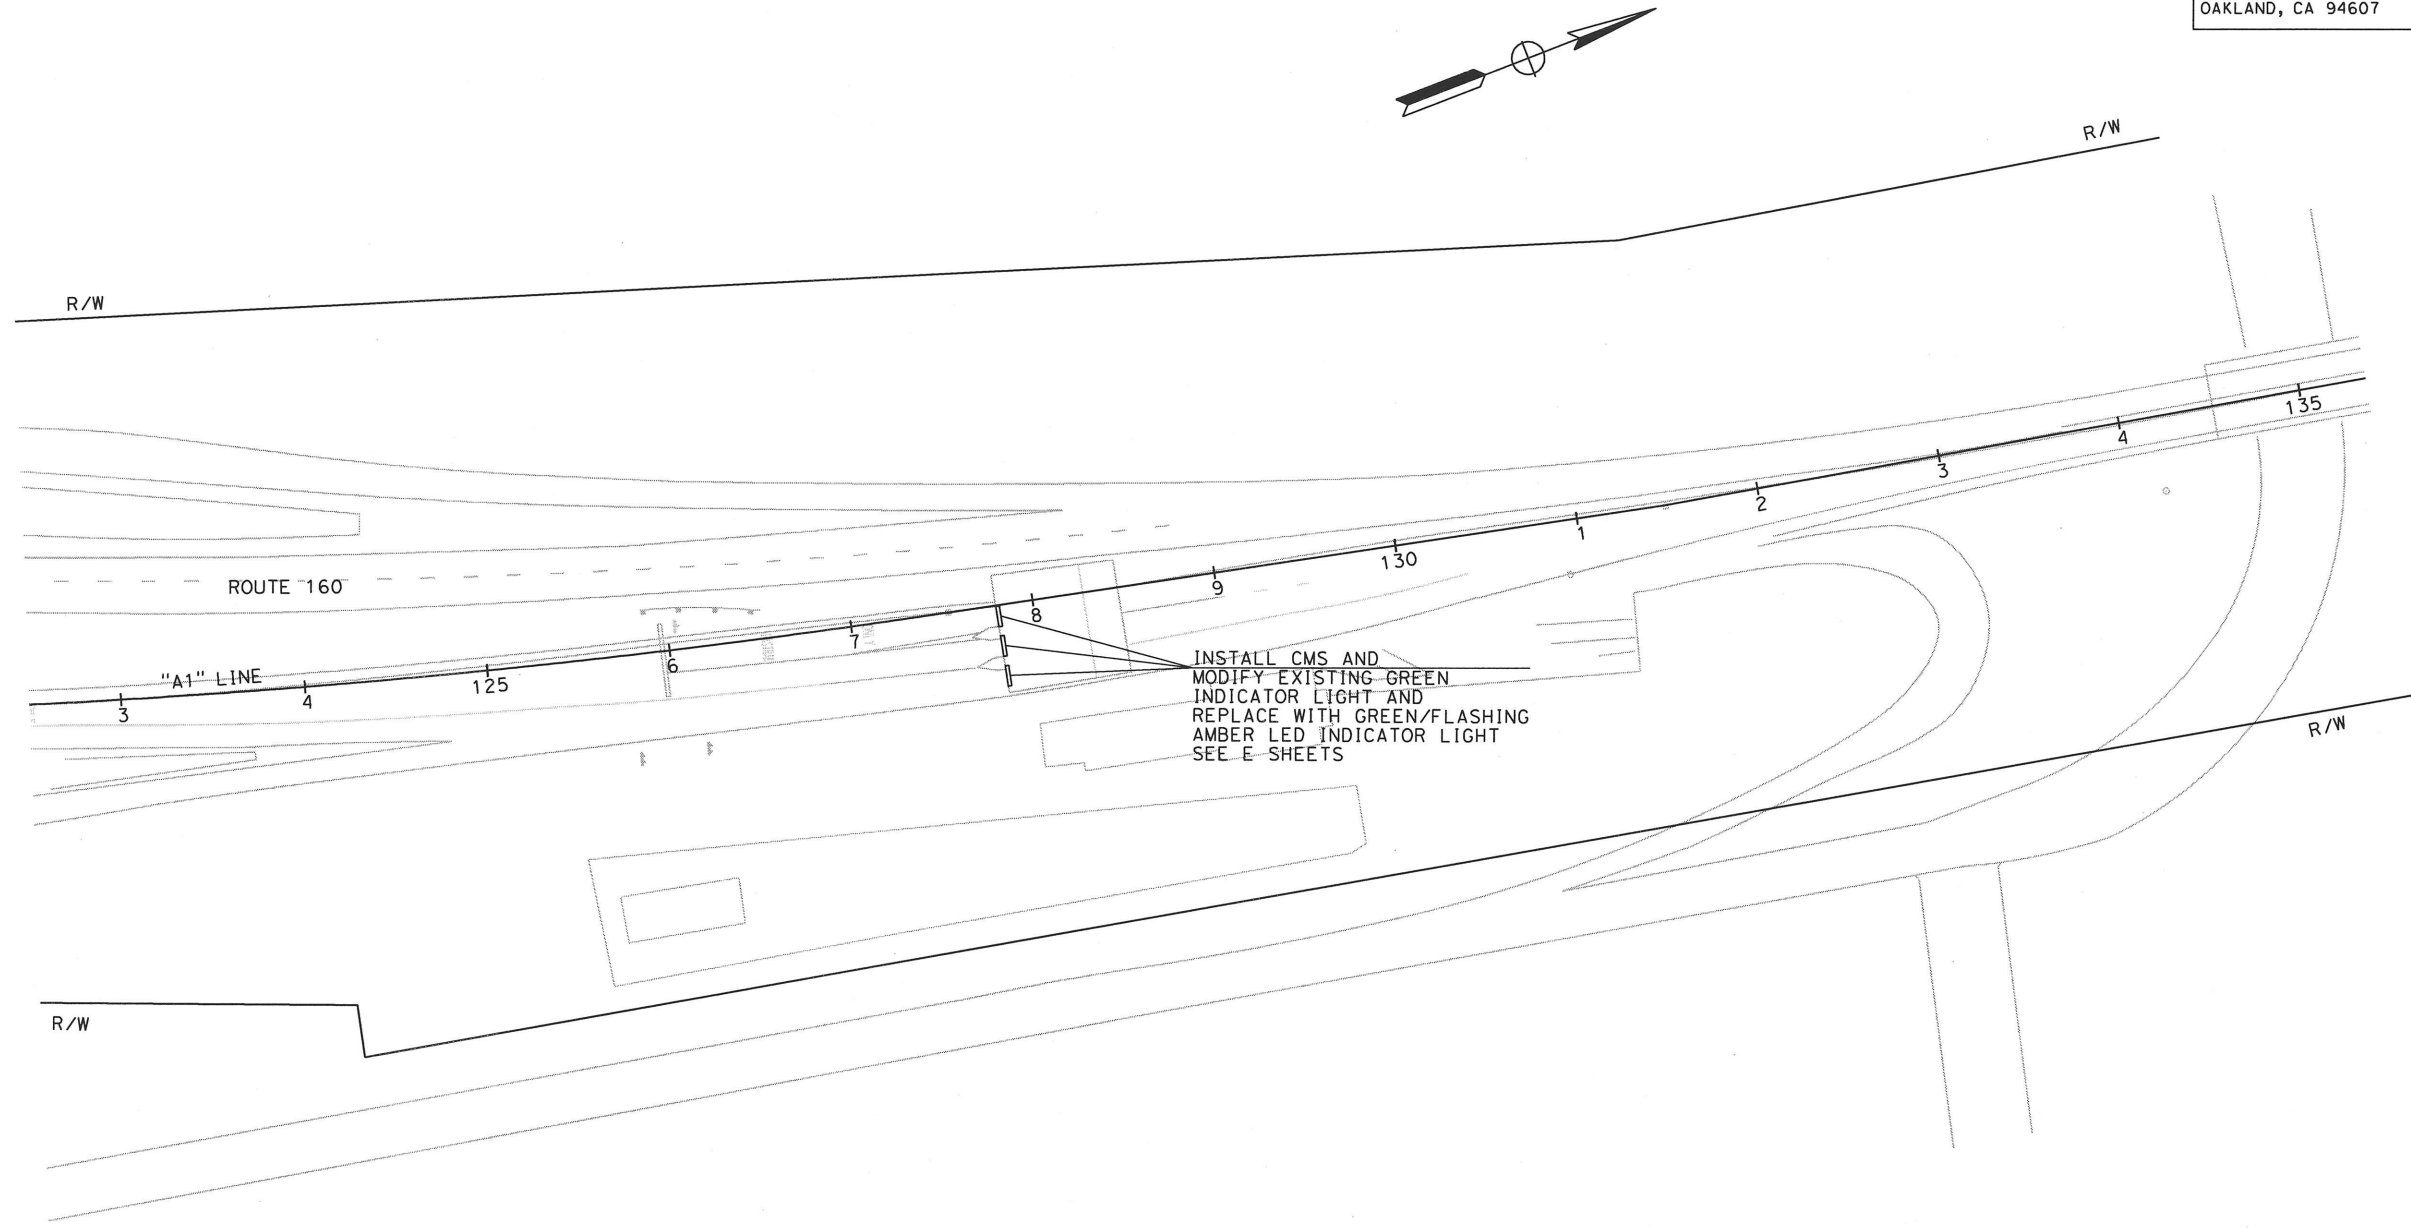
CU 00000

EA TBD (BATA-0006)

DATE PLOTTED => 3/15/2010  
TIME PLOTTED => 7:43:26 AM  
LAST REVISION  
00-00-00

STATE OF CALIFORNIA - DEPARTMENT OF TRANSPORTATION	CONSULTANT FUNCTIONAL SUPERVISOR	CALCULATED-DESIGNED BY	CHECKED BY	REVISOR	DATE

- LEGEND:
- EXISTING SIGN TO REMAIN
  - REMOVE SIGN
  - CMS CHANGEABLE MESSAGE SIGN
  - EMS EXTINGUISHABLE MESSAGE SIGN



Dist	COUNTY	ROUTE	POST MILES TOTAL PROJECT	SHEET No.	TOTAL SHEETS
04	CC	160	0.70	2	123

REGISTERED CIVIL ENGINEER	DATE
3/12/10	

PLANS APPROVAL DATE
3/12/10

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FOR COMPLETE RIGHT OF WAY DATA,  
SEE RIGHT OF WAY RECORD MAPS AT DISTRICT OFFICE.

# ANTIOCH BRIDGE LAYOUT L-1

SCALE: 1"=50'









NOTE:

1. REMOVE SIGN PANEL AND SEAL PANEL BOLT HOLES

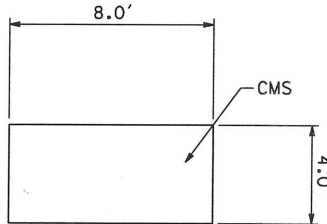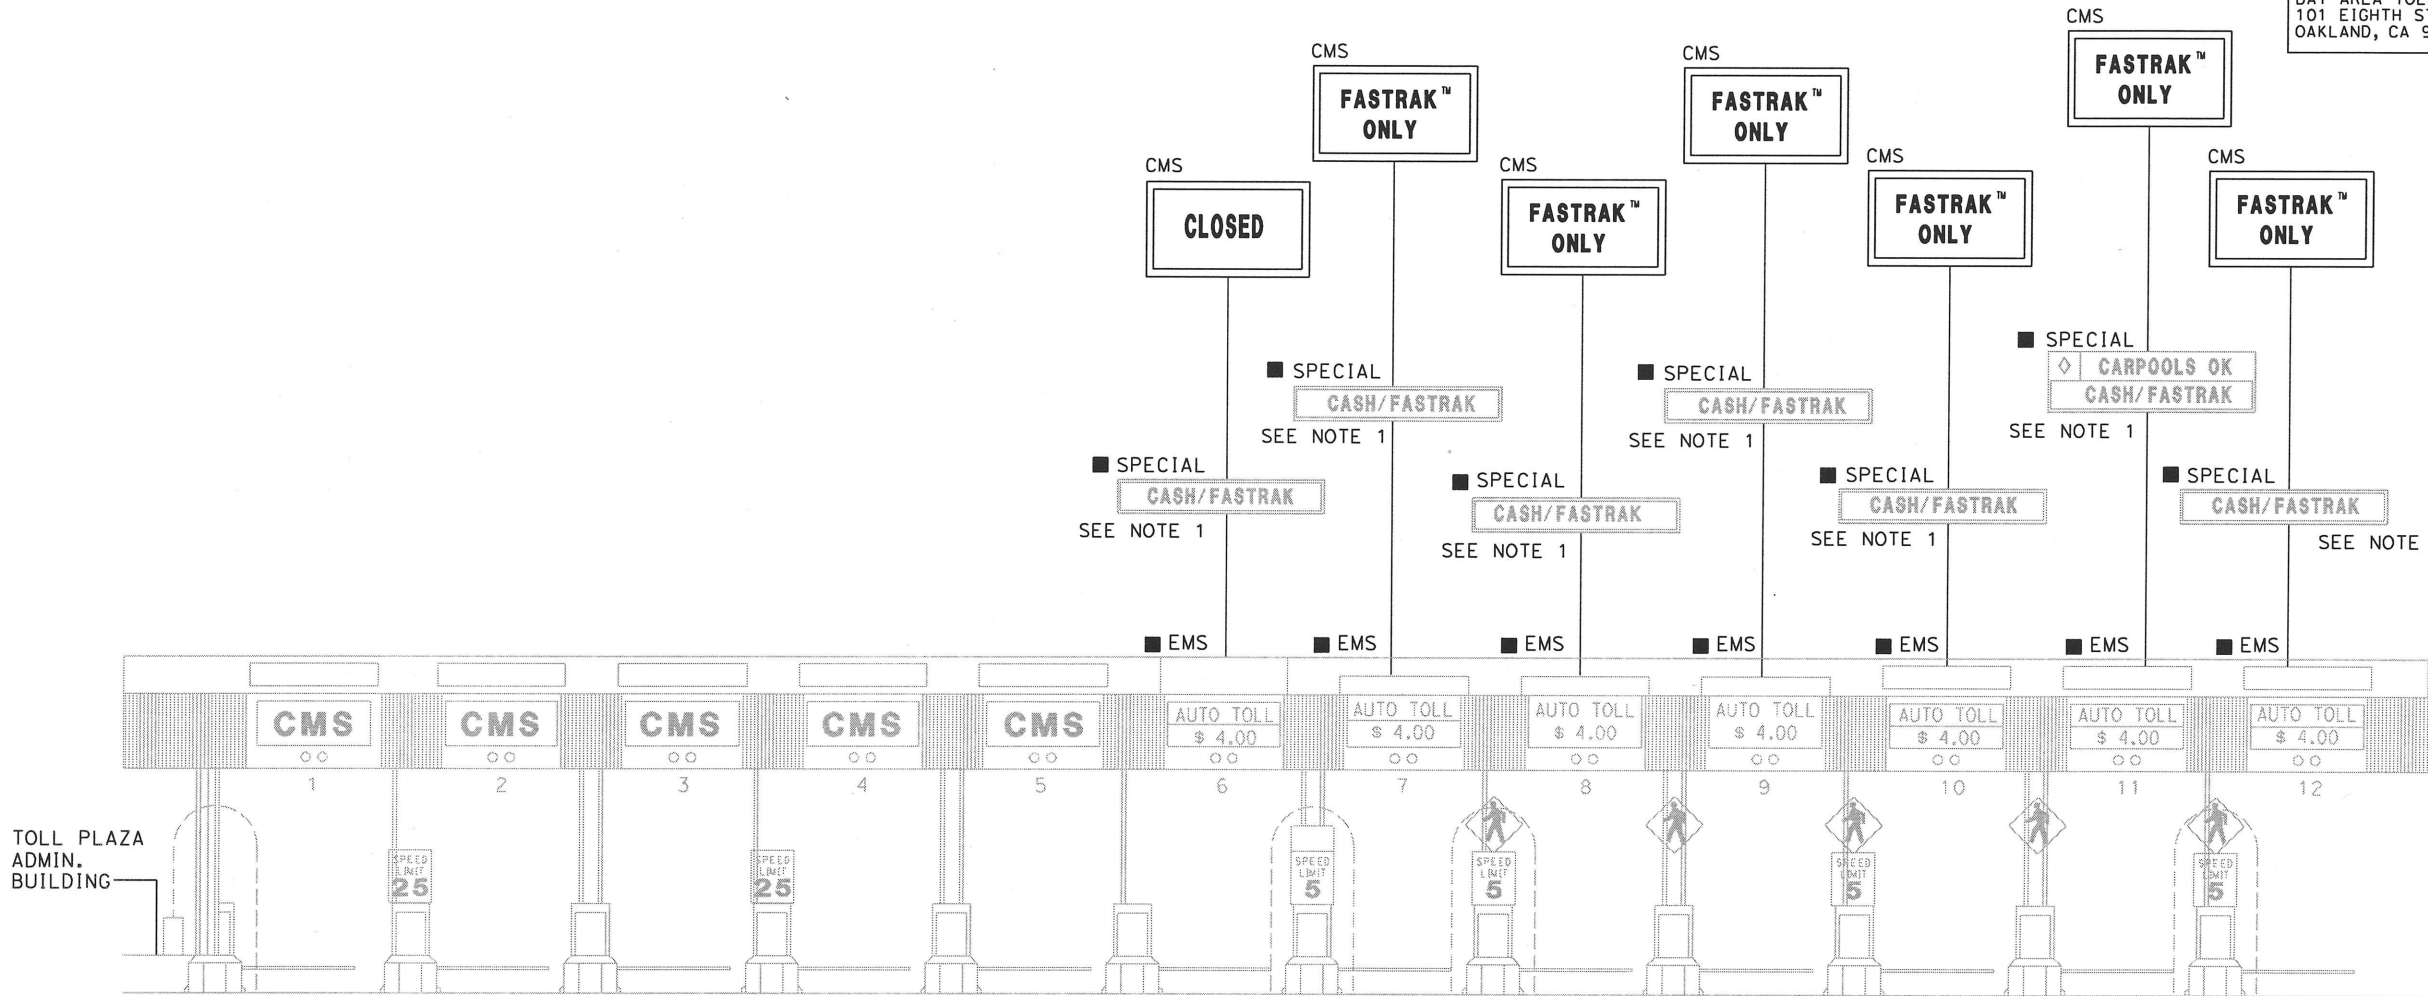

TYPE 2 CMS PANEL  
(MOUNTED ON TOLL PLAZA CANOPY)

CARQUINEZ BRIDGE  
LAYOUT  
L-4

FOR COMPLETE RIGHT OF WAY DATA,  
SEE RIGHT OF WAY RECORD MAPS AT DISTRICT OFFICE.

NO SCALE

Dist	COUNTY	ROUTE	POST MILES TOTAL PROJECT	SHEET No.	TOTAL SHEETS
04	SoI	80	0.63	5	123

REGISTERED CIVIL ENGINEER DATE

PLANS APPROVAL DATE

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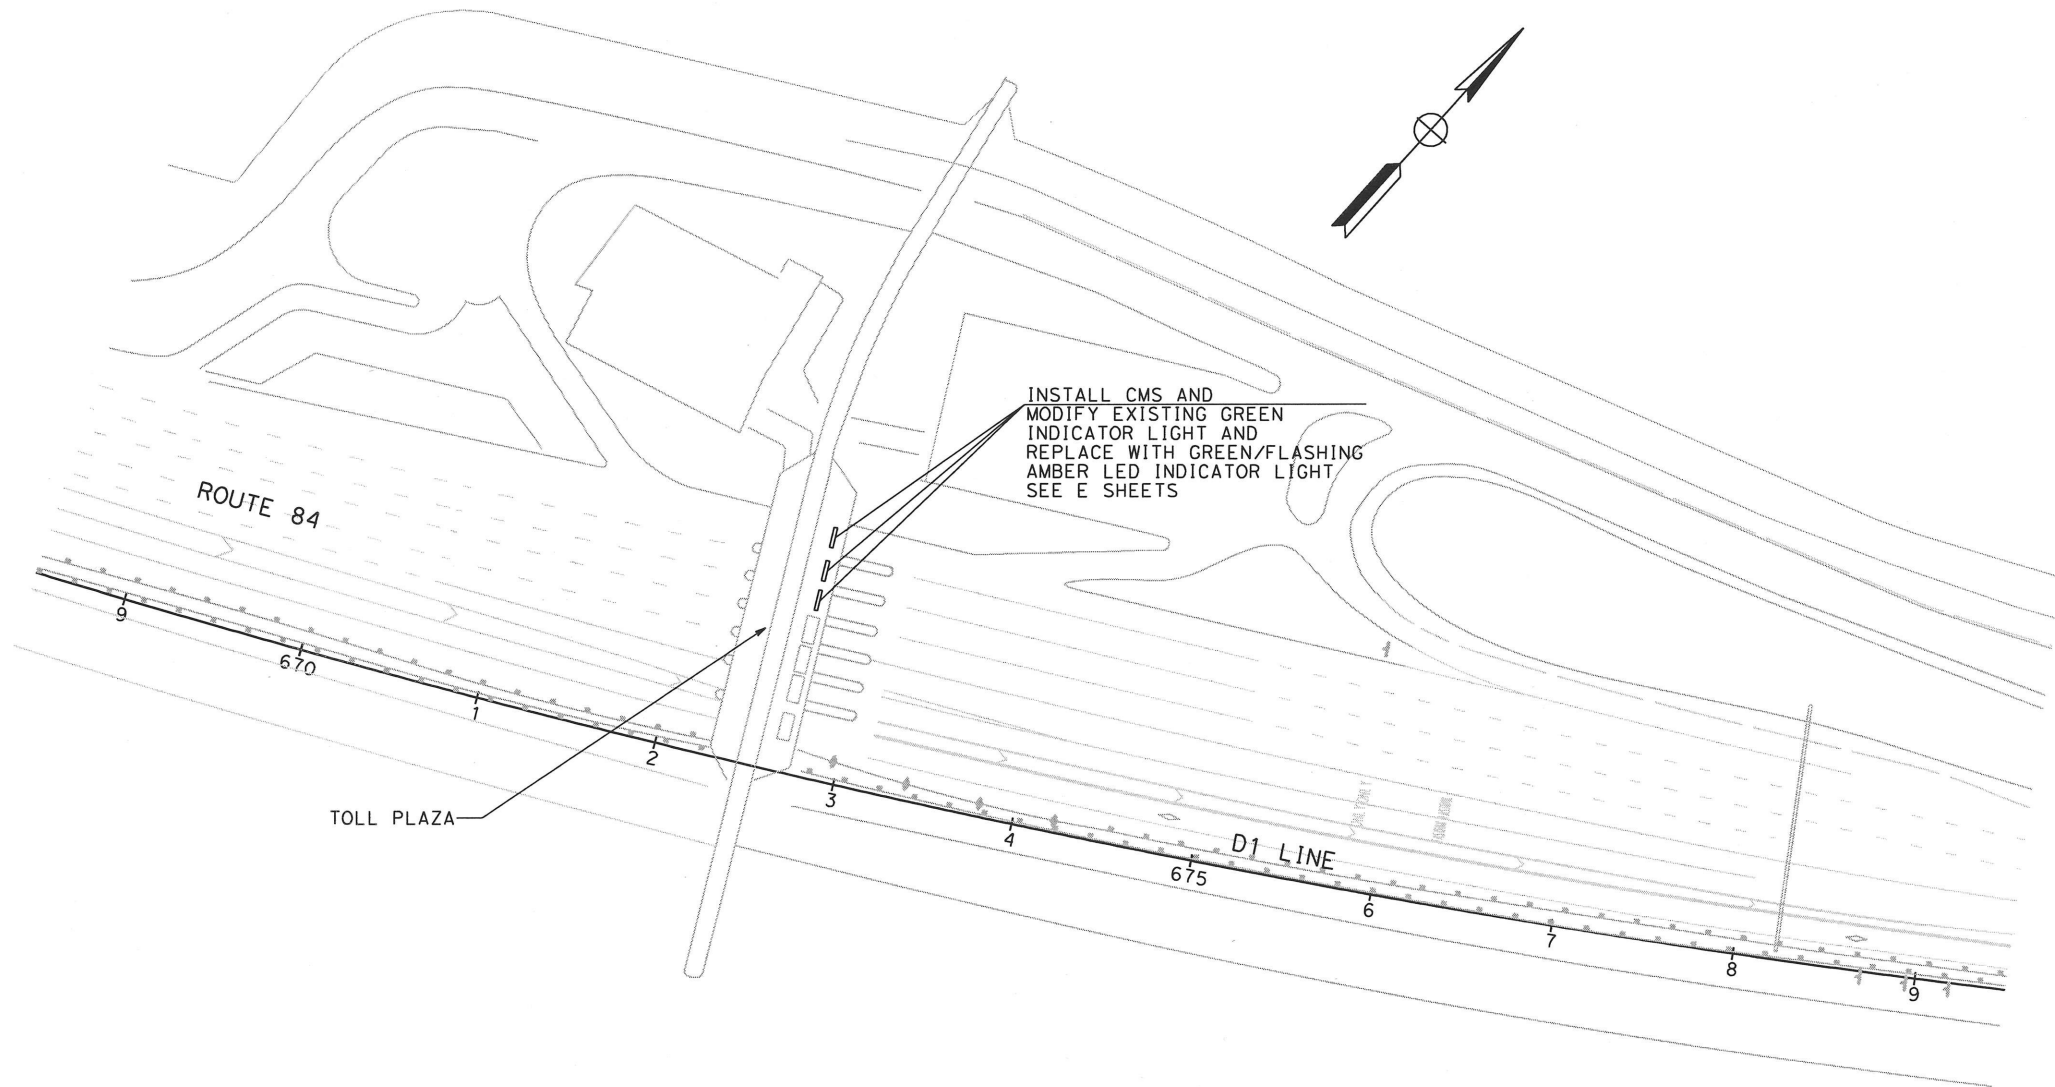
BAY AREA TOLL AUTHORITY  
101 EIGHTH STREET  
OAKLAND, CA 94607

URS CORPORATION  
55 South Market Street  
Suite 1500  
San Jose, CA 95113

STATE OF CALIFORNIA - DEPARTMENT OF TRANSPORTATION	CONSULTANT FUNCTIONAL SUPERVISOR	CALCULATED-DESIGNED BY	CHECKED BY	REVISED BY	DATE REVISED



FOR COMPLETE RIGHT OF WAY DATA,  
SEE RIGHT OF WAY RECORD MAPS AT DISTRICT OFFICE.



Dist	COUNTY	ROUTE	POST MILES TOTAL PROJECT	SHEET No.	TOTAL SHEETS
04	Ala	84	R3.21	6	123

REGISTERED CIVIL ENGINEER	DATE
PLANS APPROVAL DATE	

REGISTERED PROFESSIONAL ENGINEER  
 No. C-39608  
 Exp. 12-31-10  
 CIVIL  
 STATE OF CALIFORNIA

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# DUMBARTON BRIDGE LAYOUT L-5

SCALE: 1"=50'










STATE OF CALIFORNIA - DEPARTMENT OF TRANSPORTATION	CONSULTANT FUNCTIONAL SUPERVISOR		REVISOR	DATE
	CHECKED BY			
	CALCULATED-DESIGNED BY			
	DATE REVISED			

STANDARD

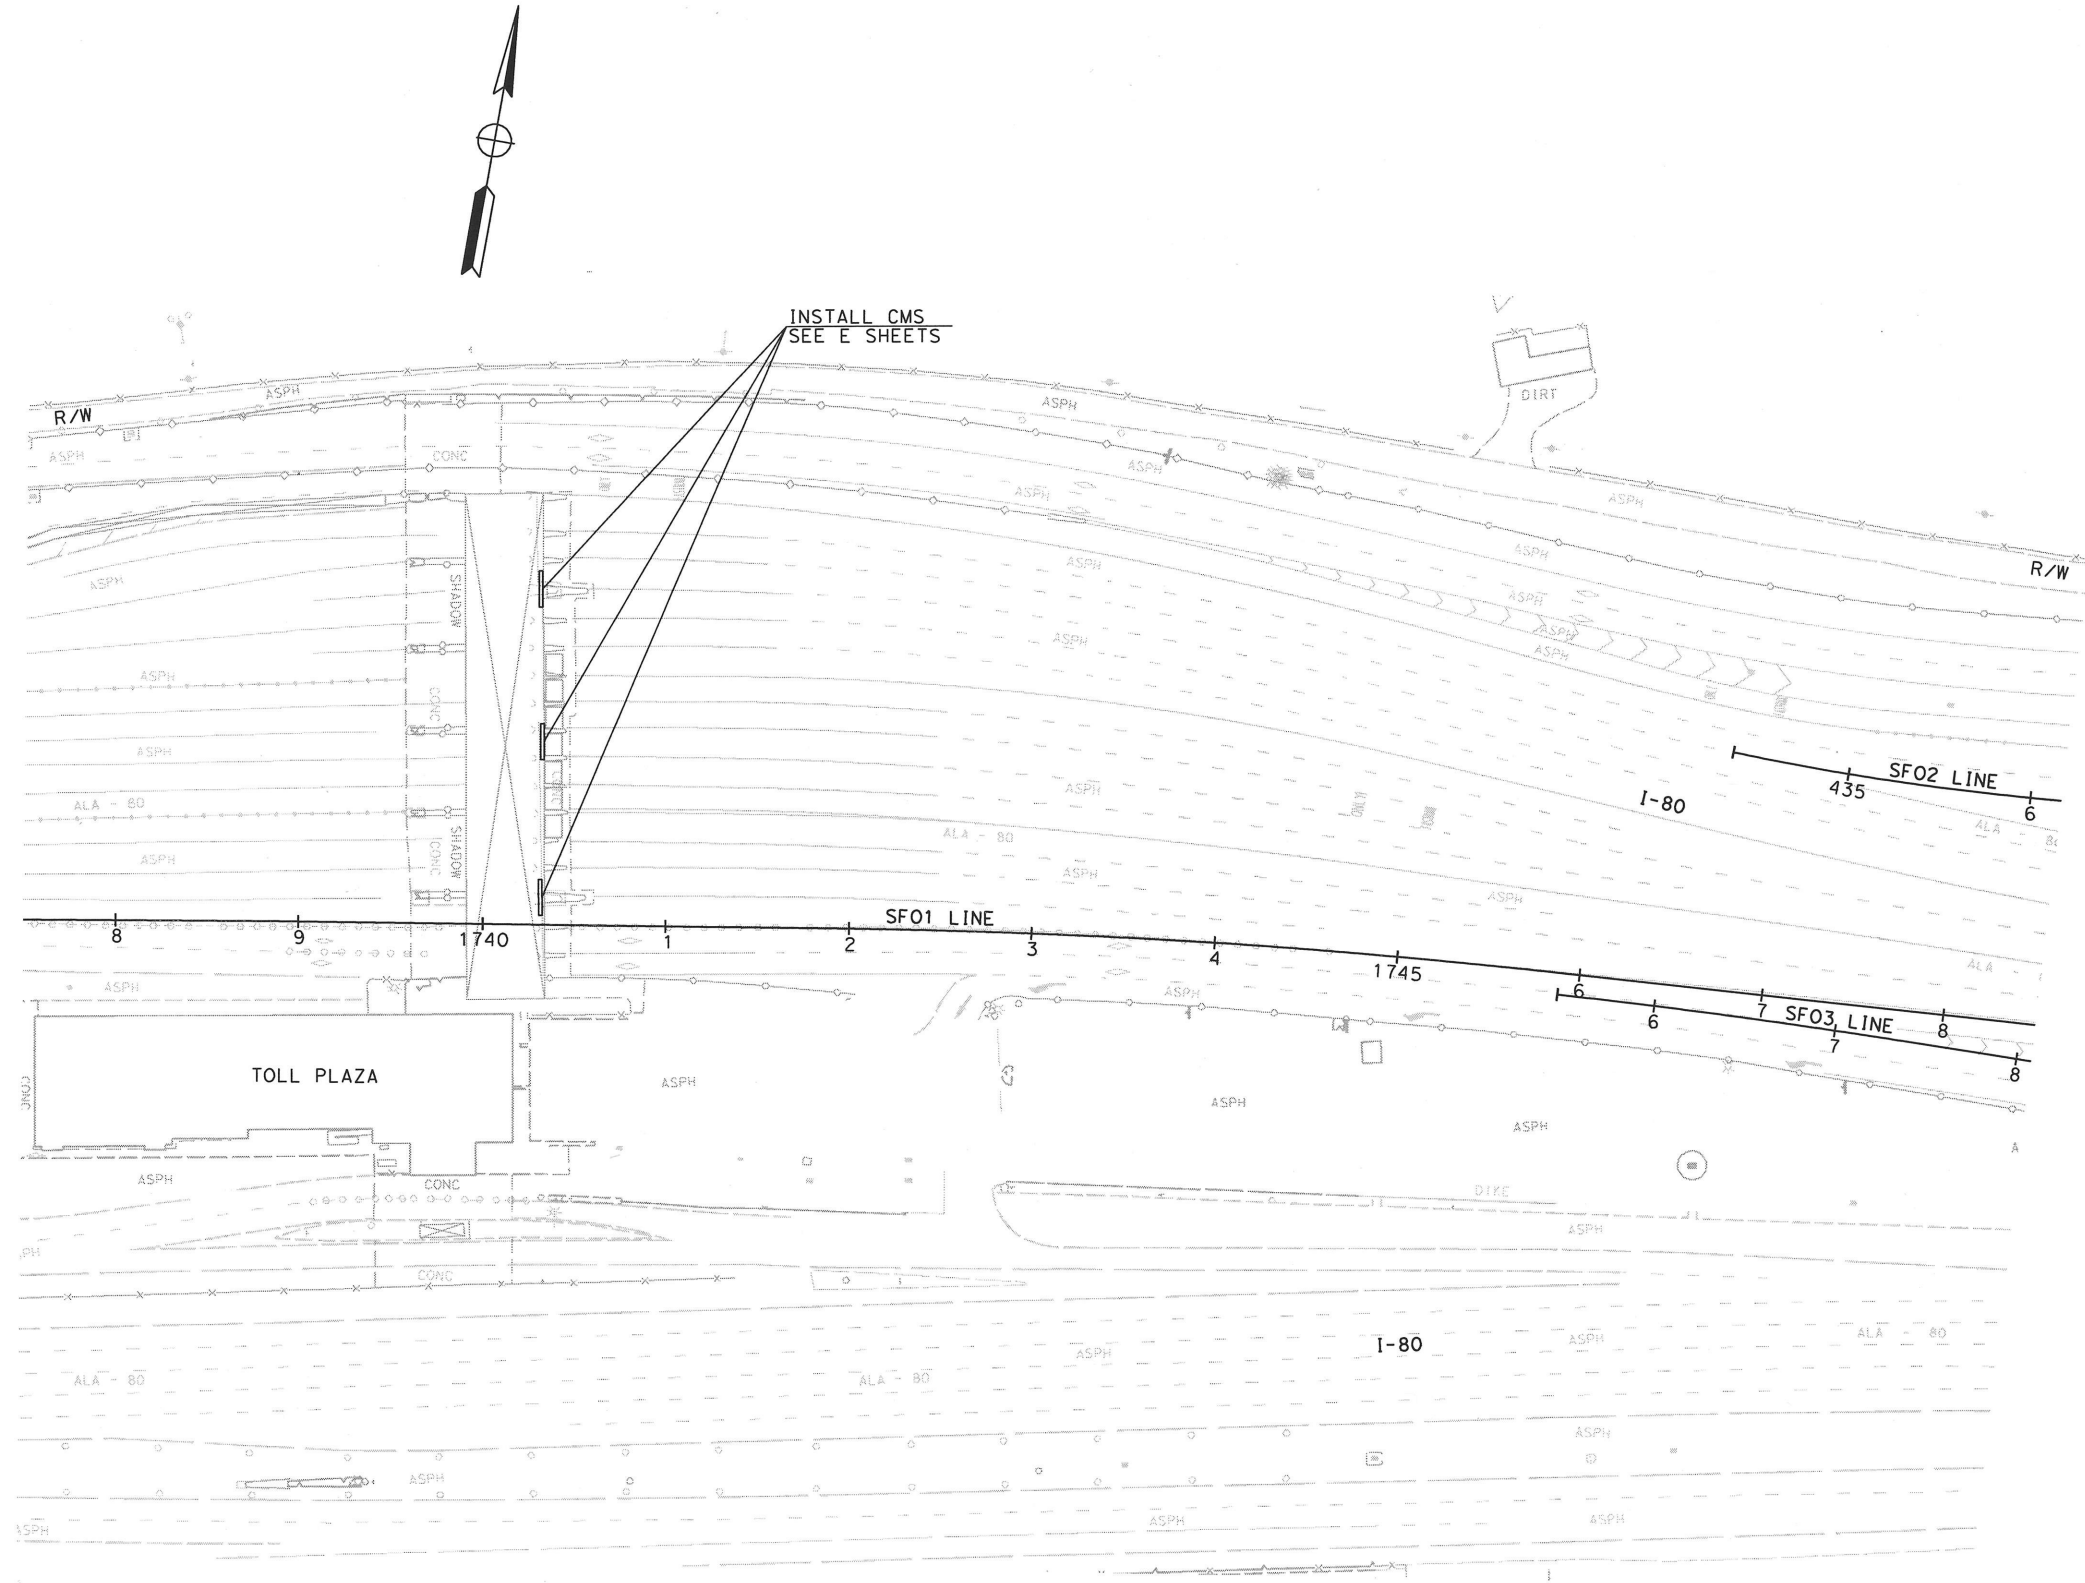

FOR COMPLETE RIGHT OF WAY DATA,  
SEE RIGHT OF WAY RECORD MAPS AT DISTRICT OFFICE.

Dist	COUNTY	ROUTE	POST MILES TOTAL PROJECT	SHEET NO.	TOTAL SHEETS
04	Ala	80	1.99	10	123

REGISTERED CIVIL ENGINEER DATE

PLANS APPROVAL DATE

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101 EIGHTH STREET  
OAKLAND, CA 94607

URS CORPORATION  
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Suite 1500  
San Jose, CA 95113

REGISTERED PROFESSIONAL ENGINEER  
No. C-39608  
Exp. 12-31-10  
CIVIL  
STATE OF CALIFORNIA



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CU 00000



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DATE PLOTTED => 3/15/2010  
TIME PLOTTED => 7:52:47 AM



STATE OF CALIFORNIA - DEPARTMENT OF TRANSPORTATION  
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DATE  
CALCULATED BY  
CHECKED BY  
CONSULTANT FUNCTIONAL SUPERVISOR  
DATE  
REVISOR  
DATE  
CALCULATED BY  
CHECKED BY


NOTE:  
1. REMOVE SIGN PANEL AND SEAL PANEL BOLT HOLES

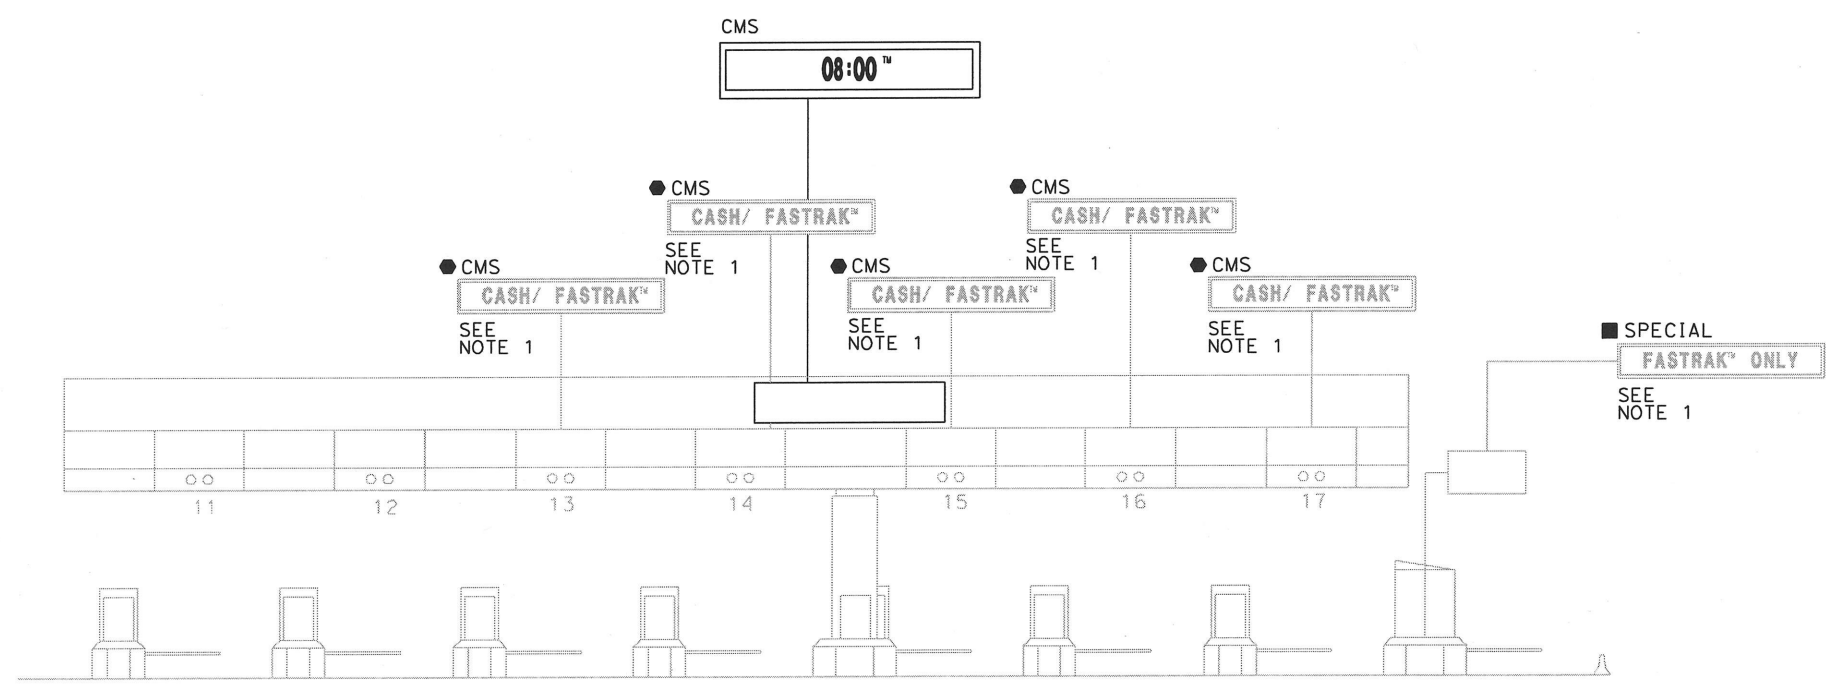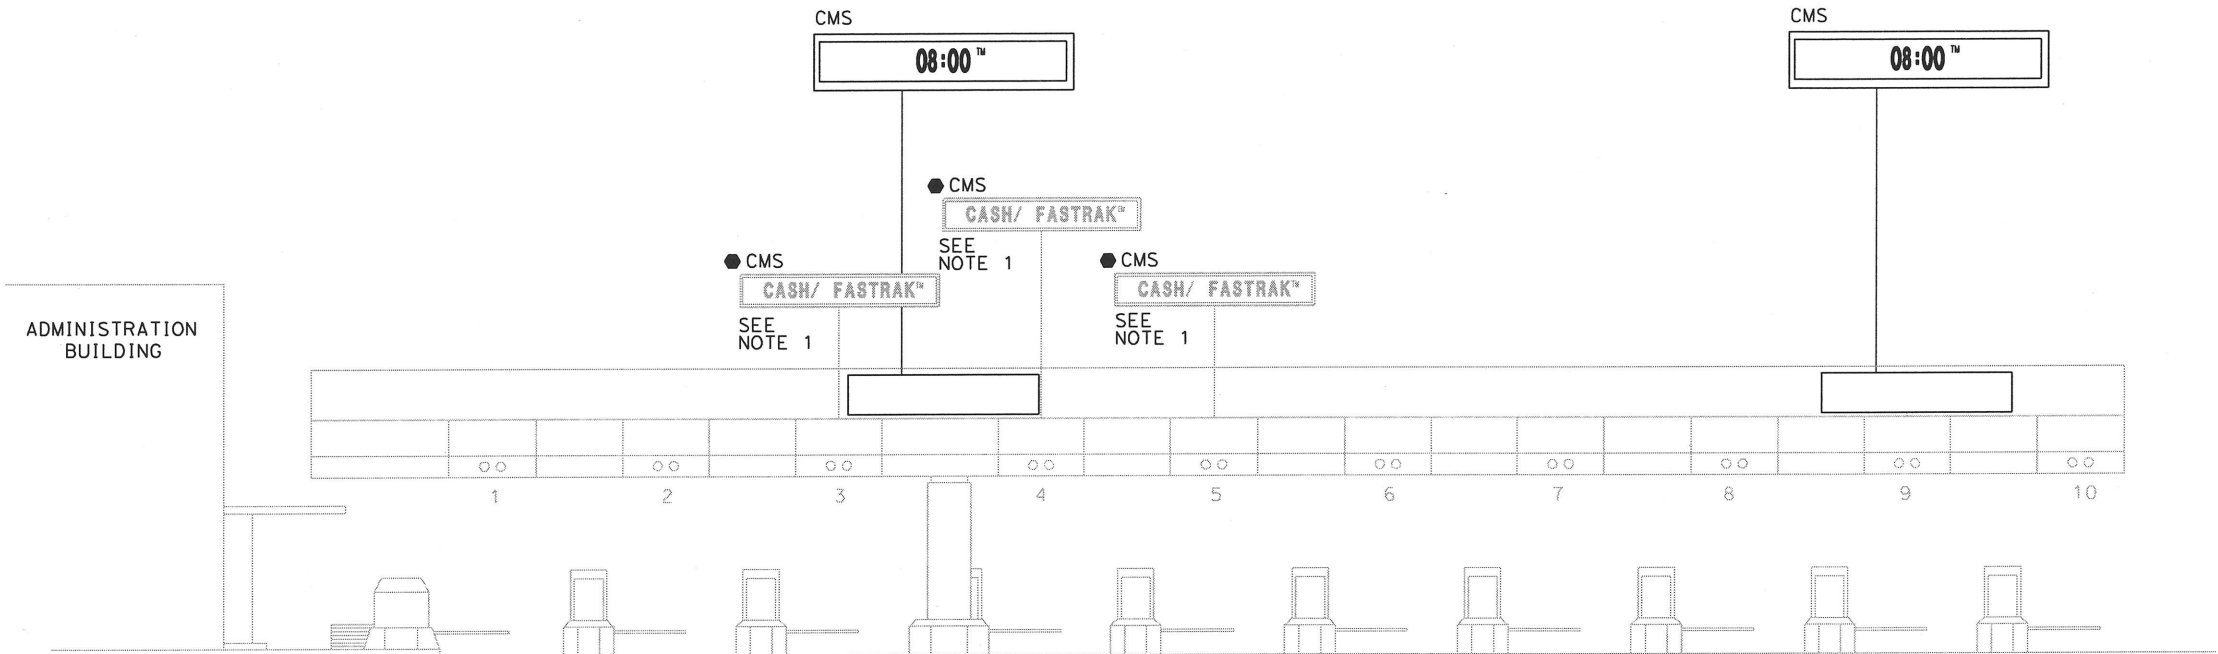

SAN FRANCISCO-OAKLAND BAY BRIDGE  
LAYOUT  
L-10

FOR COMPLETE RIGHT OF WAY DATA,  
SEE RIGHT OF WAY RECORD MAPS AT DISTRICT OFFICE.

NO SCALE

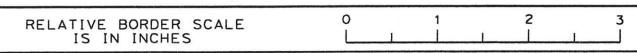

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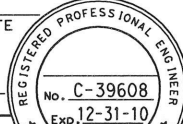
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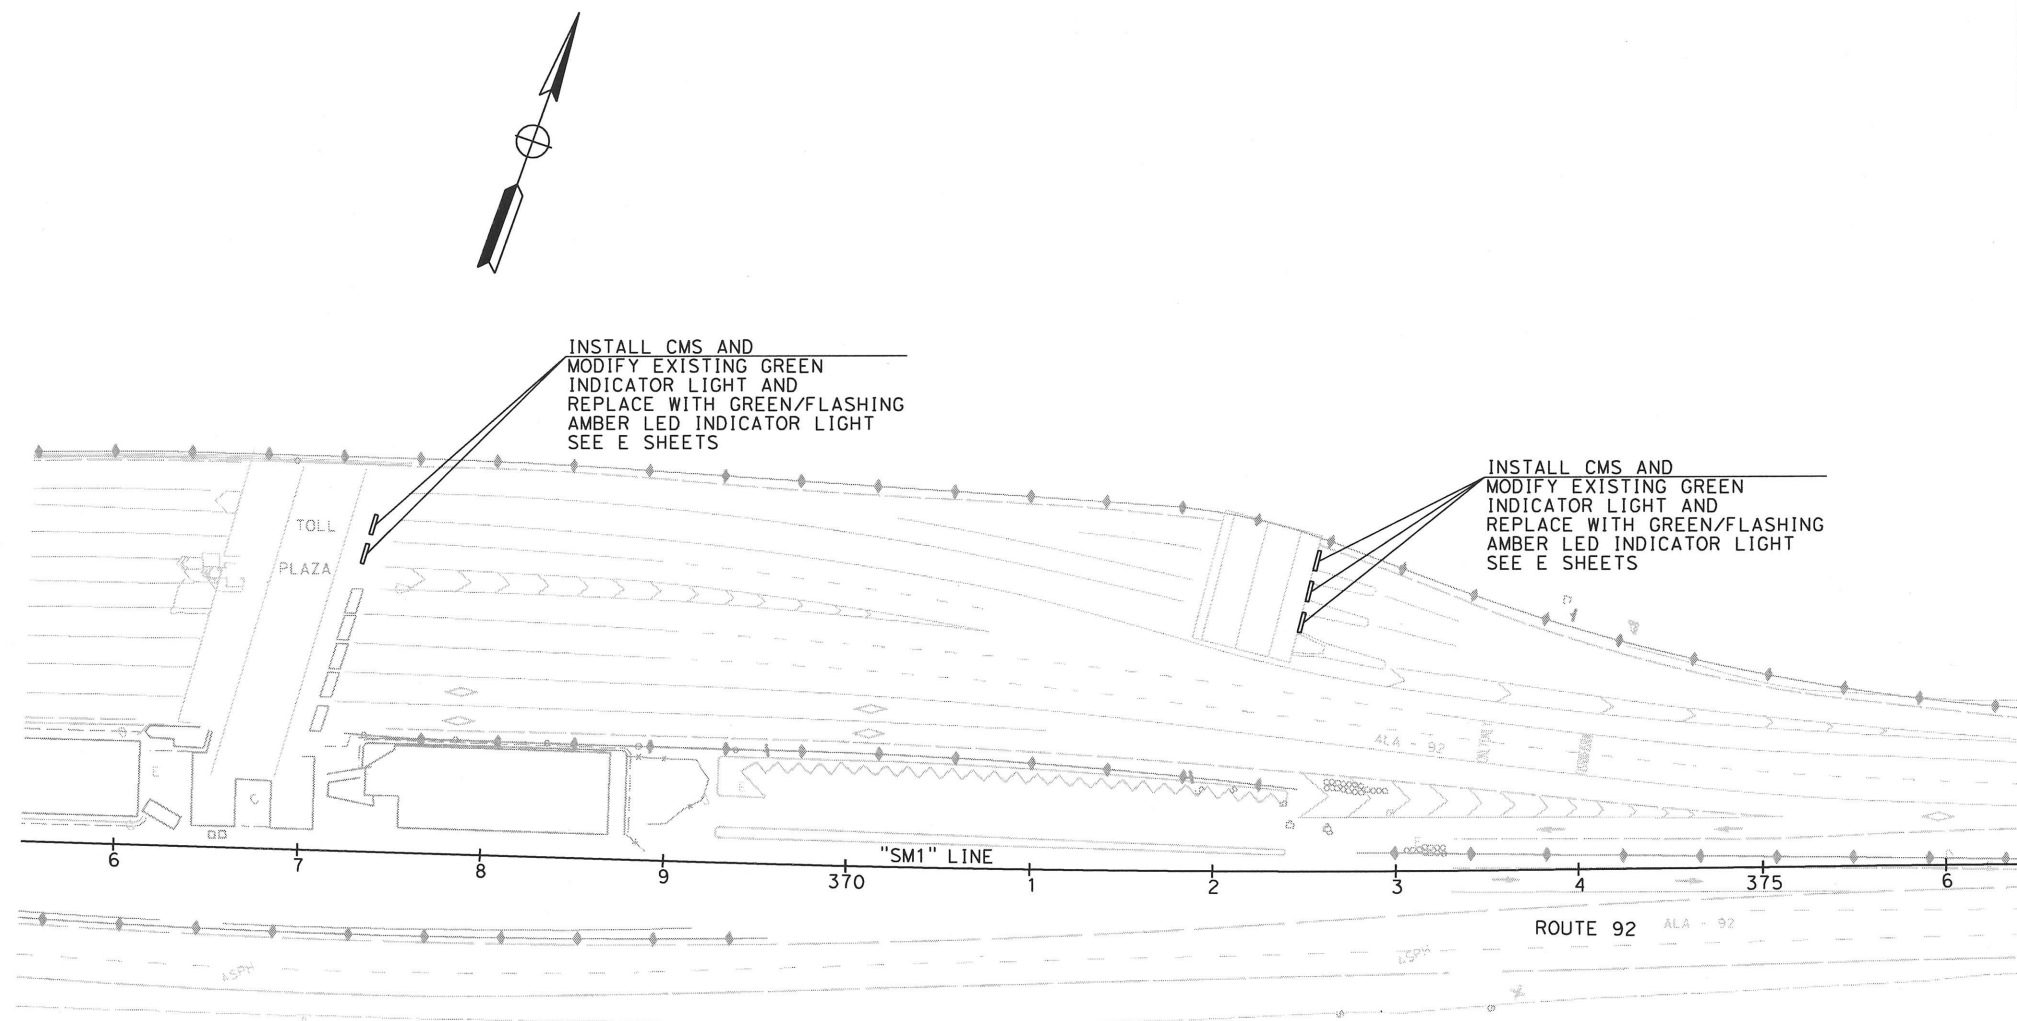
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REGISTERED PROFESSIONAL ENGINEER  
No. C-39608  
Exp. 12-31-10  
CIVIL  
STATE OF CALIFORNIA

CU 00000 EA TBD (BATA-0006)

DATE PLOTTED => 3/15/2010  
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LAST REVISION 00-00-00


Dist	COUNTY	ROUTE	POST MILES TOTAL PROJECT	SHEET TOTAL No.	TOTAL SHEETS
04	Ala	92	R2.59	12	123
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BAY AREA TOLL AUTHORITY 101 GUNSHAW STREET OAKLAND, CA 94607			USS CORPORATION 55 South Market Street Suite 1500 San Jose, CA 95113		



**SAN MATEO-HAYWARD BRIDGE**  
**LAYOUT**  
SCALE: 1"=50' **L-11**

FOR COMPLETE RIGHT OF WAY DATA,  
SEE RIGHT OF WAY RECORD MAPS AT DISTRICT OFFICE.

NOTE:  
1. REMOVE SIGN PANEL AND SEAL PANEL BOLT HOLES

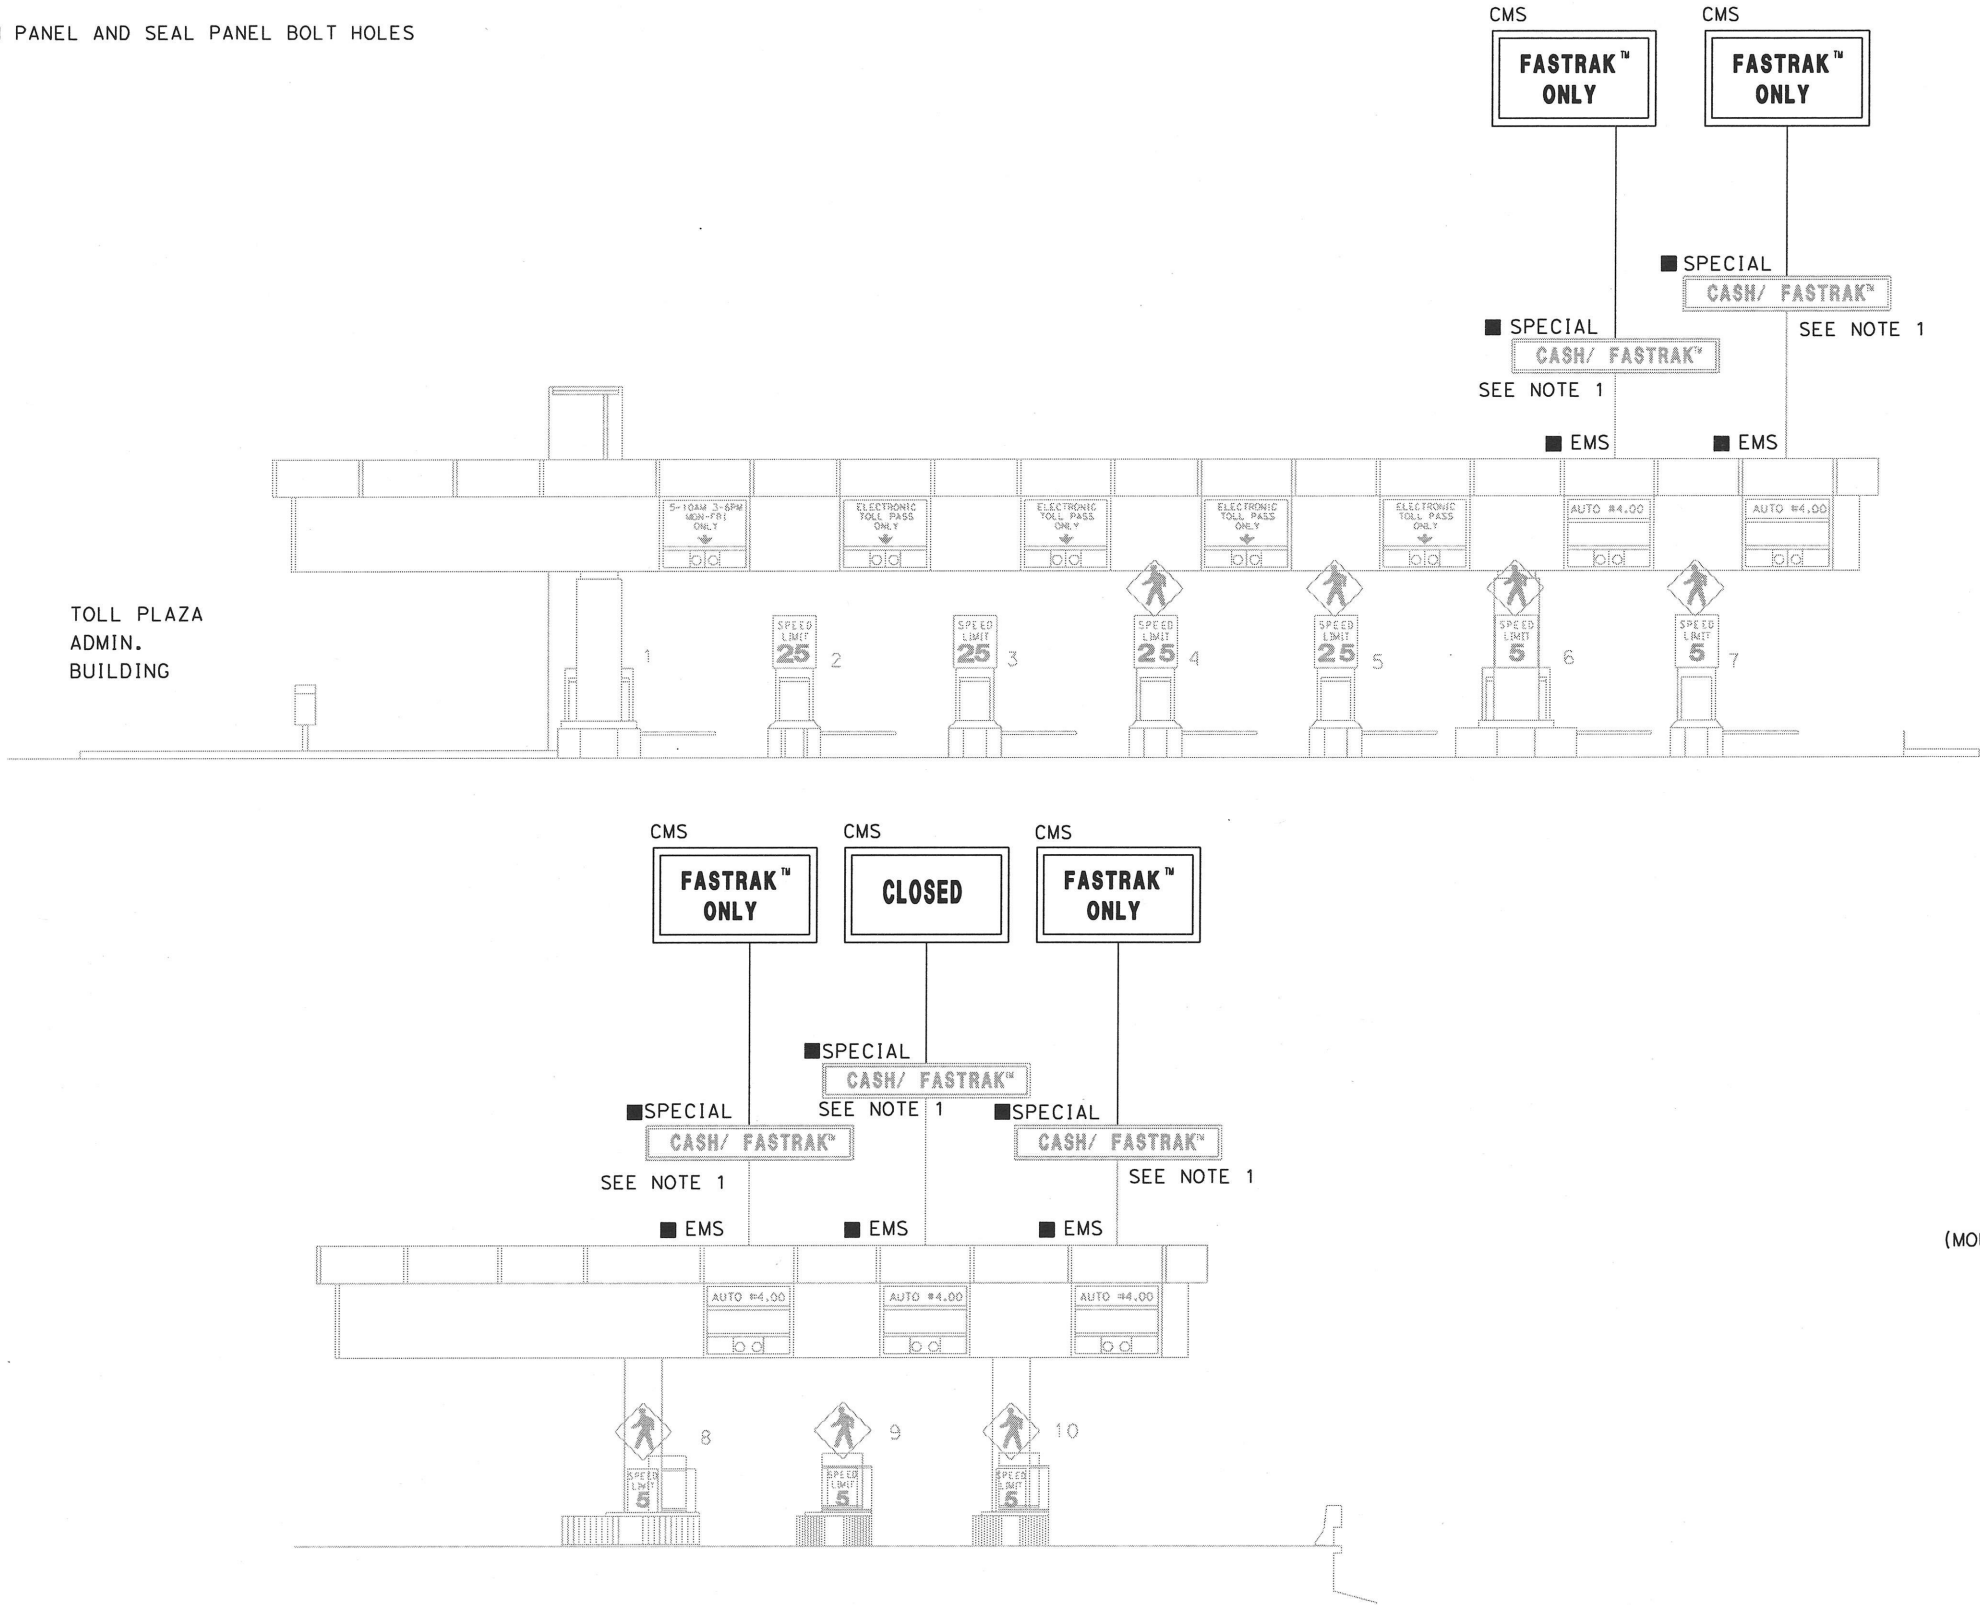

Dist	COUNTY	ROUTE	POST MILES TOTAL PROJECT	SHEET No.	TOTAL SHEETS
04	Ala	92	R2.59	13	123

REGISTERED CIVIL ENGINEER

3/12/10

DATE

PLANS APPROVAL DATE

3/12/10

DATE

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RAMSEY J. HISSEN

No. C-39608

Exp. 12-31-10

CIVIL

STATE OF CALIFORNIA

BAY AREA TOLL AUTHORITY

101 EIGHTH STREET

OAKLAND, CA 94607

URS CORPORATION

55 South Market Street

Suite 1500

San Jose, CA 95113


TYPE 2 CMS PANEL  
(MOUNTED ON TOLL PLAZA CANOPY)

SAN MATEO-HAYWARD BRIDGE  
LAYOUT  
L-12

FOR COMPLETE RIGHT OF WAY DATA,  
SEE RIGHT OF WAY RECORD MAPS AT DISTRICT OFFICE.

NO SCALE

DIST	COUNTY	ROUTE	POST MILES TOTAL PROJECT	SHEET No	TOTAL SHEETS
04	CC	160	0.70	14	123

  
REGISTERED CIVIL ENGINEER

3/12/10  
DATE

PLANS APPROVAL DATE

REGISTERED PROFESSIONAL ENGINEER

GUOPING XU

No. C 63977

Exp. 09/30/10


CIVIL

STATE OF CALIFORNIA

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BAY AREA TOLL AUTHORITY  
101 EIGHT STREET  
OAKLAND, CALIFORNIA 94607

MGE ENGINEERING, INC.  
7415 GREENHAVEN DRIVE, SUITE 100  
SACRAMENTO, CALIFORNIA 95831

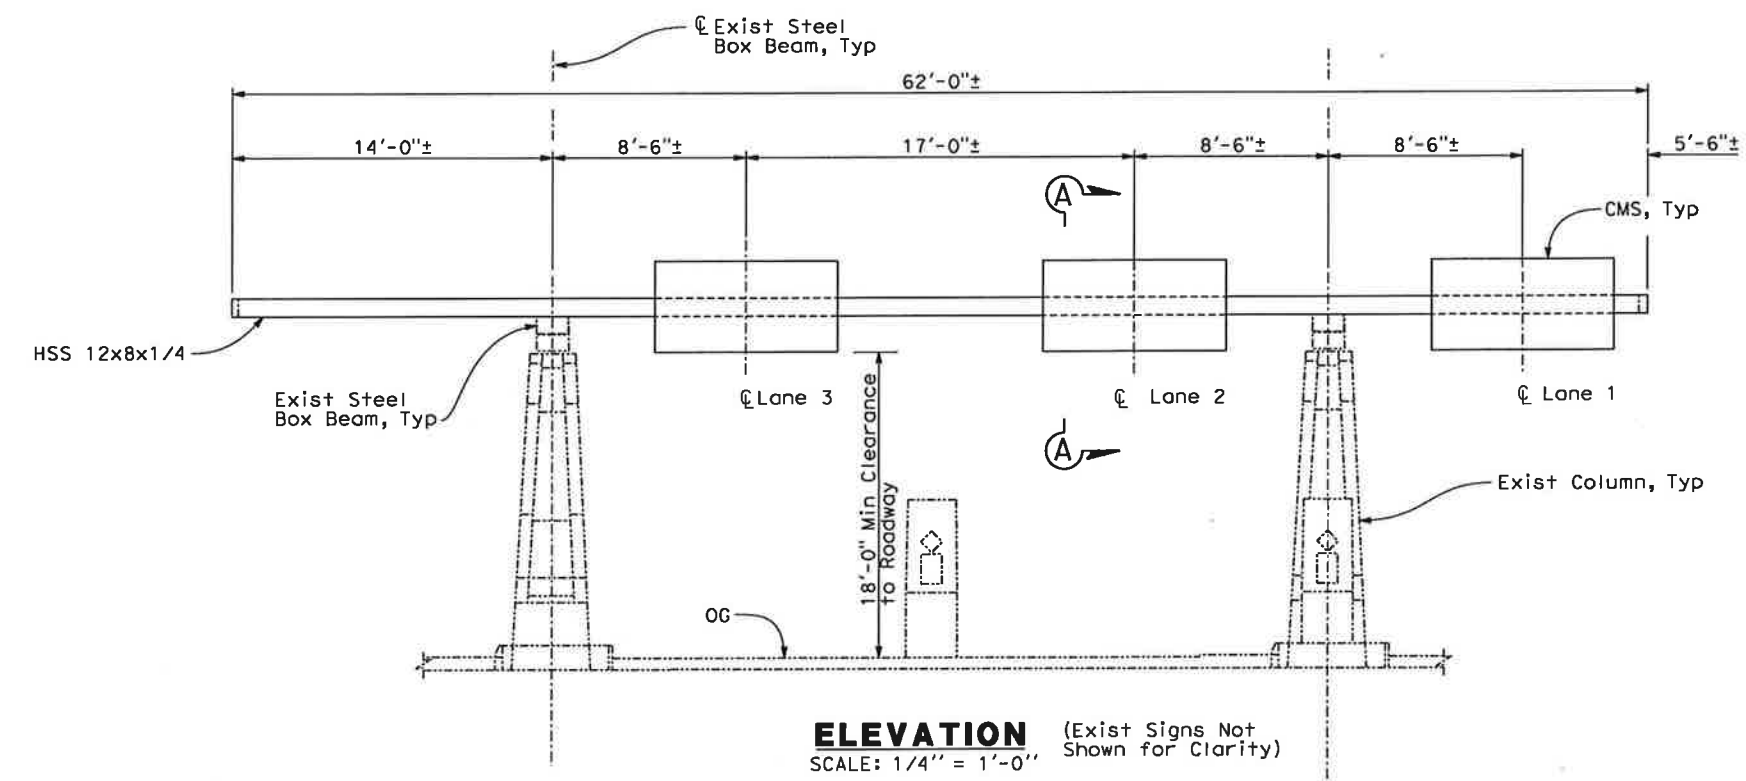


Notes:

1. Exist signs, including wood posts, to be removed prior to installing new CMS supports.
2. For Section A-A, See Sheet S-2.
3. All new steel members shall be galvanized.
4. All bolts, washers and lock nuts shall be of stainless steel or galvanized.

Legend:

- Indicates New Structure
- - - Indicates Exist Structure
- ▨ Indicates removal of portion of Exist roof structure

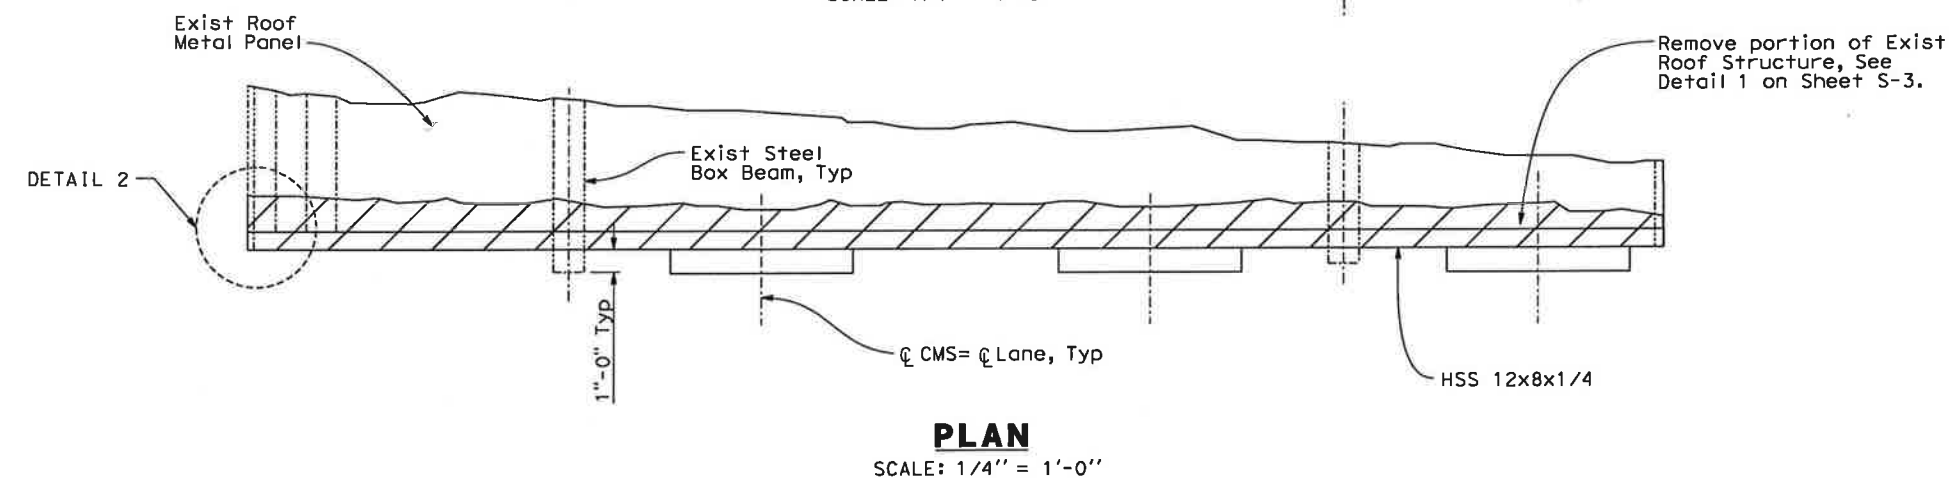

Note:  
The Contractor shall verify all controlling field dimensions before ordering or fabricating any material.

DESIGN OVERSIGHT	DESIGN BY G. Xu	CHECKED	PREPARED FOR THE STATE OF CALIFORNIA DEPARTMENT OF TRANSPORTATION	BRIDGE NO.	ANTIOCH BRIDGE TOLL PLAZA		SHEET
SIGN OFF DATE	DETAILS BY E. Garnica	CHECKED		POST MILE	CMS SUPPORT DETAILS		S-1
DESIGN DETAIL SHEET (ENGLISH) (REV. 2/25/05)	QUANTITIES BY	CHECKED	CU EA TBD (BATA-0006)	0.70	REVISION DATES (PRELIMINARY STAGE ONLY)		SHEET OF
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*C. M.*  
REGISTERED CIVIL ENGINEER 3/12/10 DATE


PLANS APPROVAL DATE

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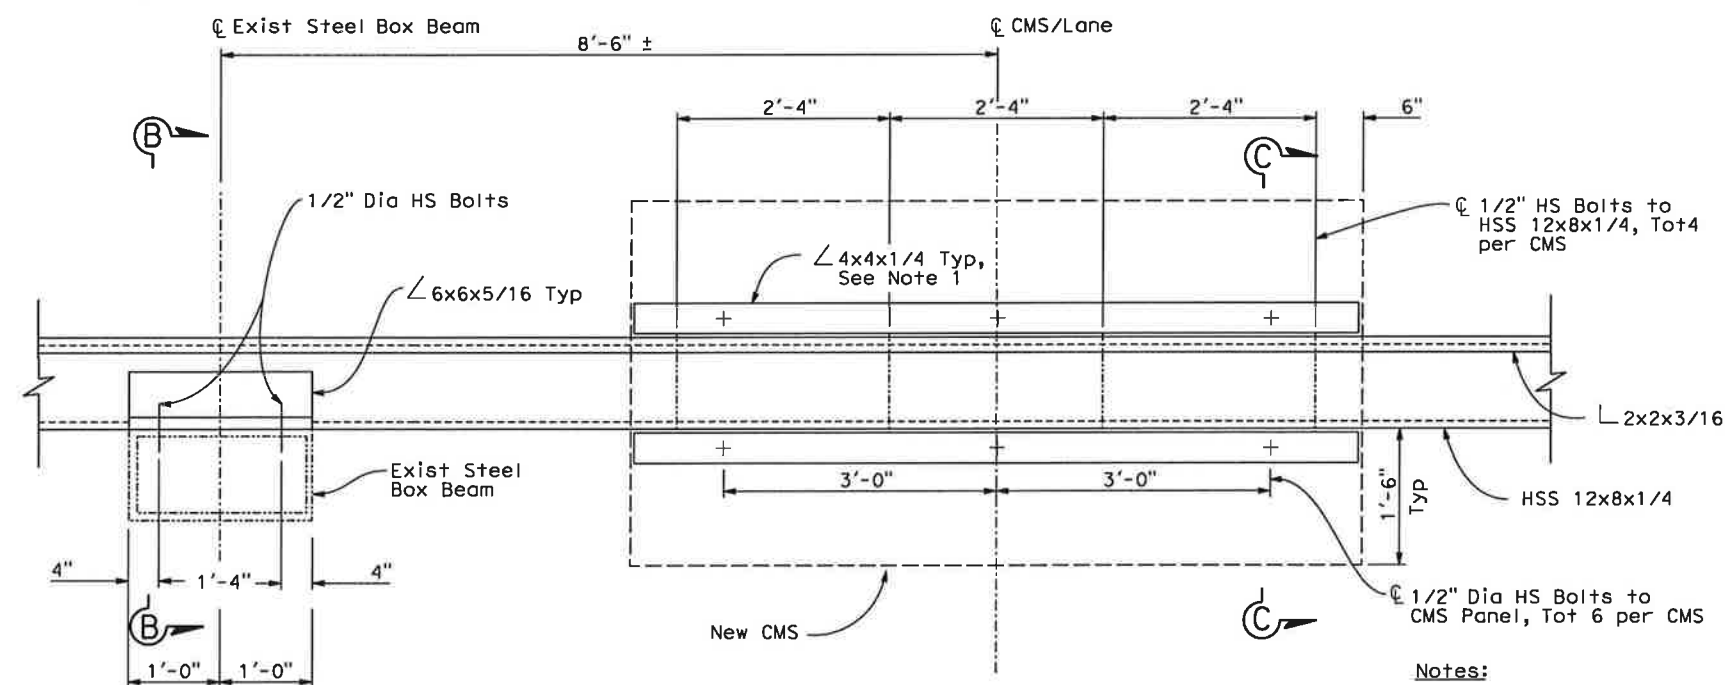
BAY AREA TOLL AUTHORITY  
101 EIGHT STREET  
OAKLAND, CALIFORNIA 94607

MGE ENGINEERING, INC.  
7415 GREENHAVEN DRIVE, SUITE 100  
SACRAMENTO, CALIFORNIA 95831

REGISTERED PROFESSIONAL ENGINEER  
GUOPING XU  
No. C 63977  
EXP. 09/30/10  
CIVIL  
STATE OF CALIFORNIA

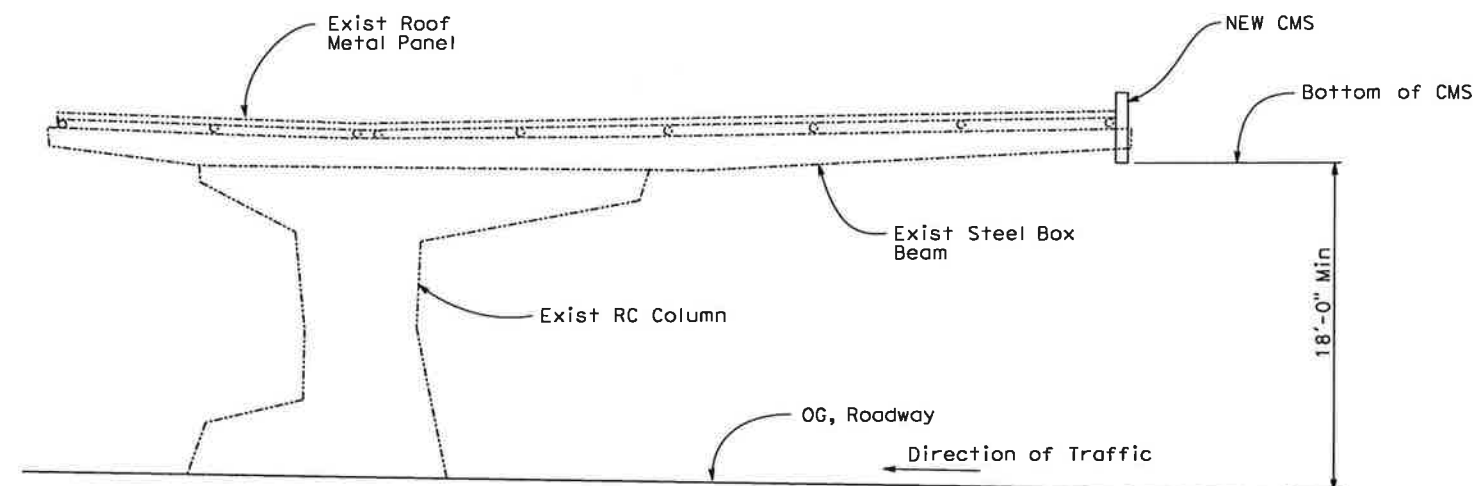

**SECTION A-A**  
NO SCALE



**PART ELEVATION**  
SCALE: 1" = 1'-0"


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- Notes:


1. Angle sections to be prefabricated and attached to CMS, and made of aluminum.
2. For access hole and cover plate details see Sheet 5-3.

Legend:

———— Indicates New Structure  
———— Indicates Exist Structure

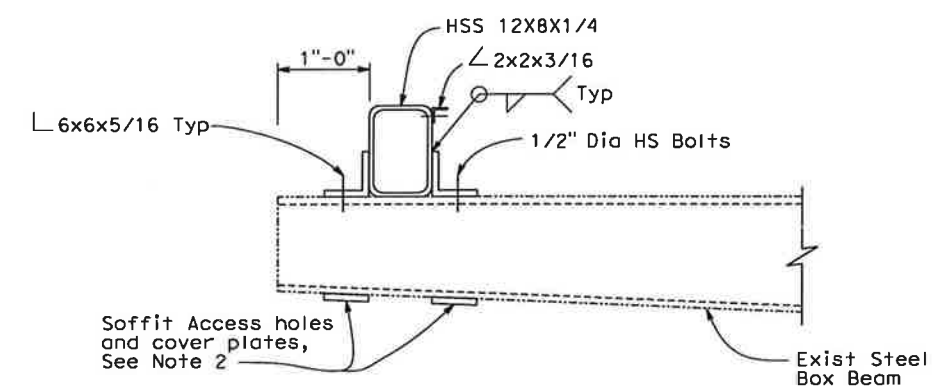

**SECTION B-B**  
SCALE: 1" = 1'-0"

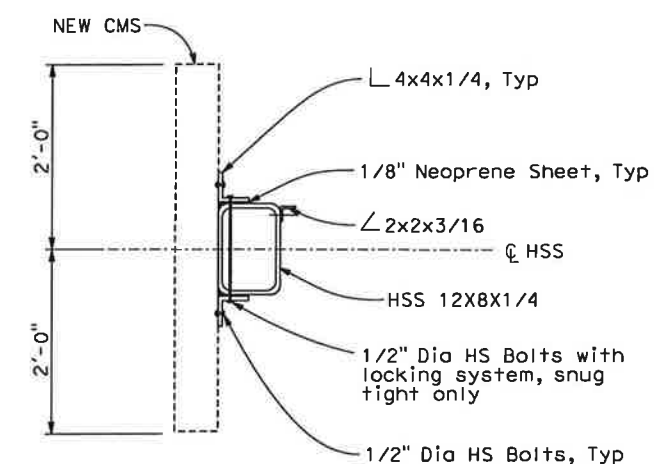

**SECTION C-C**  
SCALE: 1" = 1'-0"

**Note:**  
The Contractor shall verify all  
controlling field dimensions before  
ordering or fabricating any material.

DESIGN OVERSIGHT  SIGN OFF DATE	DESIGN	BY G. Xu	CHECKED	PREPARED FOR THE STATE OF CALIFORNIA DEPARTMENT OF TRANSPORTATION	Guoping Xu PROJECT ENGINEER	BRIDGE NO.	ANTIOCH BRIDGE TOLL PLAZA  CMS SUPPORT DETAILS	SHEET	
	DETAILS	BY E. Garnica	CHECKED			0.70		S-2	
	QUANTITIES	BY	CHECKED						
DESIGN DETAIL SHEET (ENGLISH) (REV. 2/25/05)			ORIGINAL SCALE IN INCHES FOR REDUCED PLANS	0123	CU EA TBD (BATA-0006)	DISREGARD PRINTS BEARING EARLIER REVISION DATES	REVISION DATES (PRELIMINARY STAGE ONLY)	SHEET	OF
						03/12/10		2	3

FILE => ... \02\_Antioch\Structural\S-02.dgn

[illegible]

DIST	COUNTY	ROUTE	POST MILES TOTAL PROJECT	SHEET NO	TOTAL SHEETS
04	CC	160	0.70	16	123

REGISTERED CIVIL ENGINEER

3/12/10

DATE

GUOPING XU

No. C 63977

EXP. 09/30/10

CIVIL

STATE OF CALIFORNIA

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BAY AREA TOLL AUTHORITY


101 EIGHT STREET

OAKLAND, CALIFORNIA 94607


MGE ENGINEERING, INC.

7415 GREENHAVEN DRIVE, SUITE 100

SACRAMENTO, CALIFORNIA 95831

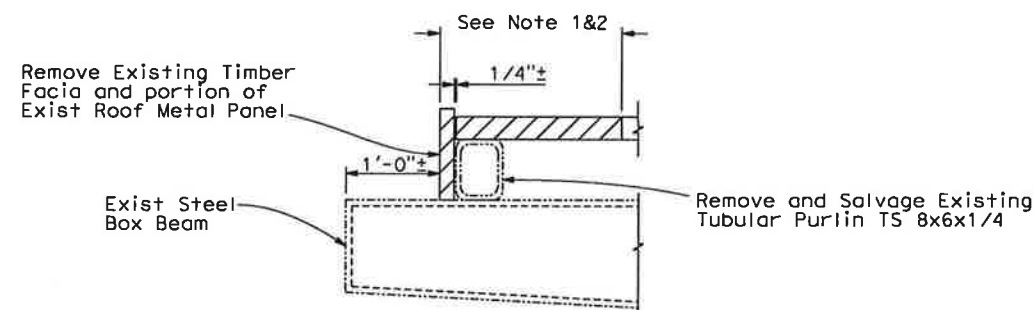


## EXISTING CONDITION

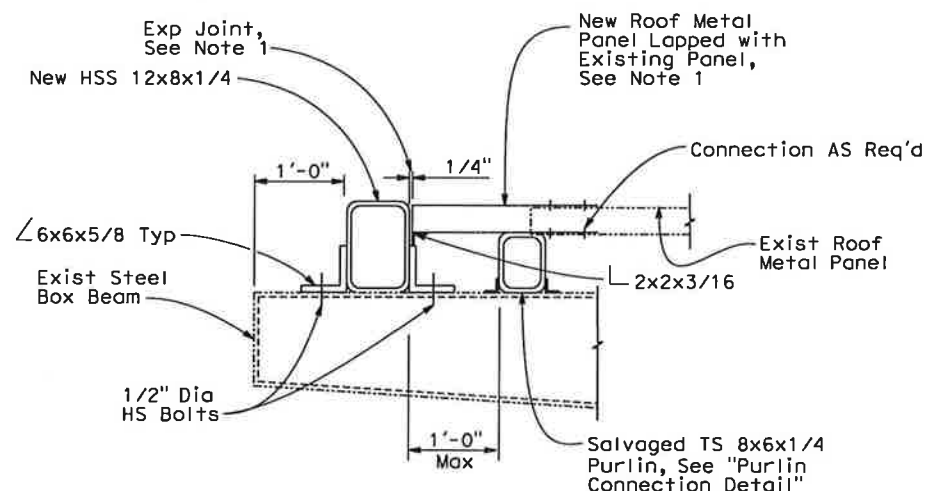

## PROPOSED CONDITION

### DETAIL 1


SCALE: 1" = 1'-0"

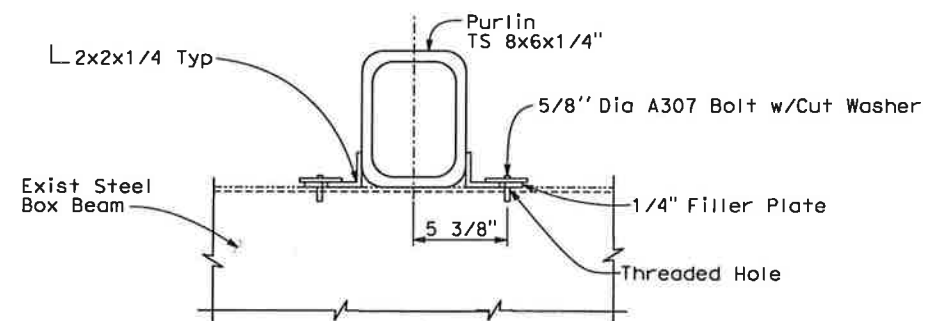

### PURLIN CONNECTION DETAIL


SCALE: 1/2" = 1'-0"

Note:  
The Contractor shall verify all controlling field dimensions before ordering or fabricating any material.

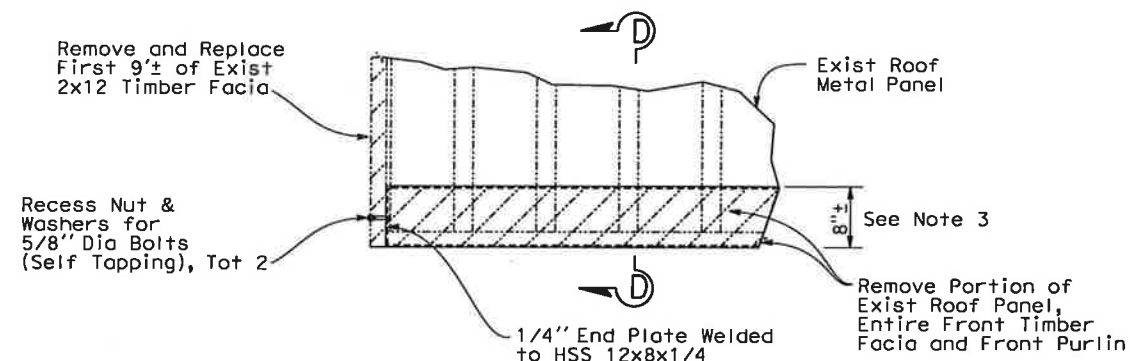


### DETAIL 2

SCALE: 1" = 1'-0"

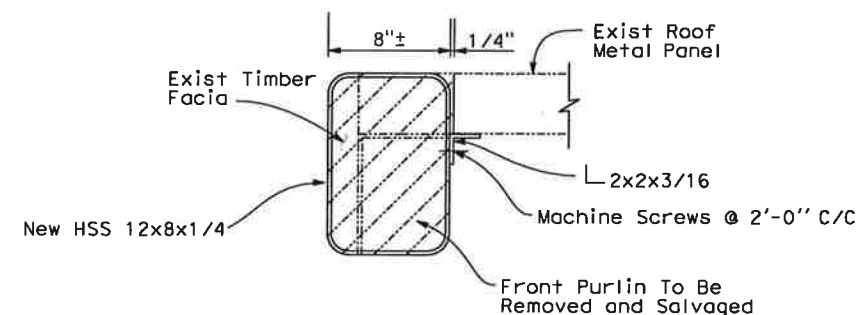

### SECTION D-D

SCALE: 1/2" = 1'-0"

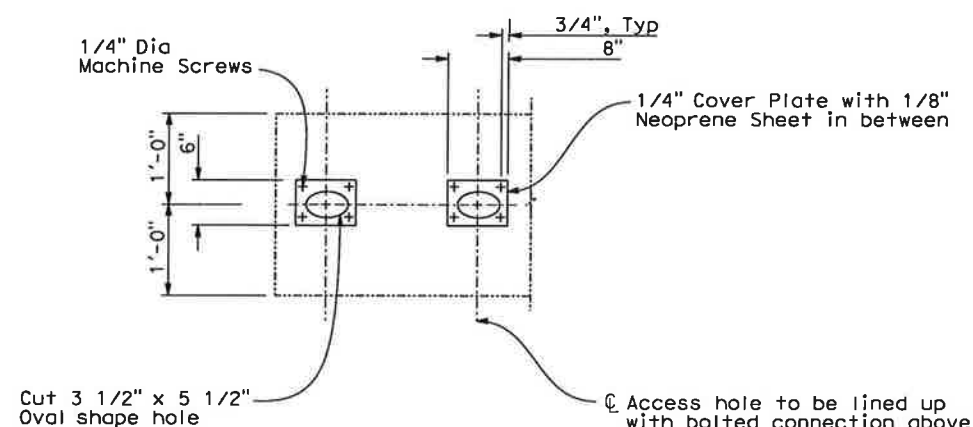

### SOFFIT ACCESS HOLE AND COVER PLATE DETAIL

SCALE: 1" = 1'-0"

#### Notes:

- Remove Portion of Existing Roof Metal Panels as Required to Provide Access for New CMS Support Connection. The Roof Panels Shall be Restored in Kind With Water Proof Membrane at Joints and Connections.
- Exist metal roof panel consists of 18 G.A. Min S=0.736 in/ft of width, I=

#### Legend:















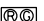


- Indicates New Structure
- Indicates Exist Structure
- Indicates removal of portion of Exist roof structure

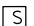DESIGN OVERSIGHT	DESIGN BY G. Xu	CHECKED	PREPARED FOR THE STATE OF CALIFORNIA DEPARTMENT OF TRANSPORTATION	BRIDGE NO.	ANTIOCH BRIDGE TOLL PLAZA	SHEET
SIGN OFF DATE	DETAILS BY E. Garnica	CHECKED	Guoping Xu PROJECT ENGINEER	POST MILE	CMS SUPPORT DETAILS	S-3
DESIGN DETAIL SHEET (ENGLISH) (REV. 2/25/05)	QUANTITIES BY	CHECKED	CU EA TBD (BATA-0006)	0.70	REVISION DATES (PRELIMINARY STAGE ONLY)	3 OF 3
ORIGINAL SCALE IN INCHES FOR REDUCED PLANS			DISREGARD PRINTS BEARING EARLIER REVISION DATES			
0 1 2 3			03/12/10			
FILE => ...02_Antioch\Structural\5-03.dgn						

GENERAL NOTES:

1. ALL WORK AND MATERIALS SHALL CONFORM TO THE LATEST VERSION OF THE CALTRANS STANDARD PLAN AND SPECIFICATIONS.
2. CALL UNDERGROUND SERVICE ALERT 48 HOURS BEFORE EXCAVATION U.S.A. (800) 277-2600.
3. ALL ELECTRICAL AND CMS EQUIPMENT, INFRASTRUCTURE, LANDSCAPING OR BUILDINGS DAMAGED BY THE CONTRACTOR'S OPERATIONS SHALL BE REPAIRED OR REPLACED AT THE CONTRACTOR'S EXPENSE.
4. ALL ELECTRICAL AND CMS EQUIPMENT INCLUDING CONDUITS, JUNCTION AND SPLICE EQUIPMENT RACK ARE SHOWN IN APPROXIMATE LOCATIONS ONLY. EXACT LOCATIONS TO BE DETERMINED IN FIELD BY ENGINEER.
5. SERVICE EQUIPMENT, AND CMS CABINET ENCLOSURES, CONTROLLER ASSEMBLIES, CMS AND OTHER ELECTRICAL EQUIPMENT ARE SHOWN IN APPROXIMATE LOCATIONS ONLY. EXACT LOCATION SHALL BE DETERMINED TO SUIT FIELD CONDITIONS AS DIRECTED BY THE ENGINEER.
6. ALL EXISTING ELECTRICAL AND COMMUNICATION EQUIPMENT SHOWN ON THE PLANS IS FOR REFERENCE AND SHALL REMAIN IN PLACE UNLESS OTHERWISE NOTED. LOCATIONS ARE APPROXIMATED. ANY DAMAGE TO THE EXISTING ELECTRICAL AND COMMUNICATION EQUIPMENT SHALL BECOME THE RESPONSIBILITY OF THE CONTRACTOR TO REPAIR AT NO ADDITIONAL COST TO BATA.
7. NEW CIRCUIT BREAKERS TO BE INSTALLED TO EXISTING PANEL BOXES SHALL MATCH THE EXISTING TYPE OR APPROVED BY THE ENGINEER AS REQUIRED.
8. ALL DIMENSIONS INDICATED ARE TO BE VERIFIED IN FIELD PRIOR TO COMMENCING WORK.
9. THE CONTRACTOR SHALL IDENTIFY AND VERIFY ALL EXISTING UTILITIES, POWER SOURCES AND POWER CONSUMPTIONS AS REQUIRED OR NEEDED AS SHOWN ON THE PLANS PRIOR TO COMMENCING WORK.
10. SEE STRUCTURAL PLANS FOR EXACT LOCATION OF CMS STRUCTURES, FRAMES AND MOUNTING BRACKETS.
11. ALL ABOVE GROUND CONDUIT SHALL BE SUPPORTED AT A MINIMUM OF EVERY 5 FEET.
12. ALL ELECTRICAL ITEMS THAT USE ANCHORS TO ATTACH TO THE CONCRETE STRUCTURES SHALL USE STAINLESS STEEL POWER STUD ANCHORS-THREADED VERSION SIZED PER MANUFACTURER RECOMMENDATION AND EPOXY ANCHOR HOLES USING SEALANT WITH A RATED LIFE OF 25 YEARS OR GREATER.
13. ALL ELECTRICAL WORK SHALL MEET ALL REQUIREMENTS OF THE LATEST EDITIONS OF THE CEC, NEC & NATIONAL ELECTRICAL SAFETY CODE. ALL COMPONENTS SHALL BE PROPERLY GROUNDED AND BONDED PER NEC REQUIREMENTS. ALL COMPONENTS INCLUDING CONDUITS JUNCTION BOXES, CABLING, EQUIPMENT, AND CABINETS SHALL BE CLEARLY LABELED WITH PROPER TAGS, NAME PLATES, AND I.D. LABELS.
14. CONTRACTOR SHALL USE TYPE 1 CONDUIT IN TUNNEL AND TRENCH, TYPE 2 CONDUIT FOR EXPOSED CONDITIONS AND TYPE 4 FLEXIBLE CONDUIT AS SHOWN ON PLANS.
15. ALL EXTERIOR PULL BOXES AND JUNCTION BOXES SHALL BE NEMA 4X.
16. ALL ELECTRICAL AND EXTERIOR CONNECTIONS SHALL BE WEATHERPROOF.
17. CONTRACTOR SHALL BE RESPONSIBLE FOR FIELD VERIFYING ANY EXISTING CONDUIT AND/OR JUNCTION BOXES TO BE USED ON THIS CONTRACT PRIOR TO PULLING NEW CABLE THROUGH. ANY DAMAGE TO NEW OR EXISTING CABLE SHALL BE THE RESPONSIBILITY OF THE CONTRACTOR TO REPAIR AT NO ADDITIONAL COST TO BATA.

LEGEND:

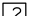- |   |                                 |   |  |
|---|---------------------------------|---|--|
|  | CHANGEABLE MESSAGE SIGN         |  | TERMINAL BLOCK                           |
| ----  | EXISTING CONDUIT                | —FO—  | NEW FIBER OPTIC CABLE                    |
| — — —   | EXISTING CONDUIT WITH NEW CABLE |  | EXISTING TRAFFIC SIGNAL INDICATOR        |
| ————  | NEW CONDUIT                     |  | QUAD RECEPTICAL                          |
|  | JUNCTION BOX                    |  | DUPLEX RECEPTICAL                        |
|  | EXISTING JUNCTION BOX           |  | NEW INDICATOR LIGHT SWITCH CONSOLE PANEL |
|  | NEW CMS CABINET                 |  | RISER CONDUITS                           |
|  | CONDUIT IN                      |  | DROP CONDUITS                            |
|  | CONDUIT OUT                     |  | NEW LED INDICATOR BOX                    |
|  | LANE X TO LANE Y CABLES         |  | NEW CMS WORKSTATION                      |
|   |                                 |  | NEW TYPE 2 EQUIPMENT RACK                |





ABBREVIATIONS:

- |                |  |
|----------------|--|
| AM             | AMBER  |
| BK             | BLACK  |
| BL             | BLUE   |
| BN             | BROWN  |
| C              | CONDUIT  |
| CAB            | CABINET  |
| CEC            | CALIFORNIA ELECTRICAL CODE                     |
| CMS            | CHANGEABLE MESSAGE SIGN                        |
| COMM           | COMMUNICATIONS                                 |
| CPB            | COMMUNICATIONS PULL BOX                        |
| CKT            | CIRCUIT  |
| E              | EXISTING                                       |
| ETC            | ELECTRONIC TOLL COLLECTION                     |
| FDU            | FIBER DISTRIBUTION UNIT                        |
| FO             | FIBER OPTIC                                    |
| GFI            | GROUND FAULT INTERRUPT                         |
| GN             | GREEN  |
| ILB            | INDICATOR LIGHT BOOTH                          |
| ILC            | INDICATOR LIGHT CANOPY                         |
| ILP            | INDICATOR LIGHT PANEL                          |
| J-BOX          | JUNCTION BOX                                   |
| JB             | JUNCTION BOX                                   |
| KVA            | KILO-VOLT AMPERE                               |
| LCD            | LIQUID CRYSTAL DISPLAY                         |
| LED            | LIGHT EMITTING DIODE                           |
| MLO            | MAIN LUG ONLY                                  |
| NEC            | NATIONAL ELECTRICAL CODE                       |
| N              | NEUTRAL (GROUNDED CONDUCTOR)                   |
| ORT            | OPEN ROAD TOLLING                              |
| PB             | CEILING/WALL MOUNTED PULL BOX                  |
| PCC            | PORTLAND CEMENT CONCRETE                       |
| PNL            | PANEL  |
| PVC            | POLYVINYL CHLORIDE CONDUIT                     |
| PWR            | POWER  |
| RMC            | RIGID METAL CONDUIT                            |
| R#             | RELAY (# = RELAY NUMBER)                       |
| RD             | RED  |
| SS             | STAINLESS STEEL                                |
| TEES           | TRANSPORTATION ELECTRICAL EQUIPMENT            |
| SM             | SINGLE MODE                                    |
| TB             | TERMINAL BLOCKS                                |
| TVSS           | TRANSIENT VOLTAGE SURGE SUPPRESSOR             |
| TYPE A CABLE   | 36 SINGLE MODE FIBER OPTIC CABLE               |
| TYPE D CABLE   | 12 SINGLE MODE FIBER OPTIC CABLE               |
| TYPE 1 CONDUIT | GALVANIZED RIGID STEEL (GRS)                   |
| TYPE 2 CONDUIT | TYPE 1 CONDUIT COATED WITH PVC OR POLYETHYLENE |
| TYPE 4 CONDUIT | LIQUIDTIGHT FLEXIBLE METAL CONDUIT             |
| UPS            | UNINTERRUPTIBLE POWER SUPPLY                   |
| XFMR           | TRANSFORMER                                    |
| YL             | YELLOW   |

STANDARD NOTES:



- |    |   |
|----|---|
| BC | INSTALL PULL BOX IN EXISTING CONDUIT RUN. |
| CB | INSTALL CONDUIT INTO EXISTING PULL BOX.   |
| SC | SPLICE NEW TO EXISTING CONDUCTORS.        |
| AB | ABANDONED                                 |
| RD | REMOVE AND DISPOSE                        |
| RS | REMOVE AND SALVAGE                        |

WIRING DIAGRAM LEGEND:

- |  |   |
|--|---|
| CB CIRCUIT BREAKER   |  GROUNDING ELECTRODE |
| NB NEUTRAL BUS   |   |
| GB GROUND BUS  |  CIRCUIT BREAKER     |
|  ENCLOSURE BOND |  RECEPTACLE          |

INDEX:

- E-1 GENERAL NOTES, LEGEND, ABBREVIATIONS AND INDEX OF DRAWINGS
- E-2 PROJECT NOTES
- E-3 TOLL PLAZA OPERATIONS BUILDING PARTIAL MAIN FLOOR PLAN  
CONDUIT ROUTING
- E-4 TOLL PLAZA OPERATIONS BUILDING LOWER LEVEL CONDUIT ROUTING
- E-5 TOLL PLAZA OPERATIONS BUILDING TUNNEL TO CANOPY CONDUIT  
ROUTING
- E-6 TOLL PLAZA OPERATIONS BUILDING CONDUIT ROUTING DETAILS
- E-7 CMS PLAZA CABINET ELEVATION VIEW FOR LANES 1-3
- E-8 CMS SYSTEM CENTRAL CONTROL SCHEMATIC
- E-9 CMS PLAZA CABINET WIRING SCHEMATIC
- E-10 TYPE D CABLE FIBER ASSIGNMENT
- E-11 PARTIAL ONE LINE DIAGRAM AND PANEL BOARD SCHEDULE
- E-12 INDICATOR LIGHT SWITCH CONSOLE PANEL AND TOLL BOOTH INDICATOR  
SWITCH BOX.
- E-13 INDICATOR LIGHT WIRING DIAGRAM FOR LANES 1-3
- E-14 JUNCTION BOX DETAILS
- E-15 CONDUIT MOUNTING AND ATTACHMENT DETAILS
- E-16 INDICATOR LIGHT CABINET DRAWER LAYOUT.

Dist	COUNTY	ROUTE	POST MILES TOTAL PROJECT	SHEET No.	TOTAL SHEETS
04	CC	160	0.70	17	123
 REGISTERED CIVIL ENGINEER			3/12/10 DATE		
PLANS APPROVAL DATE _____					
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# GENERAL NOTES, LEGEND, ABBREVIATIONS AND INDEX OF DRAWINGS (ANTIOCH BRIDGE)



**E-1**

SHEET	OF
1	16

PROJECT NOTES:

- 1 INSTALL NEW TYPE D CABLE IN EXISTING CONDUIT.
- 2 INSTALL NEW TYPE D CABLE.
- 3 INSTALL NEW TYPE 1 ( $\frac{3}{4}$ " C) CONDUIT WITH 2 #14 AND 1 #14G (120 V, CMS CABINET).
- 4 INSTALL ONE 15A, 1P, 120V CIRCUIT BREAKER FOR NEW CMS CABINET IN (E)SPACE #10.
- 5 INSTALL NEW THREE(3)15A-1P CIRCUIT BREAKERS (120 V, CMS SIGN) IN (E) SPACES 12,14, AND 16).
- 6 INSTALL TYPE 1 ( $1\frac{1}{2}$ " C) CONDUIT WITH 6 #12 AND 3 #12G (120 V, CMS SIGNS).
- 7 INSTALL TYPE 4 ( $1\frac{1}{2}$ " C) CONDUIT WITH 6 #12 AND 3 #12G (120 V, CMS SIGNS).  
ROUTE CONDUIT IN (E) CABLE TRAY TOGETHER WITH (E) POWER CABLES.
- 8 ROUTE TYPE 1 ( $1\frac{1}{2}$ " C) CONDUIT WITH 6 #12 AND 3 #12G TO (E) CANOPY (CORE DRILL IS REQUIRED).  
SEAL AROUND CONDUIT PENETRATION WITH FAST-SETTING EPOXY RESIN THROUGH THE DEPTH OF HOLE.
- 9 INSTALL NEW CAT-5e CABLE.
- 10 ALL WALL, CEILING AND FLOOR PENETRATIONS SHALL BE CORE-DRILLED AS DIRECTED  
AND APPROVED BY CALTRANS SUFFICIENTLY LARGE TO ACCOMMODATE CONDUIT PLUS FLUSH  
MOUNTED END BELL. ALL CORE-DRILLS SHALL BE MADE WATER-TIGHT, SEALED AROUND  
CONDUIT PER CALTRANS REQUIREMENTS WITH FAST-SETTING EPOXY RESIN THROUGHOUT  
THE DEPTH OF HOLE.
- 11 INSTALL NEW INDICATOR LIGHT CANOPY CABLE.
- 12 INSTALL NEW INDICATOR LIGHT BOOTH CABLE.
- 13 INSTALL NEW INDICATOR LIGHT CONSOLE CABLE.
- 14 INSTALL NEW CMS COMM CABLE.
- 15 INSTALL TYPE 3 JUNCTION BOX AS SPECIFIED IN CONTRACT DOCUMENTS.
- 16 INSTALL NEW TYPE 2 EQUIPMENT RACK. SEE SHEET E-3 AND SPECIFICATIONS FOR SIZE AND TYPE.
- 17 INSTALL NEW TYPE 4 ( $1\frac{1}{2}$ " C) CONDUIT.
- 18 INSTALL NEW FIBER OPTIC DUPLEX JUMPER CABLES.
- 19 INSTALL NEW FDU AS SPECIFIED IN CONTRACT DOCUMENT.
- 20 REMOVE AND DISPOSE OF EXISTING INDICATOR LIGHT CABLE.
- 21 INSTALL NEW CMS PANEL AS SPECIFIED IN CONTRACT DOCUMENTS.
- 22 INSTALL NEW CMS WORKSTATION AS SPECIFIED IN CONTRACT DOCUMENTS.
- 23 ROUTE NEW CABLES THROUGH EXISTING CONDUIT.
- 24 MODIFY EXISTING GREEN INDICATOR LIGHT AND REPLACE WITH GREEN/FLASHING AMBER  
LED INDICATOR BULB. REPLACE EXISTING RED INDICATOR LIGHT WITH RED LED INDICATOR  
BULB. IF EXISTING RED INDICATOR LIGHT IS LED, FURNISH NEW RED LED INDICATOR BULB  
TO BATA AS A SPARE.
- 25 INSTALL NEW TYPE 2 ( $1\frac{1}{2}$ " C) CONDUIT.

- 26) INSTALL NEW CMS PLAZA CABINET FOR LANES 1-3 AS SPECIFIED IN CONTRACT DOCUMENTS.
- 27) ROUTE NEW CMS COMM CABLE THROUGH EXISTING JUNCTION BOX.
- 28) NOT USED
- 29) INSTALL INDICATOR LIGHT SWITCH CONSOLE PANEL.
- 30) REMOVE EXISTING INDICATOR LIGHT SWITCH IN TOLL BOOTH.
- 31) INSTALL NEW CMS CONTROLLERS. ROUTE CAT-5E PATCH CABLES FROM EACH CMS CONTROLLER TO NEW ETHERNET SWITCH IN EXISTING CMS CABINET.
- 32) INSTALL NEW TYPE 1 (2" C) CONDUIT.
- 33) INSTALL NEW TYPE 2 (2" C) CONDUIT.
- 34) INSTALL TYPE 1 JUNCTION BOX AS SPECIFIED IN CONTRACT DOCUMENTS.
- 35) INSTALL NEW TYPE 1 (1½" C) CONDUIT.
- 36) INSTALL NEW 4"x4"x4" JUNCTION BOX
- 37) INSTALL INDICATOR LIGHT RELAYS AND TYPE 2 JUNCTION BOX AS SPECIFIED IN CONTRACT DOCUMENTS.
- 38) INSTALL NEW TYPE 4 (2" C) CONDUIT
- 39) INSTALL AND TERMINATE INDICATOR LIGHT CABLES TO NEW TERMINAL BLOCKS AND WIRE TO SWITCH PANEL AS SHOWN IN PLANS AND APPROVED BY THE ENGINEER.
- 40) INSTALL LB FITTING.
- 41) INSTALL NEW LED PUSH BUTTON INDICATOR BOX.
- 42) PROVIDE NEW REVISED (TYPED WRITTEN) PANEL SCHEDULE.
- 43) INSTALL NEW TYPE 4 (1½" C) CONDUIT.

Dist	COUNTY	ROUTE	POST MILES TOTAL PROJECT	SHEET No.	TOTAL SHEETS
04	CC	160	0.70	18	123
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PLANS APPROVAL DATE _____					
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## PROJECT NOTES (ANTIOCH BRIDGE)

**E - 2**

SHEET	OF
2	16

LAST REVISION  
00-00-00

DATE PLOTTED => \$DATE  
TIME PLOTTED => \$TIME



x

x

x

x

x

\$REQUEST

STATE OF CALIFORNIA - DEPARTMENT OF TRANSPORTATION

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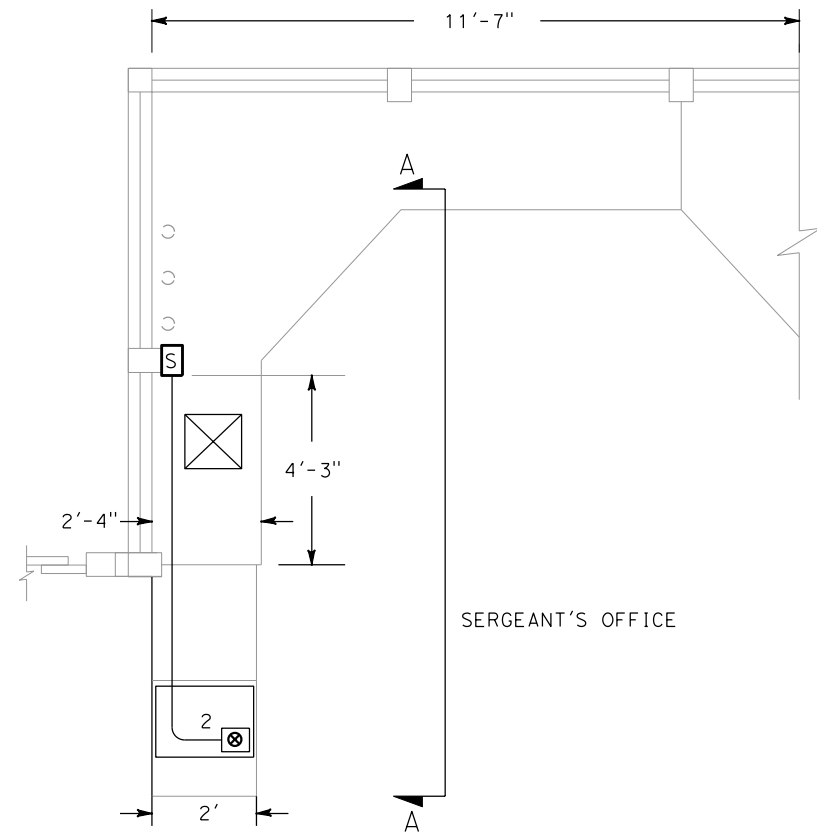
REVISED BY

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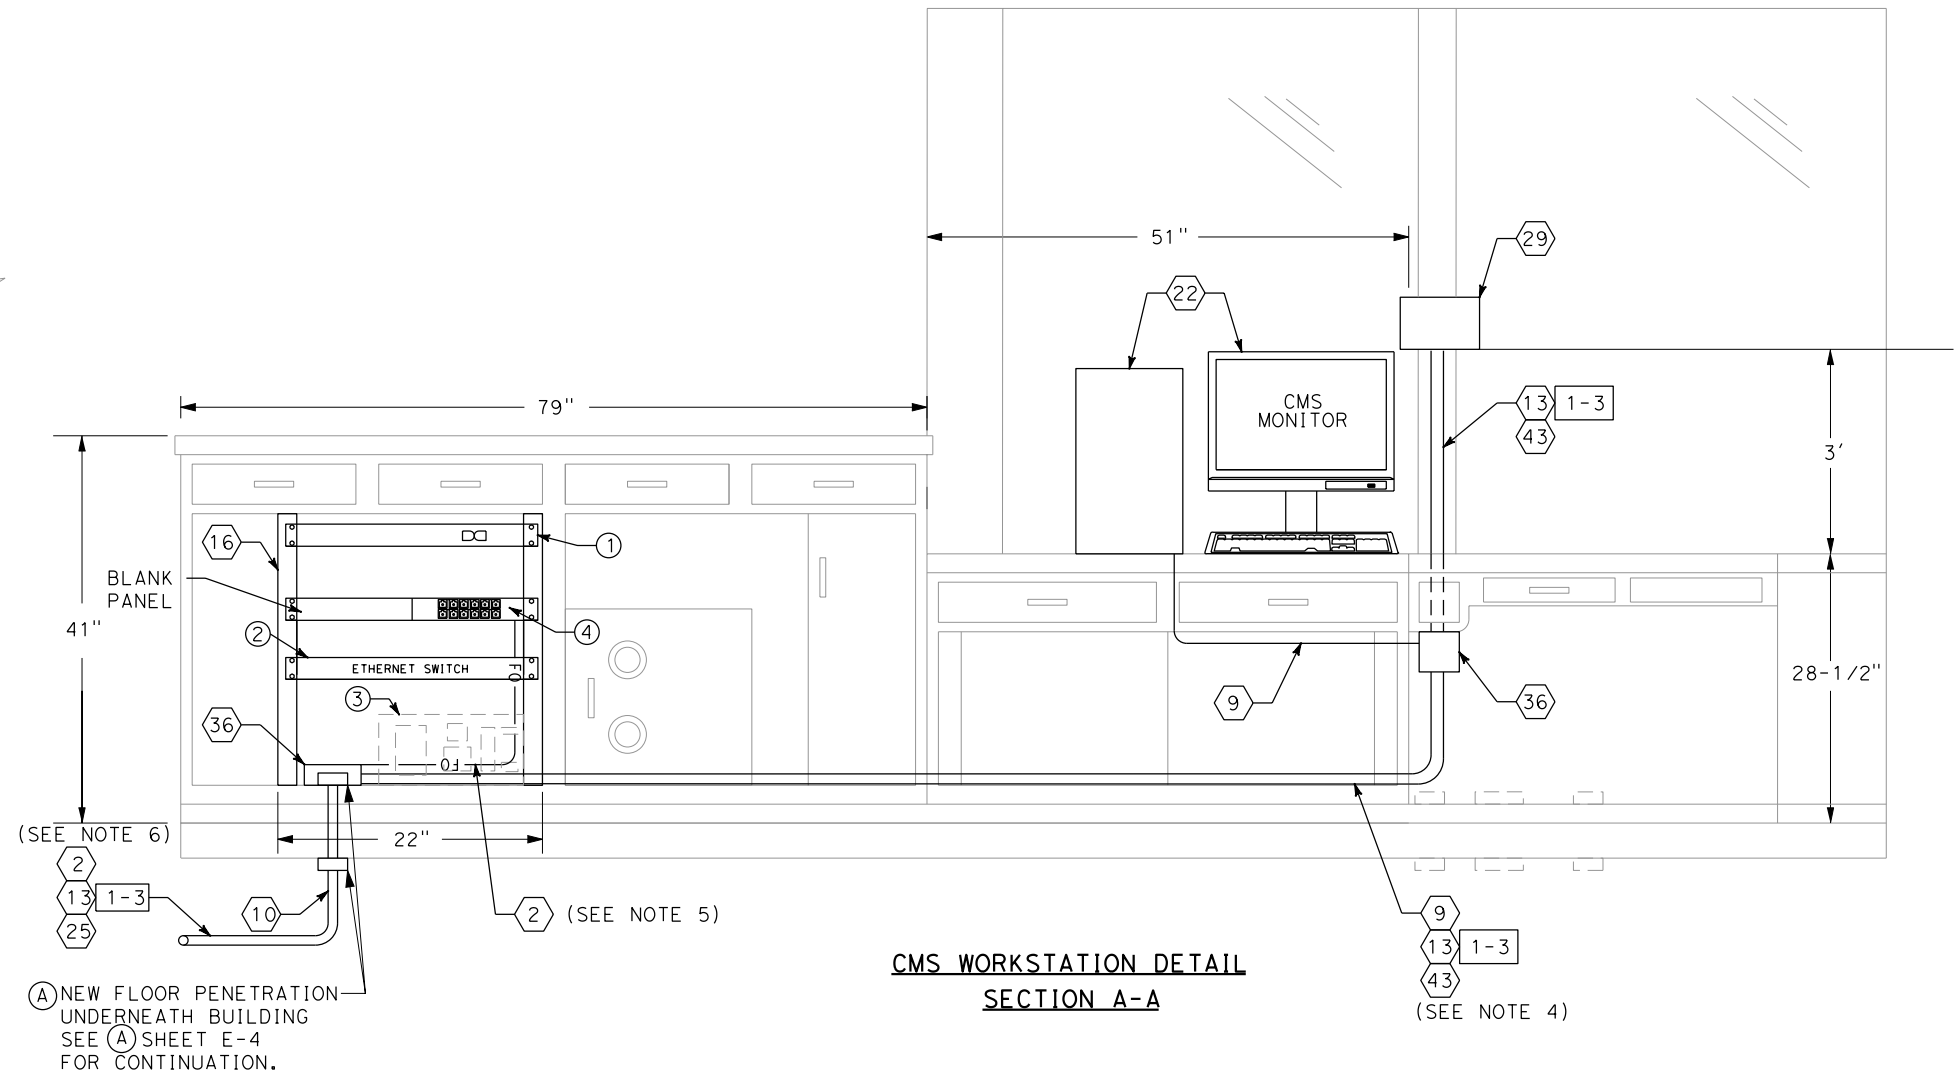
SHEET NOTES:

1. ANY EXISTING FURNITURE REQUIRED TO BE RE-ARRANGED FOR PLACEMENT OF CMS WORKSTATION AND INDICATOR LIGHT SWITCH CONSOLE PANEL SHALL BE COORDINATED WITH TOLL SERGEANT.
2. INDICATOR LIGHT SWITCH CONSOLE PANEL TO BE MOUNTED VERTICALLY TO EXISTING COLUMN.
3. SEE SHEET E-8 FOR CMS SYSTEM CONTROL SCHEMATIC AND SHEET E-12 FOR INDICATOR LIGHT SWITCH CONSOLE PANEL.
4. CONTRACTOR TO ROUTE ALL CABLES TO CMS WORKSTATION AND INDICATOR LIGHT SWITCH CONSOLE PANEL. SECURE ALL CONDUIT TO WALL WITH FITTINGS AND FASTENERS.
5. CONTRACTOR TO INSTALL CABLE SUPPORT SYSTEM TO NEATLY DRESS AND SECURE CABLE TO EQUIPMENT RACK.
6. CONTRACTOR TO ROUTE NEW CONDUIT UNDER BUILDING USING EXISTING CONDUIT SUPPORT SYSTEM.



MAIN FLOOR - PARTIAL FLOOR PLAN VIEW

ITEM	COMPONENT
①	NEW RACK MOUNTABLE IP ADDRESSABLE POWER STRIP
②	NEW RACK MOUNTABLE ETHERNET SWITCH WITH MINIMUM 14-PORTS AND 2 FIBER PORTS
③	(E) RACK AND (E) 170 CONTROLLER TO BE REMOVED
④	NEW PATCH PANEL




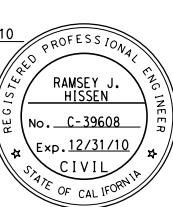
CMS WORKSTATION DETAIL  
SECTION A-A


TOLL PLAZA OPERATIONS BUILDING  
PARTIAL MAIN FLOOR PLAN  
CONDUIT ROUTING  
(ANTIOCH BRIDGE)

NO SCALE


E-3


SHEET	OF
3	16

DIST	COUNTY	ROUTE	POST MILES TOTAL PROJECT	SHEET NO.	TOTAL SHEETS
04	CC	160	0.70	19	123
 REGISTERED CIVIL ENGINEER			3/12/10 DATE		
PLANS APPROVAL DATE					
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04	CC	160	0.70	20	123

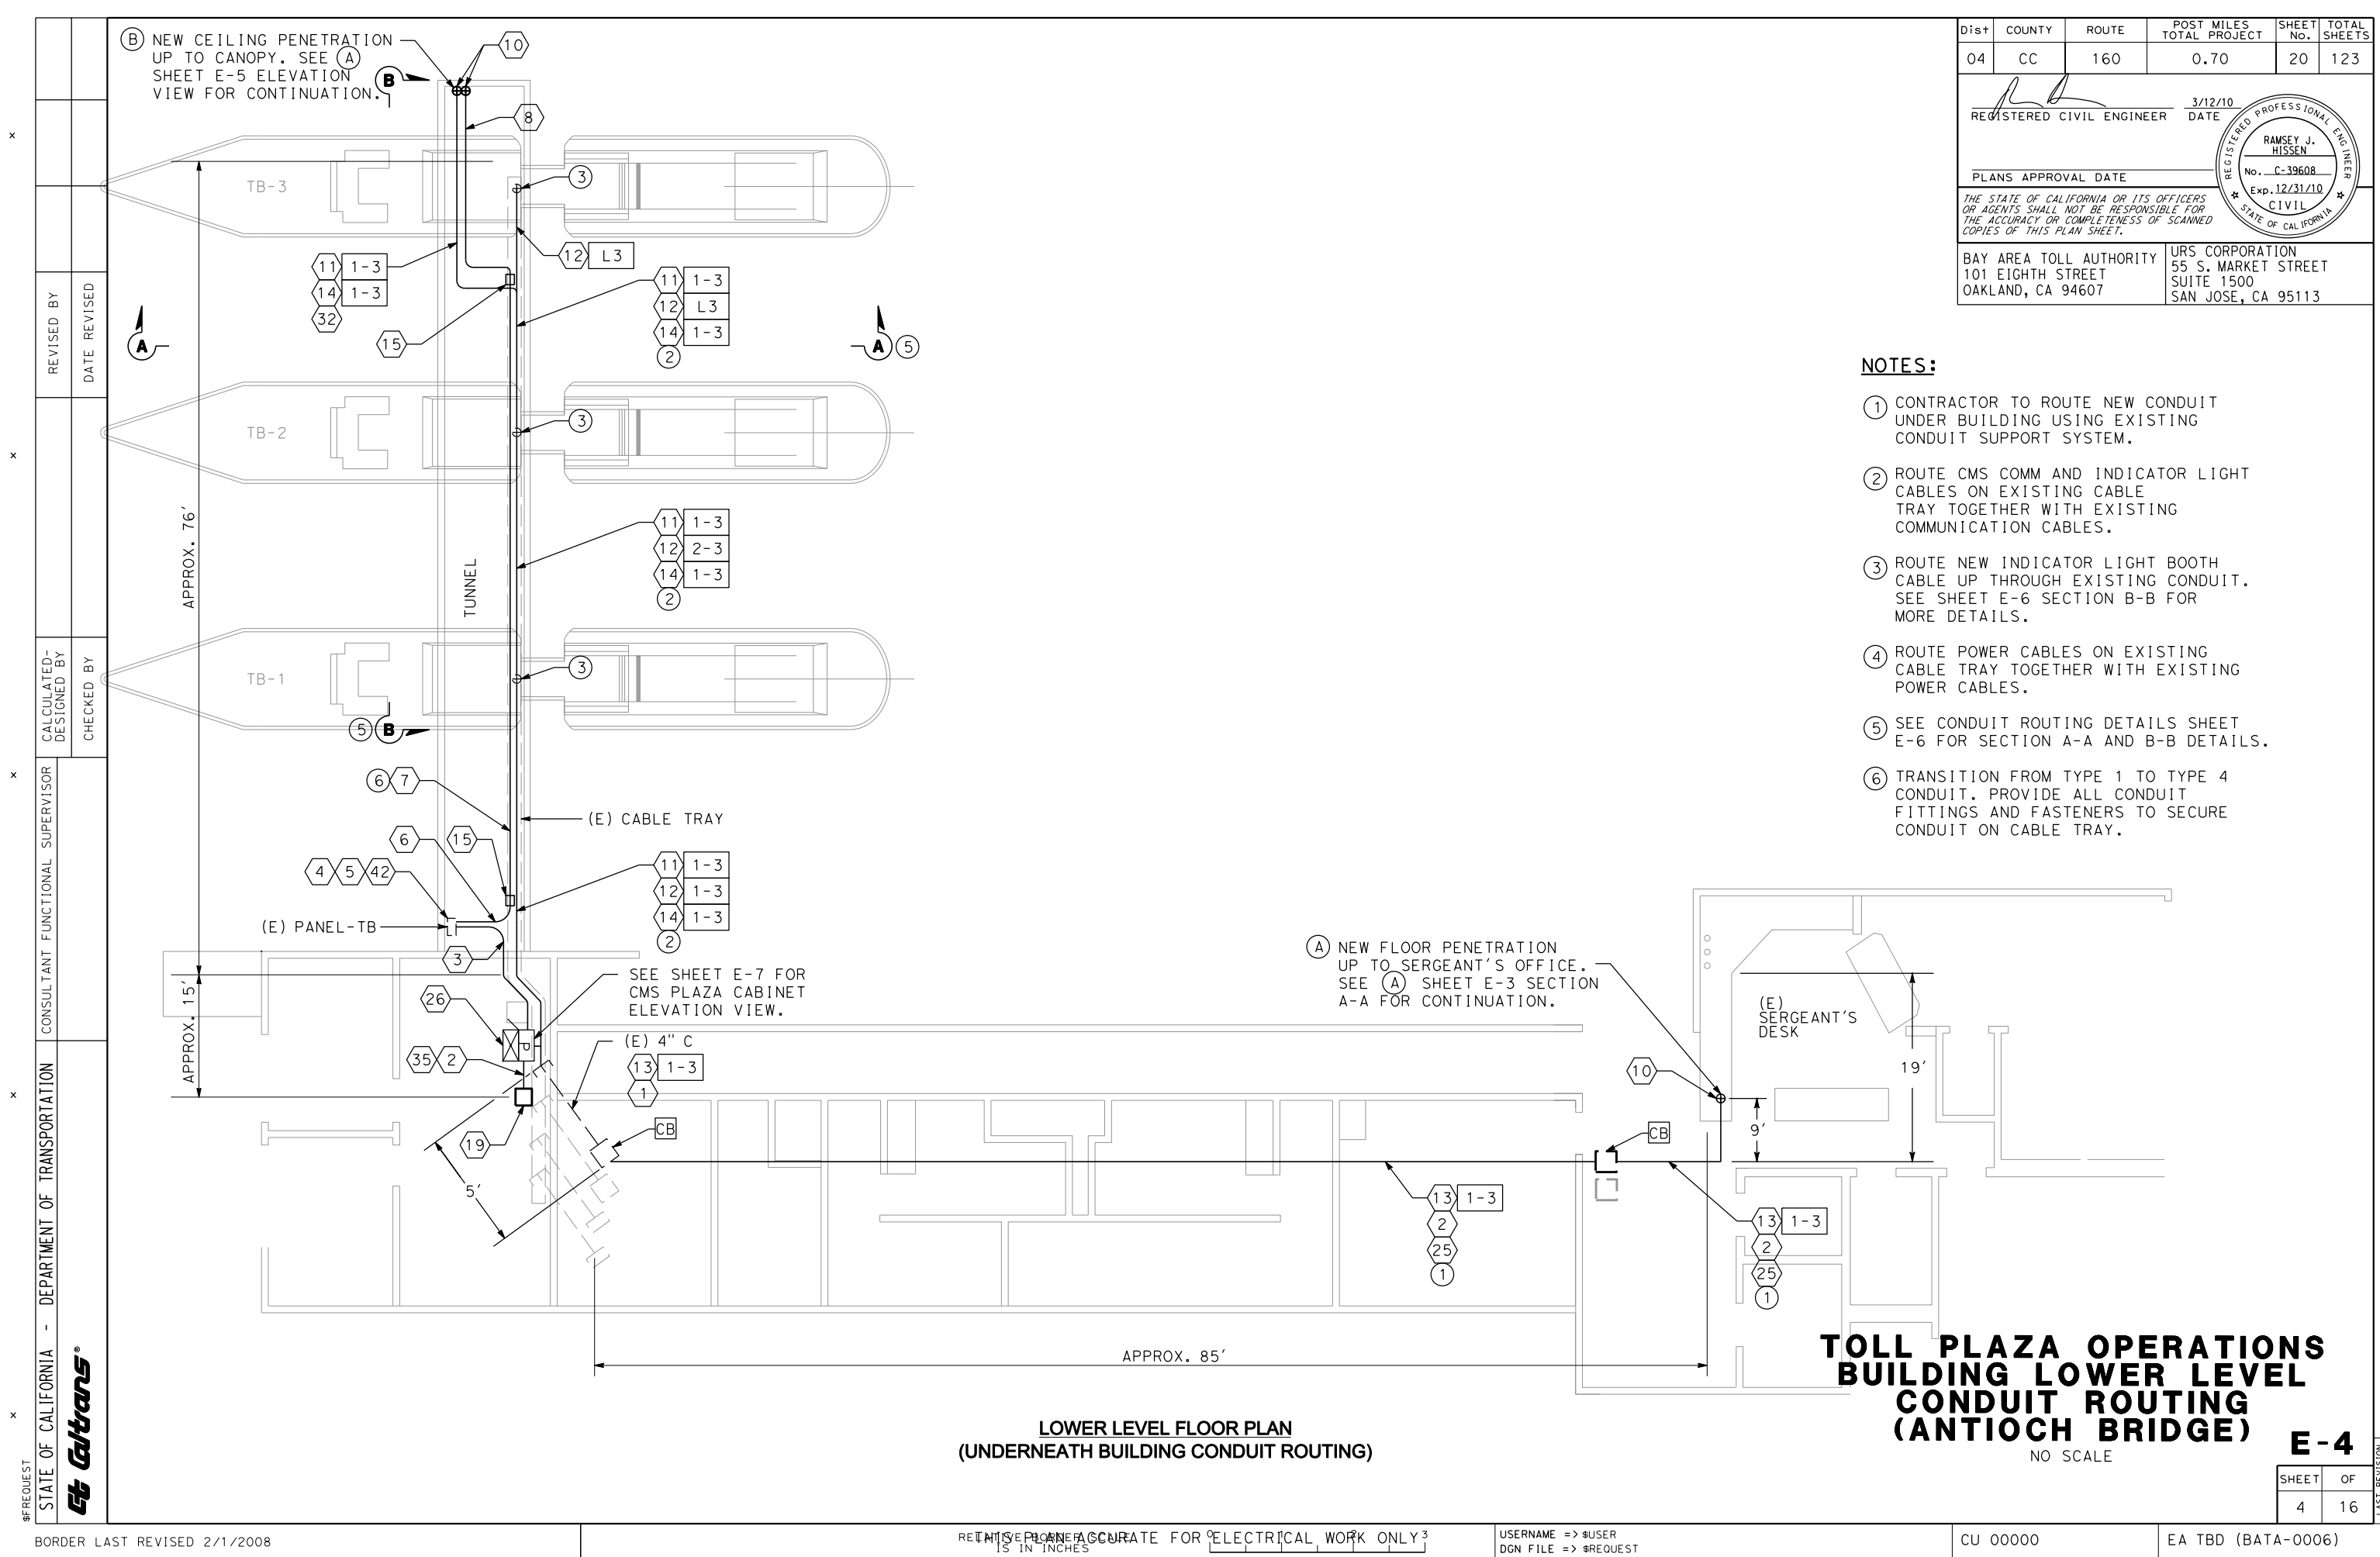  
REGISTERED CIVIL ENGINEER  
DATE 3/12/10



PLANS APPROVAL DATE \_\_\_\_\_
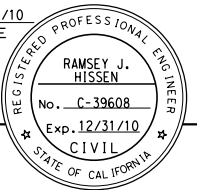
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
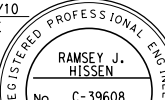
- NOTES:**
- ① CONTRACTOR TO ROUTE NEW CONDUIT UNDER BUILDING USING EXISTING CONDUIT SUPPORT SYSTEM.
  - ② ROUTE CMS COMM AND INDICATOR LIGHT CABLES ON EXISTING CABLE TRAY TOGETHER WITH EXISTING COMMUNICATION CABLES.
  - ③ ROUTE NEW INDICATOR LIGHT BOOTH CABLE UP THROUGH EXISTING CONDUIT. SEE SHEET E-6 SECTION B-B FOR MORE DETAILS.
  - ④ ROUTE POWER CABLES ON EXISTING CABLE TRAY TOGETHER WITH EXISTING POWER CABLES.
  - ⑤ SEE CONDUIT ROUTING DETAILS SHEET E-6 FOR SECTION A-A AND B-B DETAILS.
  - ⑥ TRANSITION FROM TYPE 1 TO TYPE 4 CONDUIT. PROVIDE ALL CONDUIT FITTINGS AND FASTENERS TO SECURE CONDUIT ON CABLE TRAY.



**TOLL PLAZA OPERATIONS  
BUILDING LOWER LEVEL  
CONDUIT ROUTING  
(ANTIOCH BRIDGE)**

NO SCALE

**E - 4**

SHEET	OF
4	16

Dist	COUNTY	ROUTE	POST MILES TOTAL PROJECT	SHEET No.	TOTAL SHEETS
04	CC	160	0.70	21	123
 REGISTERED CIVIL ENGINEER			3/12/10 DATE		
PLANS APPROVAL DATE _____					
<i>THE STATE OF CALIFORNIA OR ITS OFFICERS  OR AGENTS SHALL NOT BE RESPONSIBLE FOR  THE ACCURACY OR COMPLETENESS OF SCANNED  COPIES OF THIS PLAN SHEET.</i>					
BAY AREA TOLL AUTHORITY 101 EIGHTEEN STREET OAKLAND, CA 94607			URS CORPORATION 55 S. MARKET STREET SUITE 1500 SAN JOSE, CA 95113		

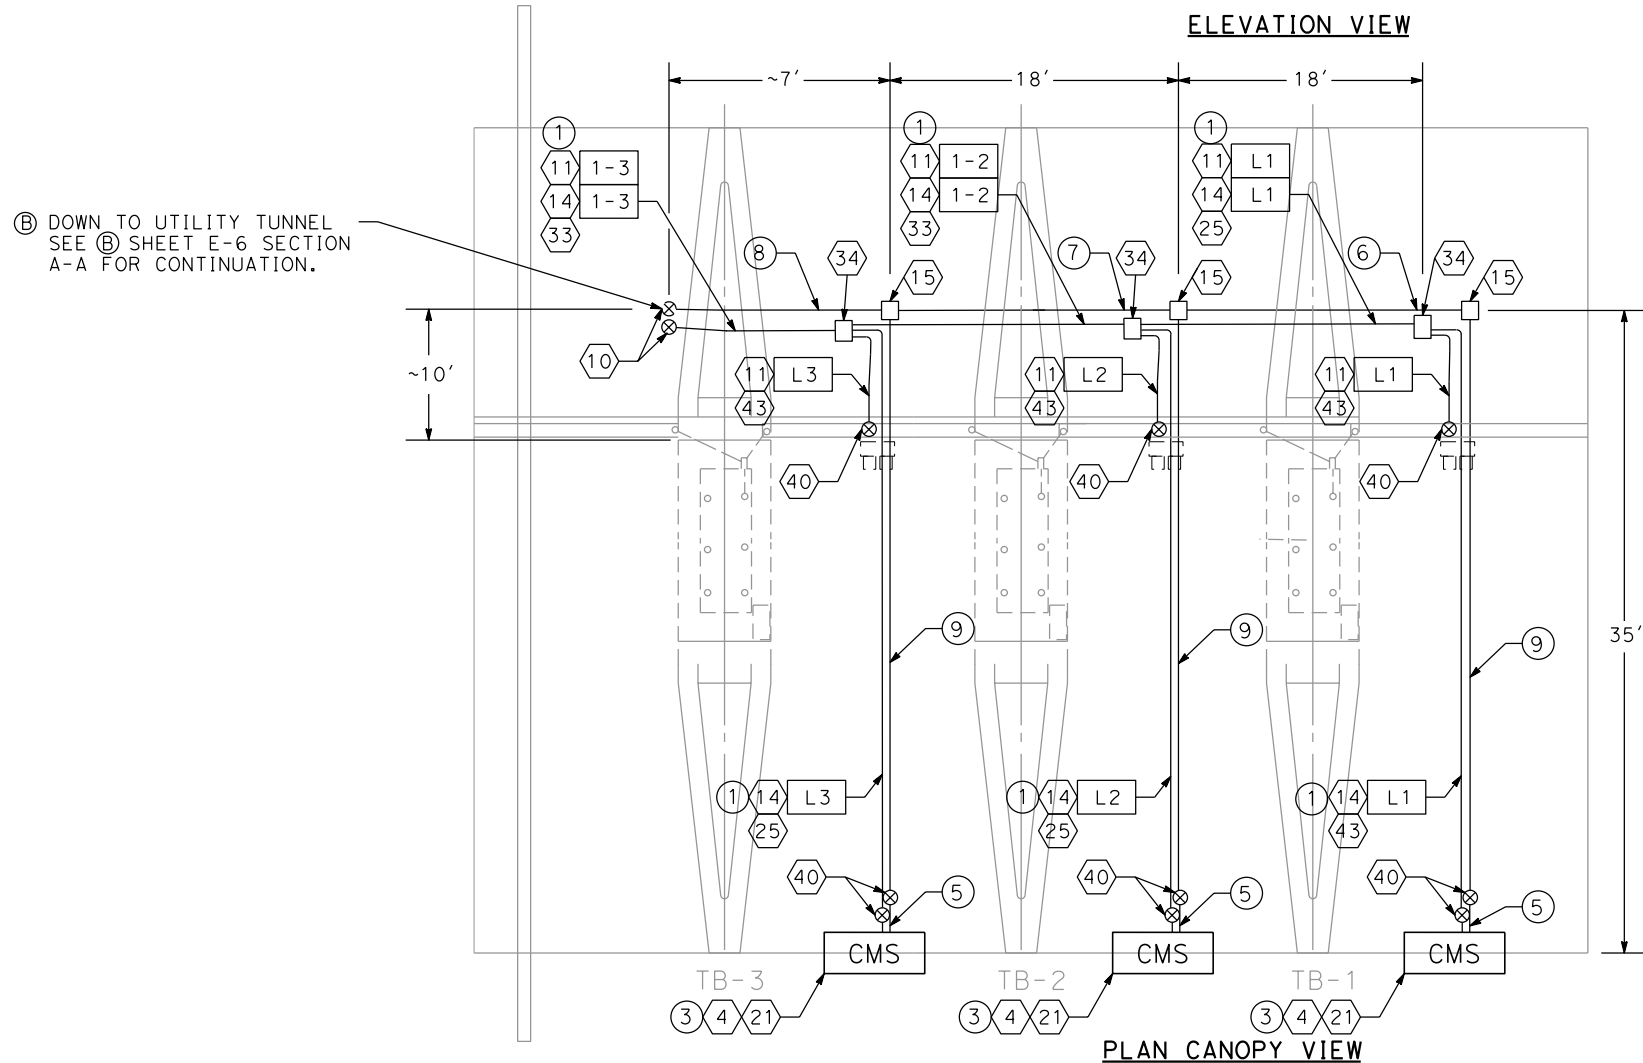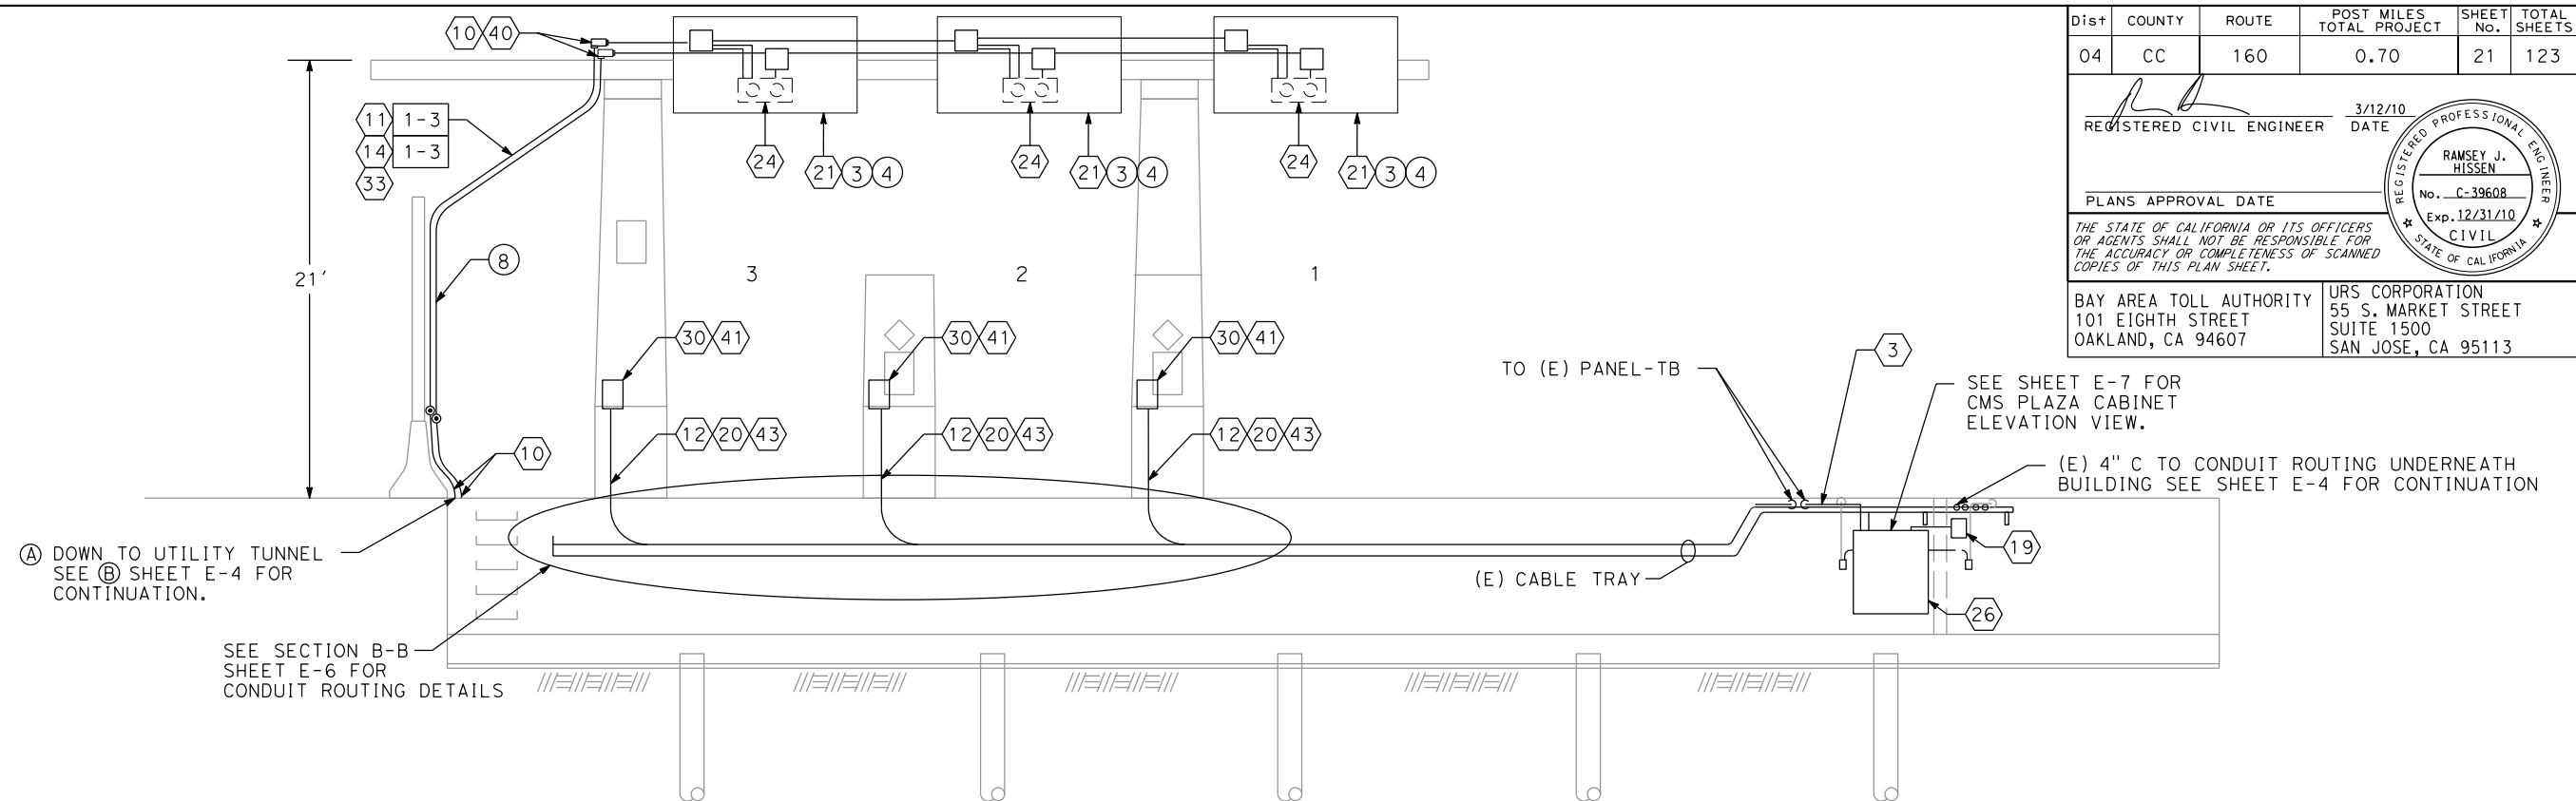

NOTES:

- ① CONTRACTOR TO PROVIDE CONDUIT SUPPORT.
- ② FINAL LOCATION OF CONDUIT AND JUNCTION BOX ROUTING AND ATTACHMENT DETAILS SHALL BE COORDINATED BY THE CONTRACTOR WITH THE ENGINEER PRIOR TO INSTALLATION.
- ③ REMOVE AND SALVAGE EXISTING STATIC SIGNS IN LANES 1-3 AND INSTALL NEW CMS PANELS.
- ④ SEE S-1, S-2, AND S-3 SHEETS FOR CMS PANEL MOUNTING TO CANOPY DETAILS.
- ⑤ INSTALL TYPE 4 (1" C) CONDUIT WITH 2 #12 & 1 #12G (120V, CMS SIGN POWER).
- ⑥ INSTALL TYPE 2 (1 1/2" C) CONDUIT WITH 2 #12 & 1 #12G (120V, CMS SIGN POWER).
- ⑦ INSTALL TYPE 2 (1 1/2" C) CONDUIT WITH 4 #12 & 2 #12G (120V, CMS SIGN POWER).
- ⑧ INSTALL TYPE 2 (1 1/2" C) CONDUIT WITH 6 #12 & 3 #12G (120V, CMS SIGN POWER).
- ⑨ INSTALL TYPE 2 (1" C) CONDUIT WITH 2 #12 & 1 #12G (120V, CMS SIGN POWER). PROVIDE CONDUIT SUPPORT EVERY 5 FEET (MAX).


**TOLL PLAZA OPERATIONS BUILDING  
TUNNEL TO CONOPY CONDUIT ROUTING  
(ANTIOCH BRIDGE) F-5**

NO SCALE

SHEET	OF	LAST REVISION
5	16	

Dist	COUNTY	ROUTE	POST MILES TOTAL PROJECT	SHEET TOTAL SHEETS
04	CC	160	0.70	22 123

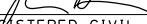


REGISTERED CIVIL ENGINEER

3/12/10  
DATE

PLANS APPROVAL DATE

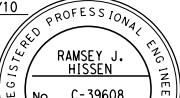


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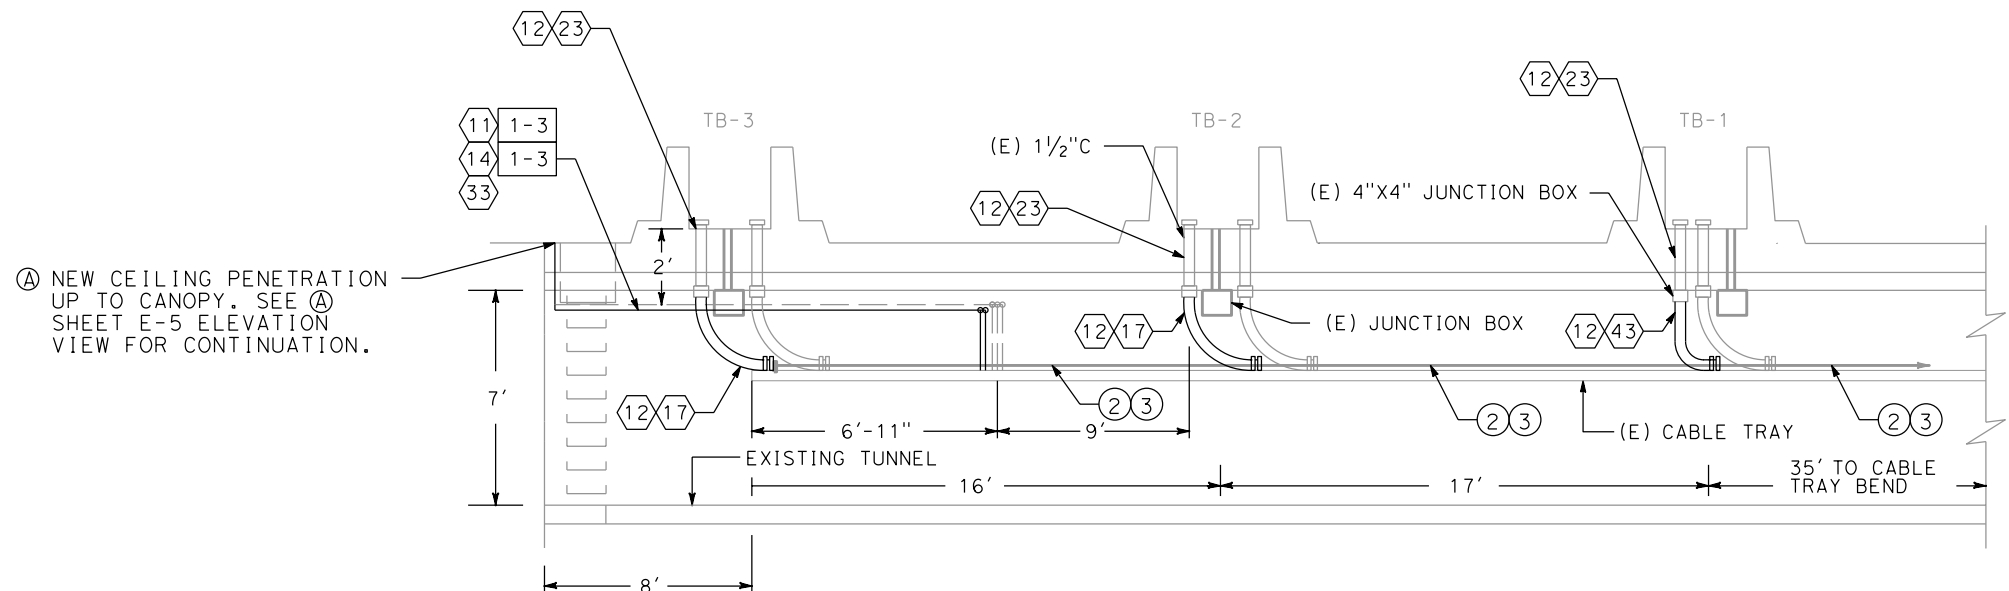
  

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**SECTION A-A**

- ## NOTES:
- 1 CONTRACTOR TO ATTACH NEW CONDUIT TO EXISTING CHANNEL STRUTS.
  - 2 ROUTE CMS COMM AND INDICATOR LIGHT CABLES ON EXISTING CABLE TRAY TOGETHER WITH EXISTING COMMUNICATION CABLES.
  - 3 ROUTE POWER CABLES ON EXISTING CABLE TRAY TOGETHER WITH EXISTING POWER CABLES.
  - 4 INSTALL TYPE 2 (1 1/2" C) CONDUIT WITH 6#12 & 3#12G (120V, CMS SIGN POWER)

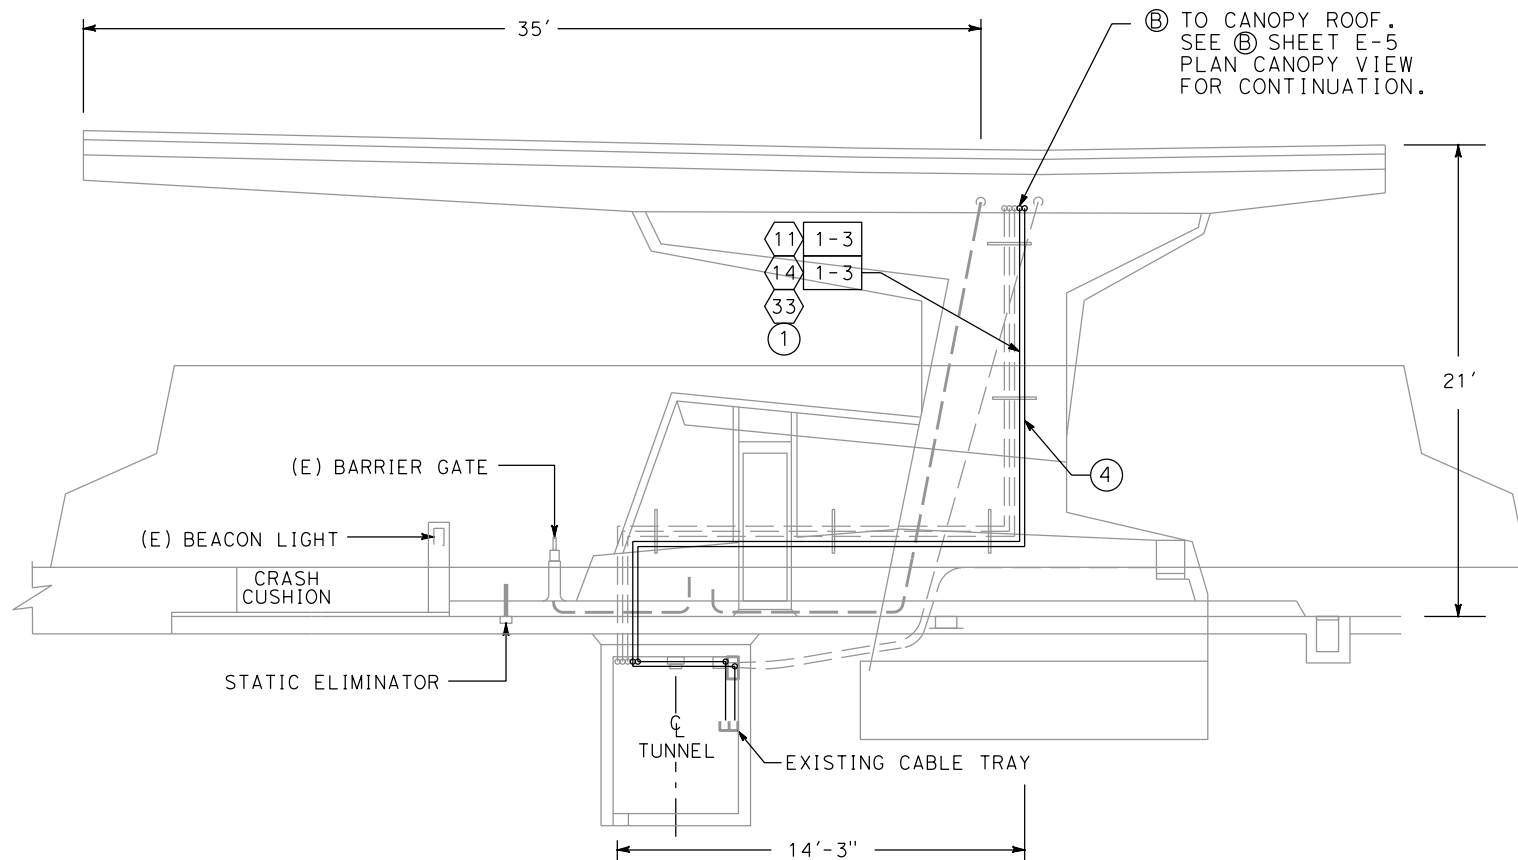

## SECTION B-B

# TOLL PLAZA OPERATIONS BUILDING CONDUIT ROUTING DETAILS (ANTIOCH BRIDGE)

NO SCALE

<b>E - 6</b>	
SHEET	OF
6	16

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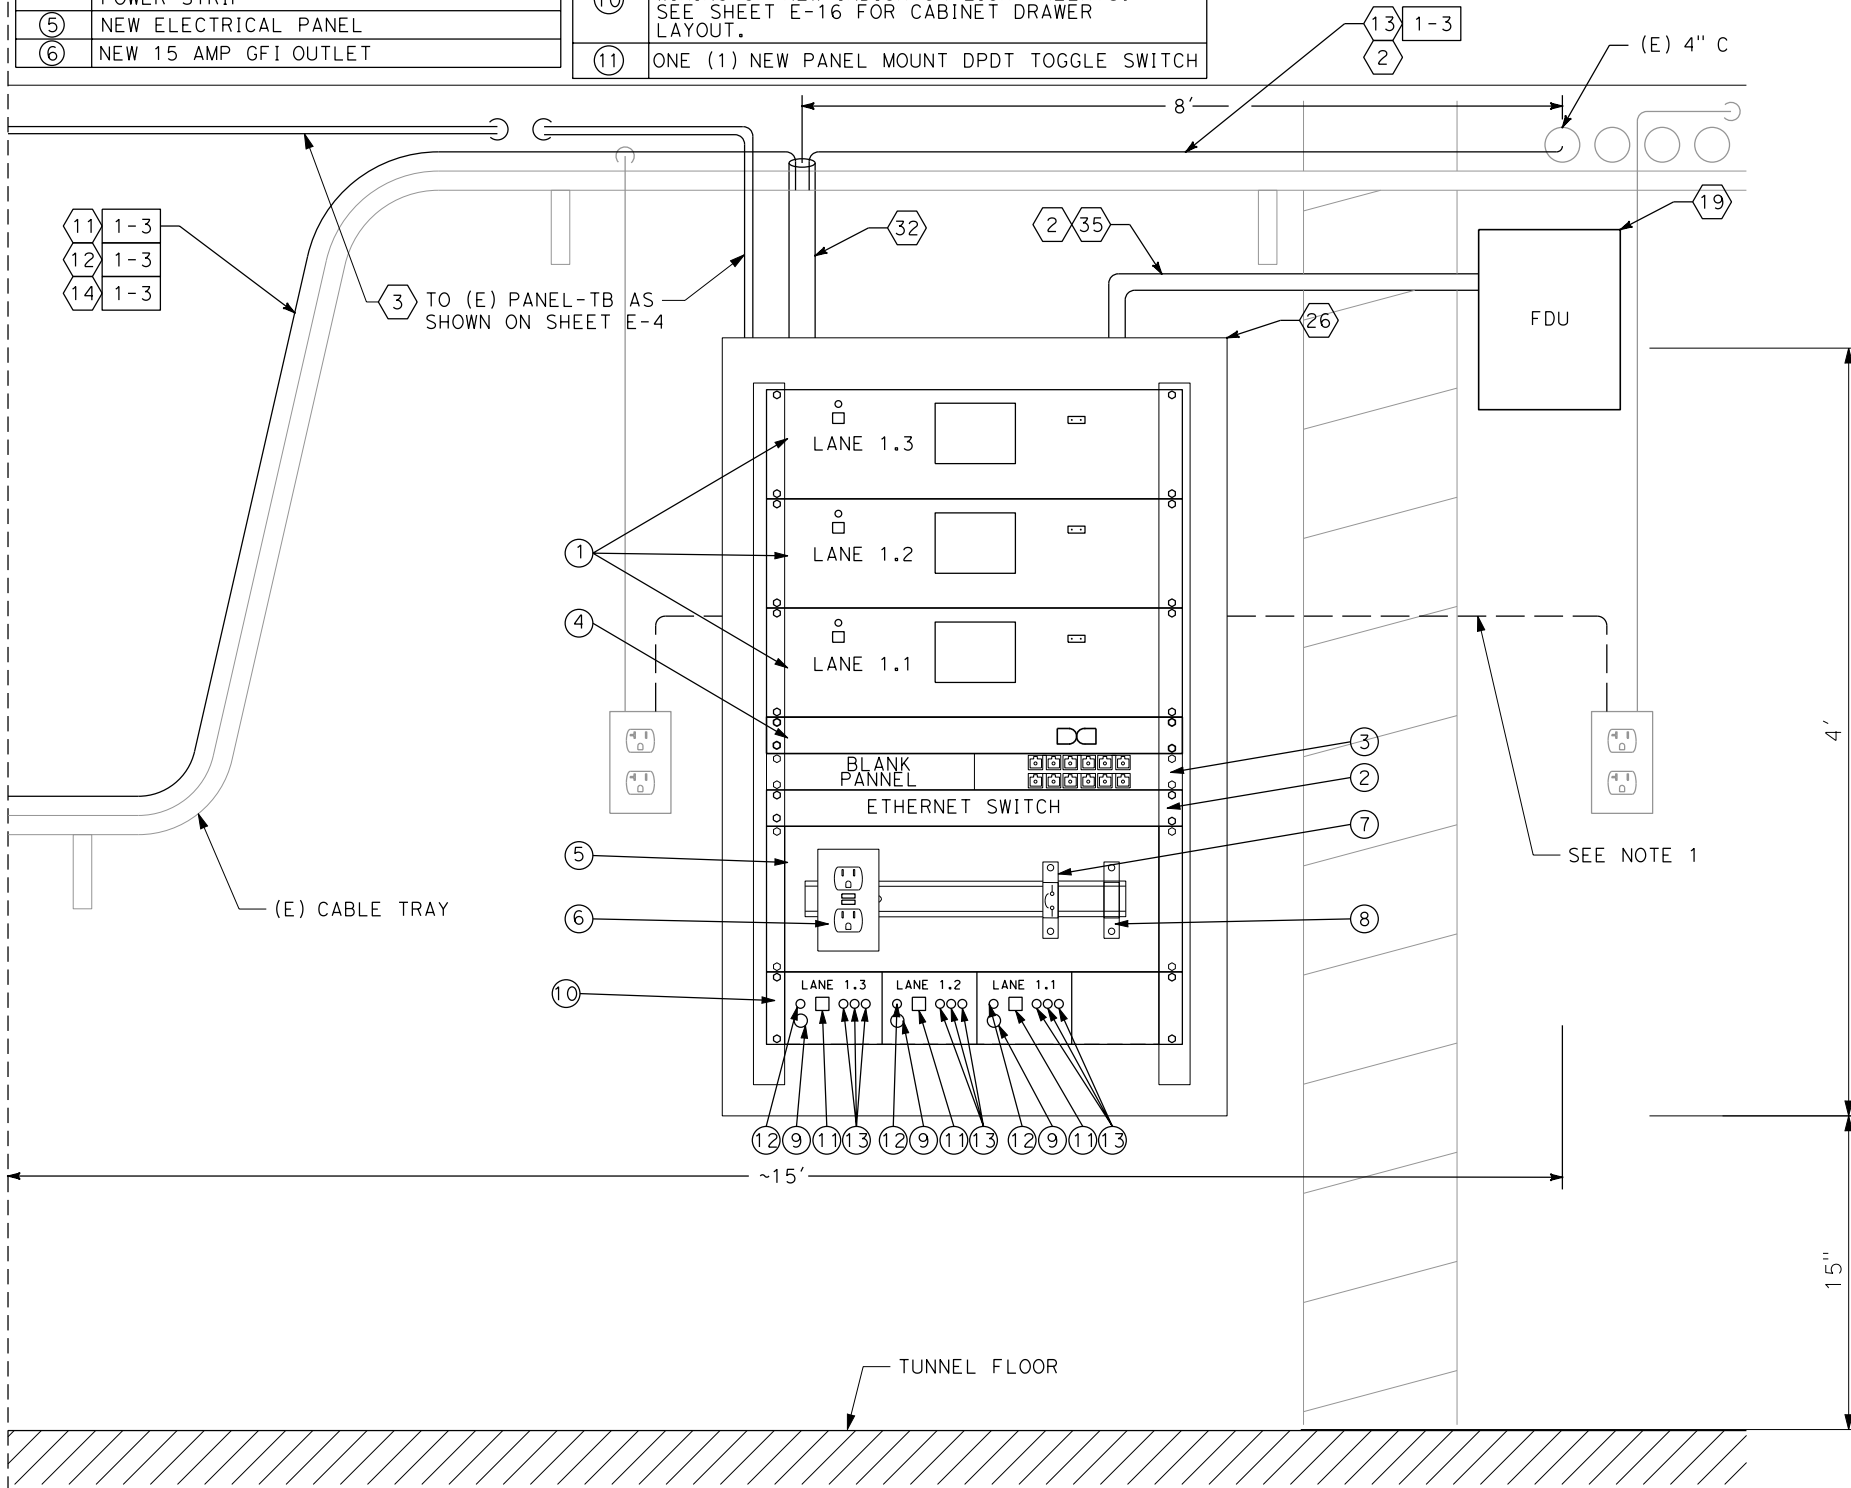
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DATE REVISED

ITEM	COMPONENT
①	NEW CMS CONTROLLER
②	NEW 14-PORT + 2 FIBER PORT ETHERNET SWITCH (RACK MOUNTED)
③	NEW 12-PORT FIBER PATCH (CONNECTOR) PANEL (X2)
④	NEW RACK MOUNTABLE IP ADDRESSABLE POWER STRIP
⑤	NEW ELECTRICAL PANEL
⑥	NEW 15 AMP GFI OUTLET

ITEM	COMPONENT
⑦	ONE (1) NEW 2 AMP BREAKER (120 VAC)
⑧	ONE (1) NEW NEC CLASS 3, 100 WATT 1:1, 120 VAC TRANSFORMER
⑨	ONE (1) NEW PANEL MOUNT 1/2 AMP PUSH BUTTON BREAKER (120 VAC)
⑩	INSTALL NEW PULL OUT DRAWER FOR WIRING OF NEW INDICATOR LIGHT RELAYS. SEE SHEET E-16 FOR CABINET DRAWER LAYOUT.
⑪	ONE (1) NEW PANEL MOUNT DPDT TOGGLE SWITCH

ITEM	COMPONENT
⑫	NEW PANEL MOUNT BLUE LED INDICATOR LIGHT (120VAC) FOR POWER INDICATION
⑬	NEW PANEL MOUNT RED, GREEN, AMBER LED INDICATOR LIGHTS (120VAC)



CMS PLAZA CABINET ELEVATION

## CMS PLAZA CABINET ELEVATION VIEW FOR LANES 1-3 (ANTIOCH BRIDGE)

NO SCALE

E-7

SHEET	OF
7	16

Dist	COUNTY	ROUTE	POST MILES TOTAL PROJECT	SHEET NO.	TOTAL SHEETS
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3/12/10  
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RAMSEY, J.  
HISSEN

No. C-39608

Exp. 12/31/10

CIVIL

STATE OF CALIFORNIA

BAY AREA TOLL AUTHORITY  
101 EIGHTH STREET  
OAKLAND, CA 94607

URS CORPORATION  
55 S. MARKET STREET  
SUITE 1500  
SAN JOSE, CA 95113

### SHEET NOTES:

- EXISTING CONDUIT TO BE RE-ROUTED FOR PLACEMENT OF CMS PLAZA CABINET. CONTRACTOR SHALL COORDINATE WITH LIEUTENANT.
- ALL CABLING IN CMS CABINETS SHALL BE INSTALLED AND NEATLY DRESSED AND SECURED IN CABINETS. SPARE COILED CABLING SHALL BE PROVIDED IN JUNCTION BOXES.
- CONTRACTOR TO INSTALL, CONNECT, AND INTEGRATE ALL EQUIPMENT IN CMS CABINETS (I.E., TRANSFORMERS, BREAKERS, ETC.).
- ALL CMS CABINET EQUIPMENT AND CONDUIT LOCATIONS SHOWN ON PLANS AND DETAILS ARE APPROXIMATE. FINAL LOCATION OF ALL EQUIPMENT AND MATERIALS SHALL BE AS DIRECTED AND APPROVED BY THE ENGINEER.
- CMS CABINET MOUNTED TO A CONCRETE WALL SHALL BE ATTACHED TO THE WALL USING  $\frac{3}{8}$ " DIAMETER EXPANSION ANCHORS, TOTAL 4 PER CABINET ATTACHED TO THE CONCRETE WALL. CONTRACTOR MAY PROPOSE AN ALTERNATIVE MOUNTING METHOD (I.E., MOUNTING RAILS) FOR APPROVAL BY ENGINEER.
- CABINET AND EQUIPMENT TO MEET CALTRANS TEES REQUIREMENTS.
- DO NOT CONNECT POWER STRIP TO GFI. CONNECT TO CABINET POWER SOURCE DIRECTLY BY MEANS OF A SEPARATE NEMA 5-15 SOCKET.
- CONTRACTOR TO LEAVE ONE (1) RACK UNIT OF SPACE AT BOTTOM OF CABINET.

RELATIVE BORDER SCALE  
IS IN INCHES

0 1 2 3

USERNAME => \$USER  
DGN FILE => \$REQUEST

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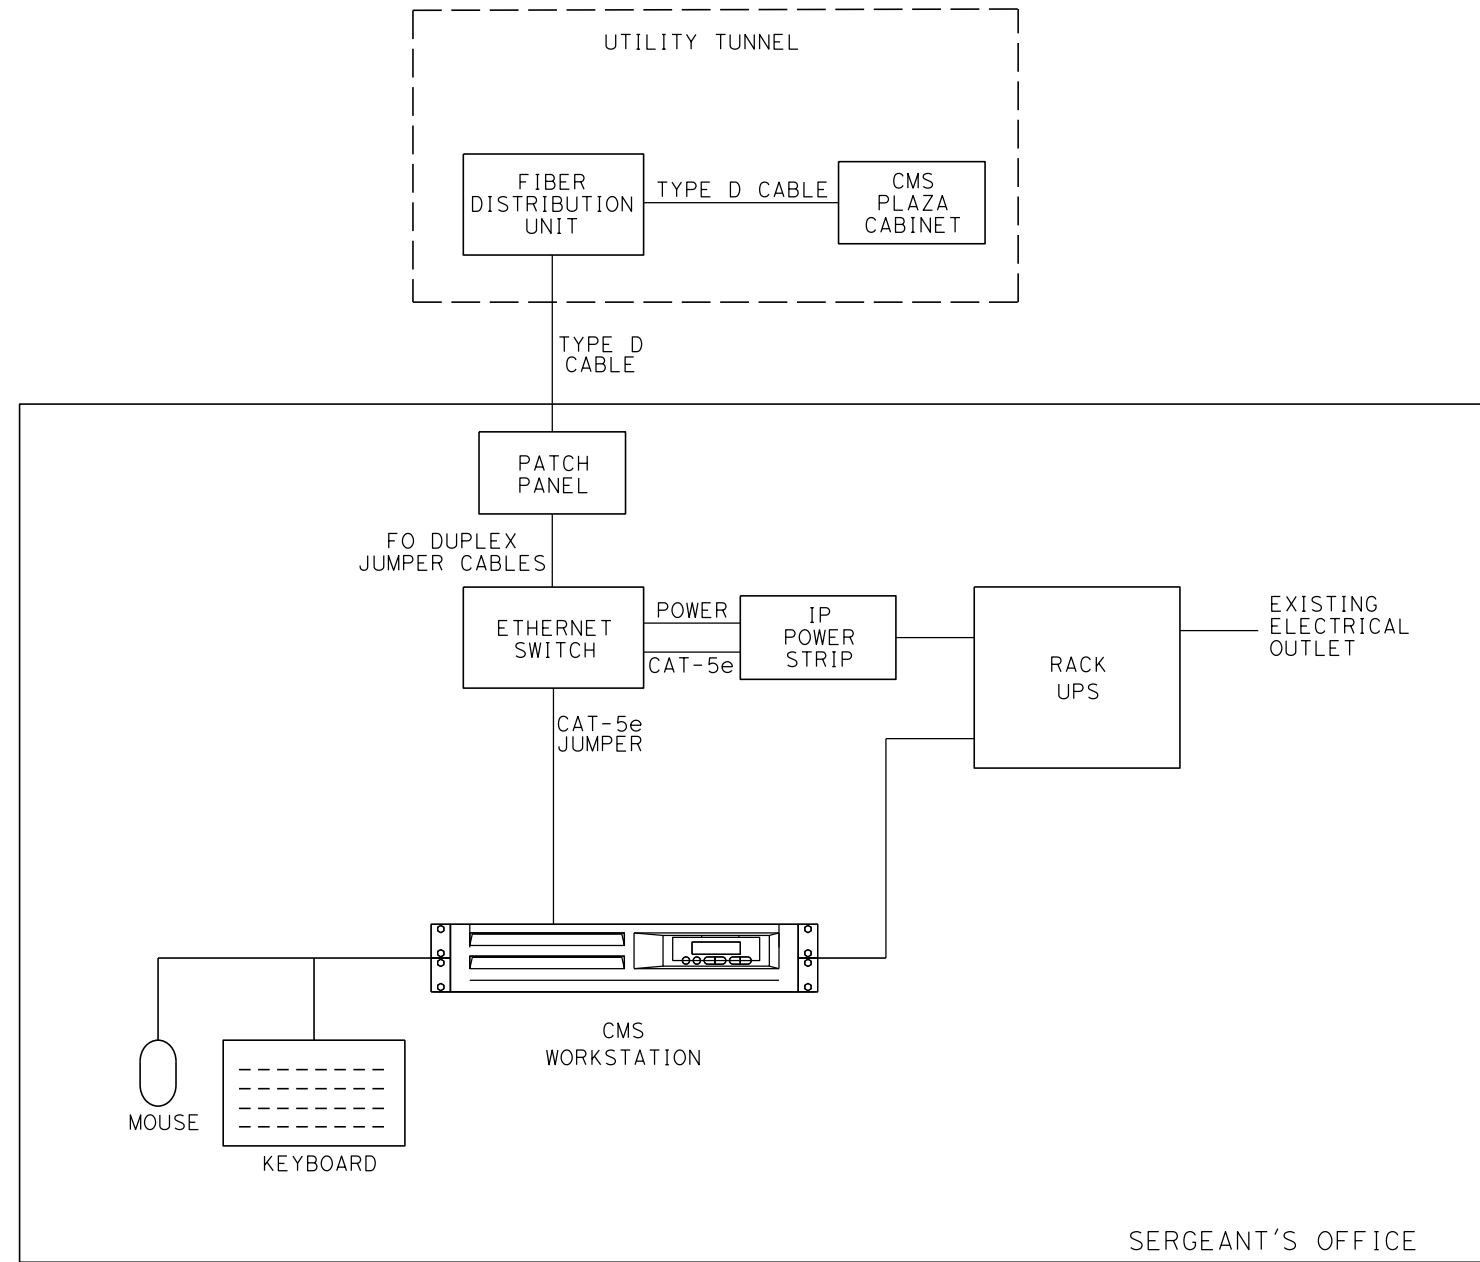
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DATE REVISED

NOTES:

- 1. SEE SHEETS E-9 TO E-10 FOR SPLICING AND INTERCONNECTION DETAILS.
- 2. SEE CMS WORKSTATION DETAIL SHEET E-3.
- 3. SEE SHEET E-7 FOR CMS PLAZA CABINET ELEVATION VIEW.



TOLL PLAZA OPERATIONS BUILDING

CMS SYSTEM CENTRAL CONTROL SCHEMATIC (ANTIOCH BRIDGE)

NO SCALE

E - 8

SHEET	OF
8	16



Dist	COUNTY	ROUTE	POST MILES TOTAL PROJECT	SHEET No.	TOTAL SHEETS
04	CC	160	0.70	24	123

REGISTERED CIVIL ENGINEER

DATE 3/12/10

PLANS APPROVAL DATE

REGISTERED PROFESSIONAL ENGINEER

RAMSEY J. HISSSEN

No. C-39608

Exp. 12/31/10

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SAN JOSE, CA 95113

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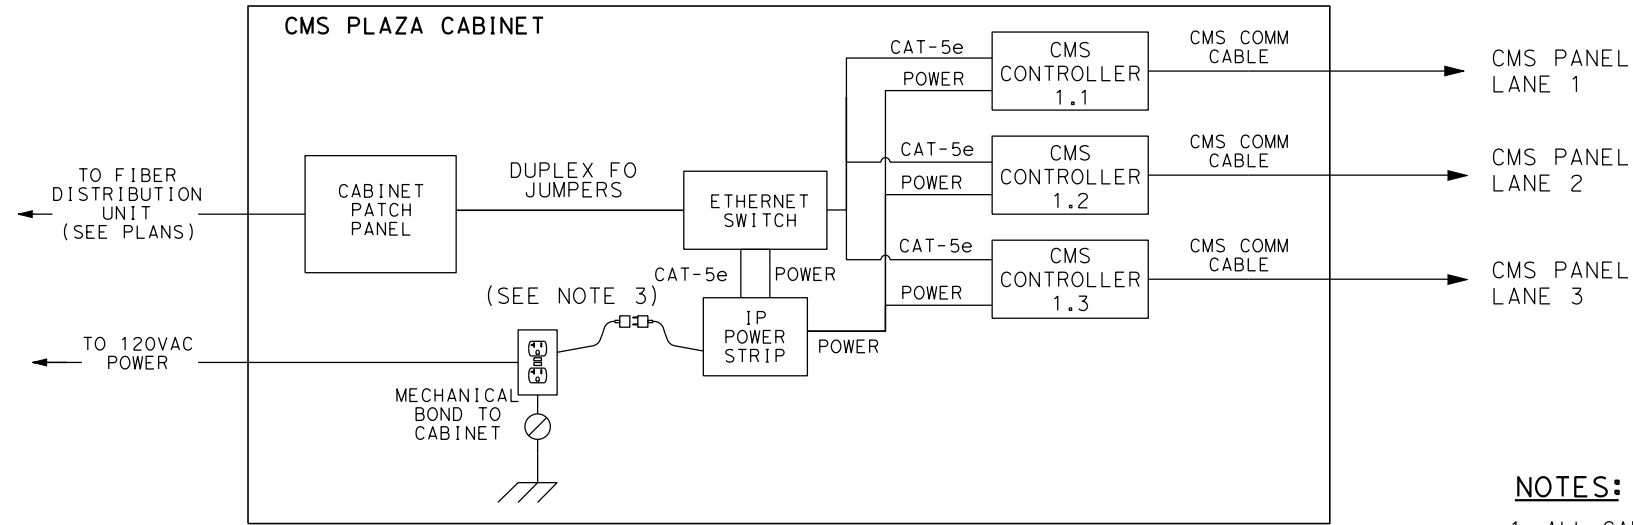
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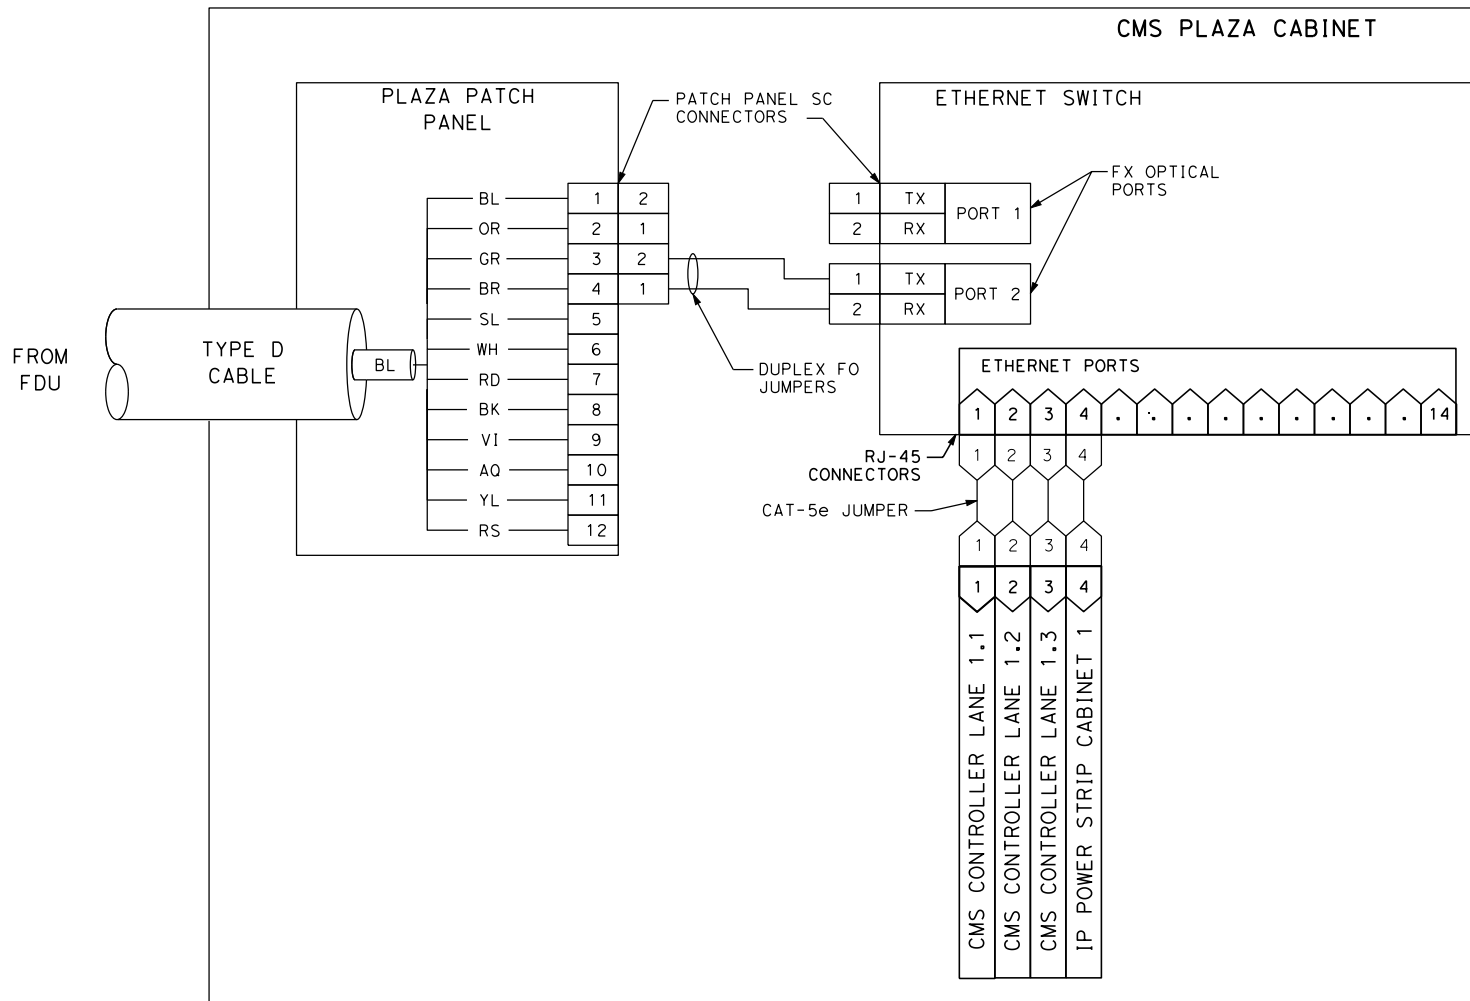
DATE REVISED

BORDER LAST REVISED 2/1/2008



NOTES:

1. ALL CABLING IN CMS CABINETS SHALL BE INSTALLED AND NEATLY DRESSED AND SECURED IN CABINETS. SPARE COILED CABLING SHALL BE PROVIDED IN JUNCTION BOXES.
2. CONTRACTOR TO INSTALL, CONNECT, AND INTEGRATE ALL EQUIPMENT IN CMS CABINETS (I.E., TRANSFORMERS, BREAKERS, ETC.)
3. DO NOT CONNECT POWER STRIP TO GFI. CONNECT TO CABINET POWER SOURCE DIRECTLY BY MEANS OF A SEPARATE NEMA 5-15 SOCKET.



CMS PLAZA CABINET  
WIRING SCHEMATIC  
(ANTIOCH BRIDGE)


NO SCALE

E-9

SHEET	OF
9	16

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Dist	COUNTY	ROUTE	POST MILES TOTAL PROJECT	SHEET No.	TOTAL SHEETS
04	CC	160	0.70	25	123
REGISTERED CIVIL ENGINEER			3/12/10 DATE	REGISTERED PROFESSIONAL ENGINEER RAMSEY J. HISSEN No. C-39608 Exp. 12/31/10 CIVIL STATE OF CALIFORNIA	
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TYPE D CABLE TO CMS PLAZA CABINET



FIBER No.	PLAZA PATCH PANEL	PLAZA CABINET			FIBER No.	REMARKS
1-2	O>			<O	1-2	FUTURE
3	X>	<X>	<X>	<X	3	ETHERNET TX PRIMARY
4	X>	<X>	<X>	<X	4	ETHERNET RX PRIMARY
5-12	O>	<O>	<O>	<O	5-12	FUTURE

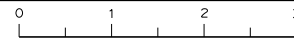TYPE D CABLE TO CMS WORKSTATION

FIBER No.	PLAZA PATCH PANEL	PLAZA CABINET			FIBER No.	REMARKS
1-2	O>			<O	1-2	FUTURE
3	X>	<X>	<X>	<X	3	ETHERNET TX PRIMARY
4	X>	<X>	<X>	<X	4	ETHERNET RX PRIMARY
5-12	O>	<O>	<O>	<O	5-12	FUTURE

NOTES:

- X - TERMINATED ACTIVE
- O - TERMINATED SPARE
- < > - ARROW POINTS TO THE DIRECTION OF TRANSMISSION
- - TERMINATED FIBERS (SC CONNECTOR)

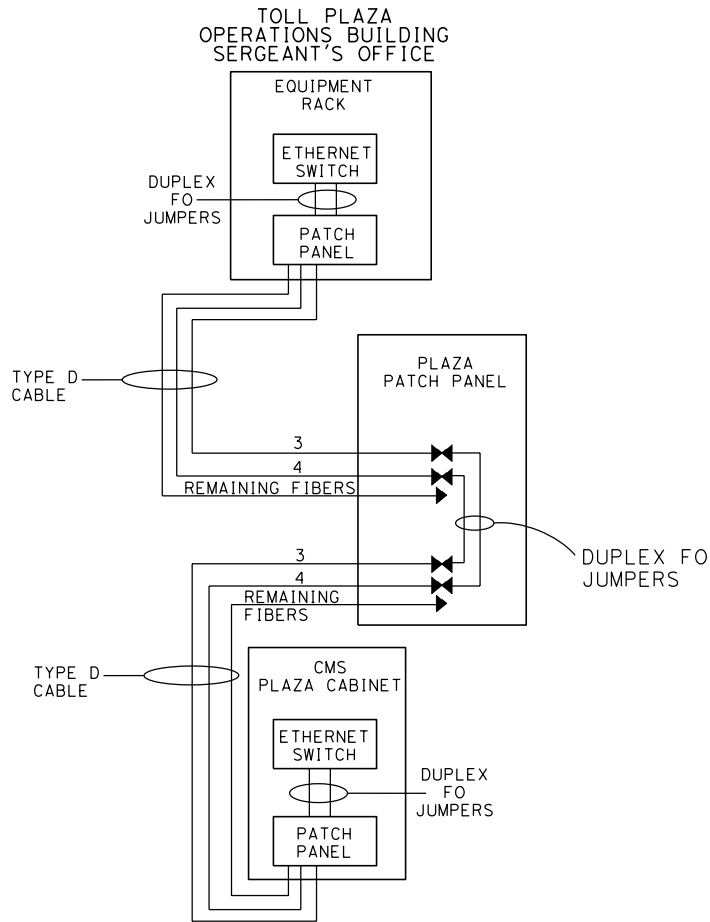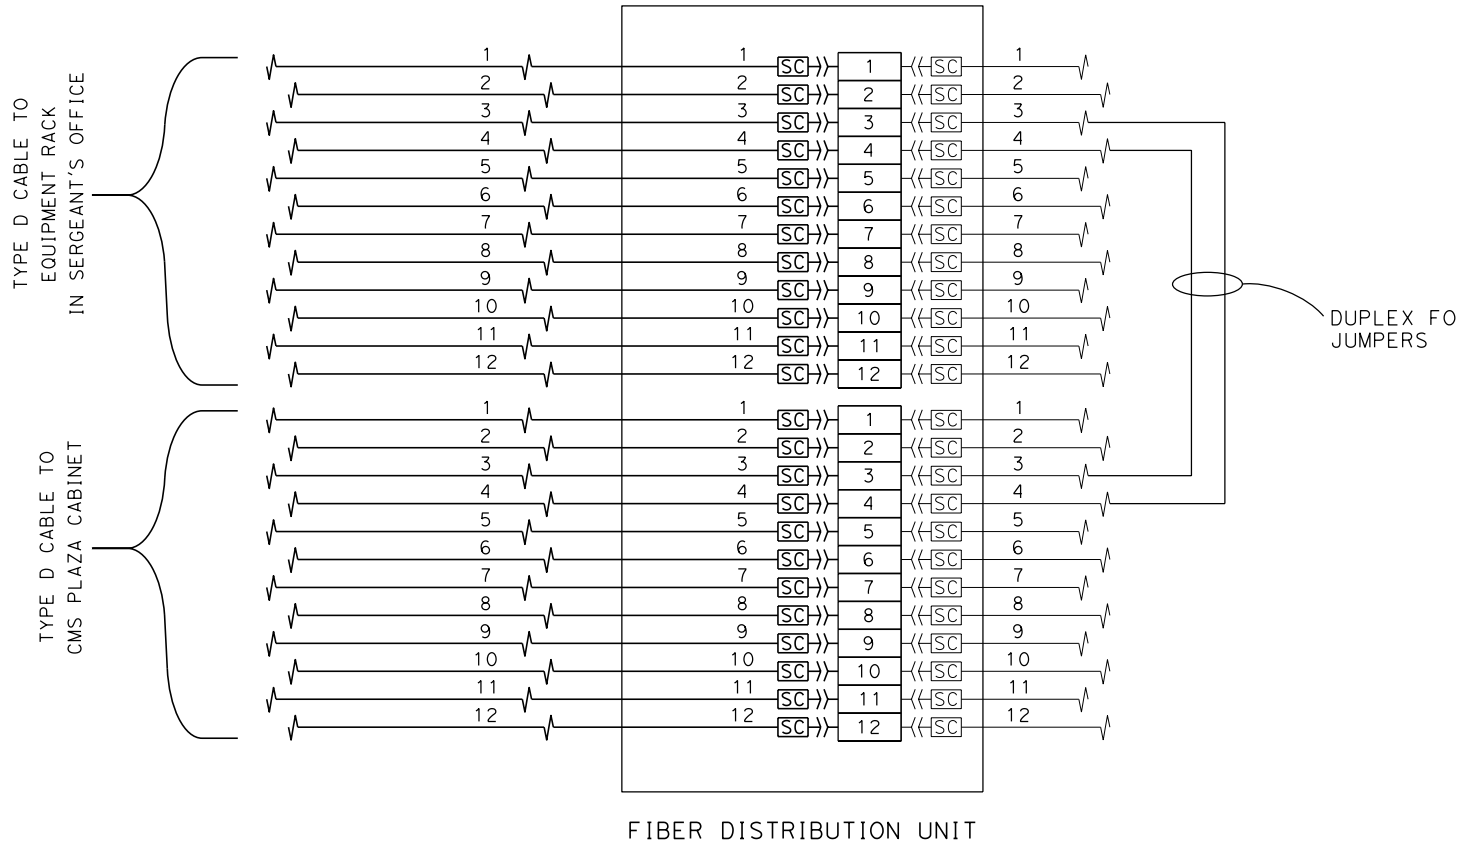

TYPE D CABLE  
FIBER ASSIGNMENT  
(ANTIOCH BRIDGE)

NO SCALE

E-10

SHEET	OF
10	16

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DATE PLOTTED => \$DATE  
TIME PLOTTED => \$TIME

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Dist	COUNTY	ROUTE	POST MILES TOTAL PROJECT	SHEET No.	TOTAL SHEETS
04	CC	160	0.70	26	123

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55 S. MARKET STREET  
SUITE 1500  
SAN JOSE, CA 95113

REGISTERED PROFESSIONAL ENGINEER

RAMSEY J. HISSON


No. C-39608

Exp. 12/31/10

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STATE OF CALIFORNIA

STATE OF CALIFORNIA - DEPARTMENT OF TRANSPORTATION		CONSULTANT FUNCTIONAL SUPERVISOR						
				CALCULATED- DESIGNED BY	REVISED BY			
				CHECKED BY	DATE REVISED			

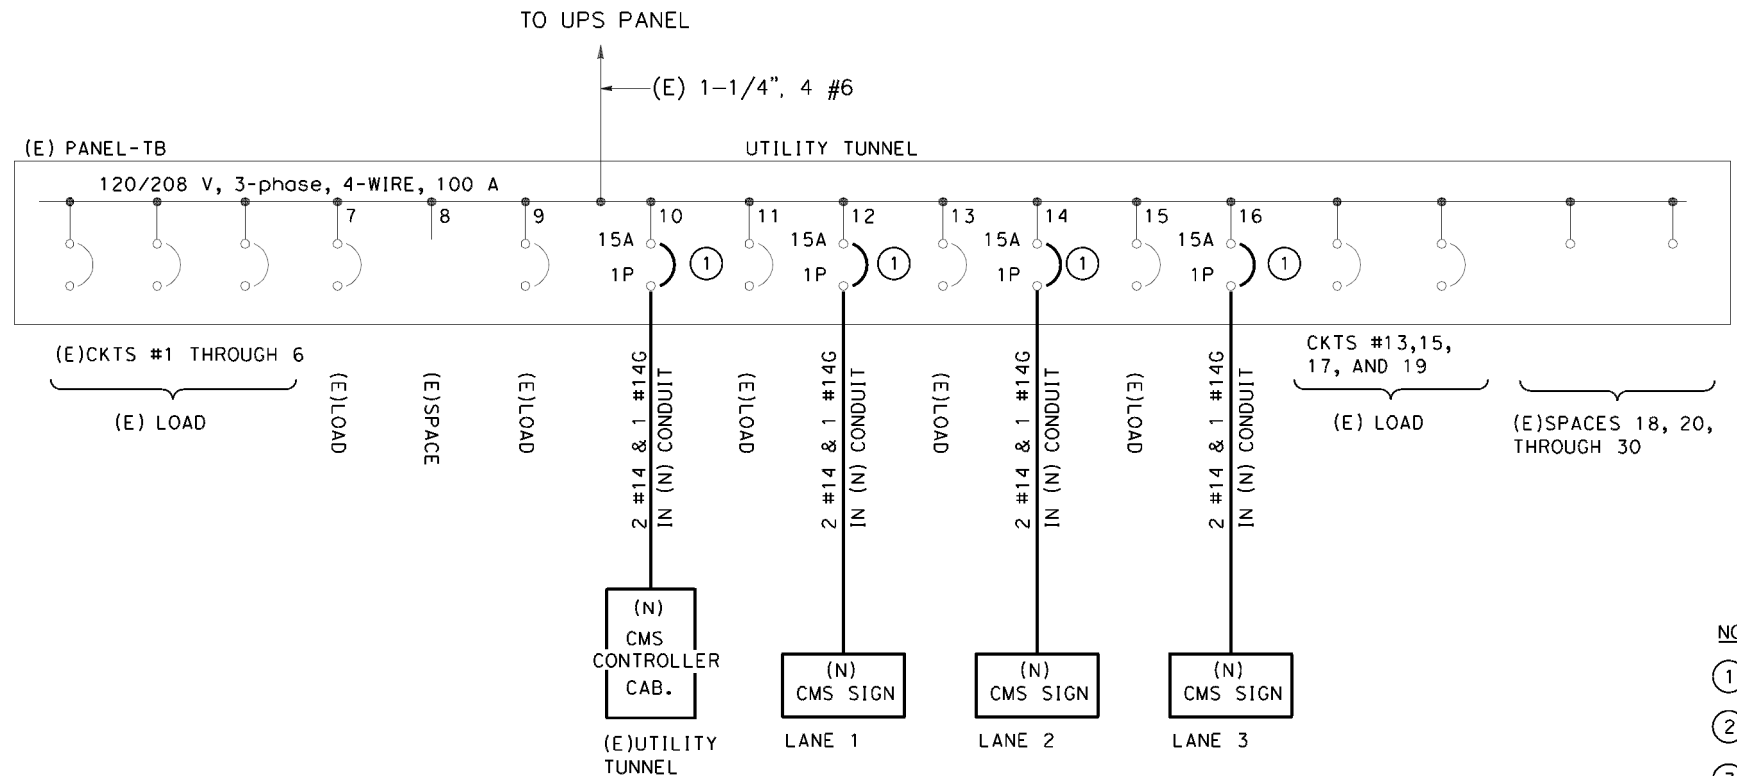

PROJECT: BATA TO12 TOLL PLAZAS CMS INITIALIZATION

(E) PANEL- TB

LOCATION: ANTIOCH BRIDGE  
SERVICE: UTILITY TUNNEL


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				AMP	POLE				AMP	POLE					
(E) LANE 1- BOOTH EQPT				20	1	1	A	2	20	1				(E) CAMERA LANE 1	
(E) LANE 1- ENT. LT. CURTAIN				20	1	3	B	4	20	1				(E) CAMERA LANE 2	
(E) LANE 1- ENT. LT. CURTAIN				20	1	5	C	6	20	1				(E) CAMERA LANE 3	
(E) LANE 2- BOOTH EQPT				20	1	7	A	8	20	1				(E) SPACE	
(E) LANE 2- ENTRANCE LT. CURTAIN				20	1	9	B	10	15	1			0.60	(N) CMS CABINET- TUNNEL	
(E) LANE 2- EXIT LT. CURTAIN				20	1	11	C	12	15	1			0.50	(N) CMS SIGN- LANE 1	
(E) LANE 3- BOOTH EQPT				20	1	13	A	14	15	1			0.50	(N) CMS SIGN- LANE 2	
(E) LANE 3- ENTRANCE LT. CURTAIN				20	1	15	B	16	15	1			0.50	(N) CMS SIGN- LANE 3	
(E) LANE 3- EXIT LT. CURTAIN				20	1	17	C	18		1				(E) SPACE	
(E) LIGHT SENSORS ON LANE 2				20	1	19	A	20		1				(E) SPACE	
(E) SPACE					1	21	B	22		1				(E) SPACE	
(E) SPACE					1	23	C	24		1				(E) SPACE	
(E) SPACE					1	25	A	26		1				(E) SPACE	
(E) SPACE					1	27	B	28		1				(E) SPACE	
(E) SPACE					1	29	C	30		1				(E) SPACE	
TOTALS SECTION 1	0.00	0.00	0.00									0.00	0.00	2.10	
VOLTAGE: 120/208V	LOAD SUMMARY														ADDITIONAL FEATURES:
PHASE/WIRE: 3 PHASE / 4 WIRE	CONNECT LOAD	DEMAND FACTOR		DEMAND LOAD		BALANCE: (KVA) % AMPS:									
RATING: 100A	0.00	125% OF LOAD		0.00		PHASE A: 0.50 23.81 1.39									
MAINS:	0.00	NEC 220-13		0.00		PHASE B: 1.10 52.38 3.06									
MAIN LUG ONLY	2.10	1.00		2.10		PHASE C: 0.50 23.81 1.39									
MOUNTING: SURFACE	2.10	KVA		2.10	KVA										
A.I.C.:	5.8	AMPS		5.8	AMPS										
BUS SIZE:															S&L JOB #:

Dist	COUNTY	ROUTE	POST MILES TOTAL PROJECT	SHEET TOTAL SHEETS
04	CC	160	0.70	27 123

*Carol Light*  
 REGISTERED CIVIL ENGINEER      3/12/10 DATE

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- NOTES:**
- ① INSTALL NEW CIRCUIT BREAKER IN EXISTING SPACE.
  - ② CONTRACTOR TO UPDATE BREAKER PANEL BOARD SCHEDULE AND PROVIDE A NEW TYPED WRITTEN PANEL BOARD SCHEDULE.
  - ③ THE CMS CABINET AND SIGNS SHALL BE CONNECTED TO THE BUILDING GROUNDING SYSTEM BY THE EQUIPMENT GROUND CONDUCTOR IN EACH CONDUIT.
  - ④ ALL METAL PARTS OF THE ELECTRICAL SYSTEM SHALL BE BONDED TOGETHER PER CONTRACT SPECIFICATIONS.

## PARTIAL ONE LINE DIAGRAM AND PANEL SCHEDULE (ANTIOCH BRIDGE)

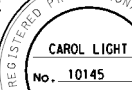NO SCALE

**E-11**

SHEET	OF
11	16

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TIME PLOTTED => \$TIME	00-00-00

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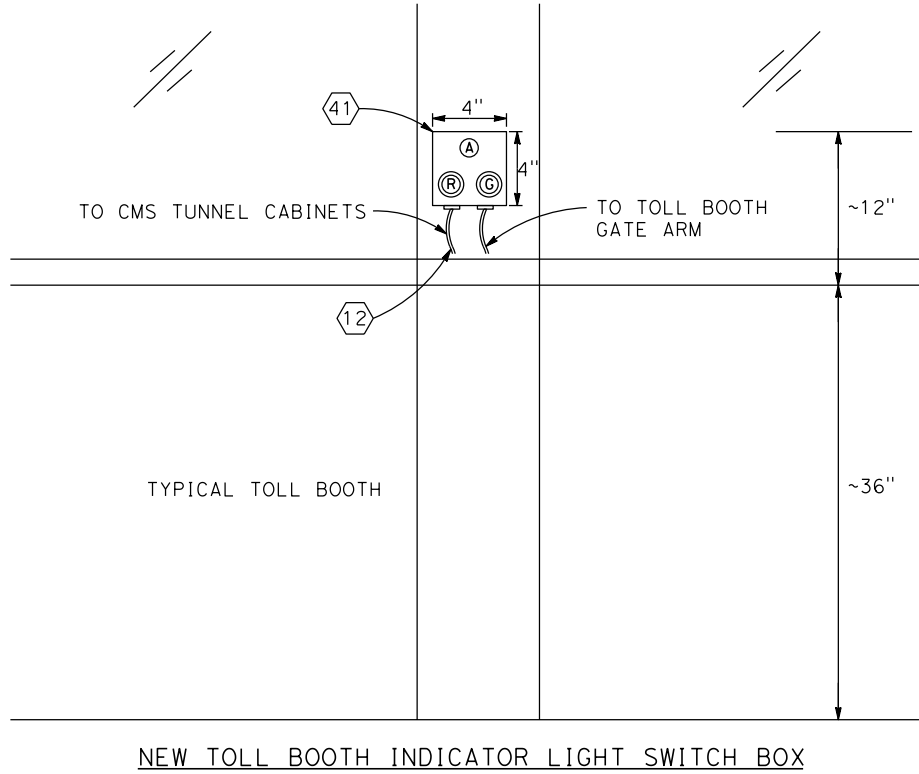
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DATE

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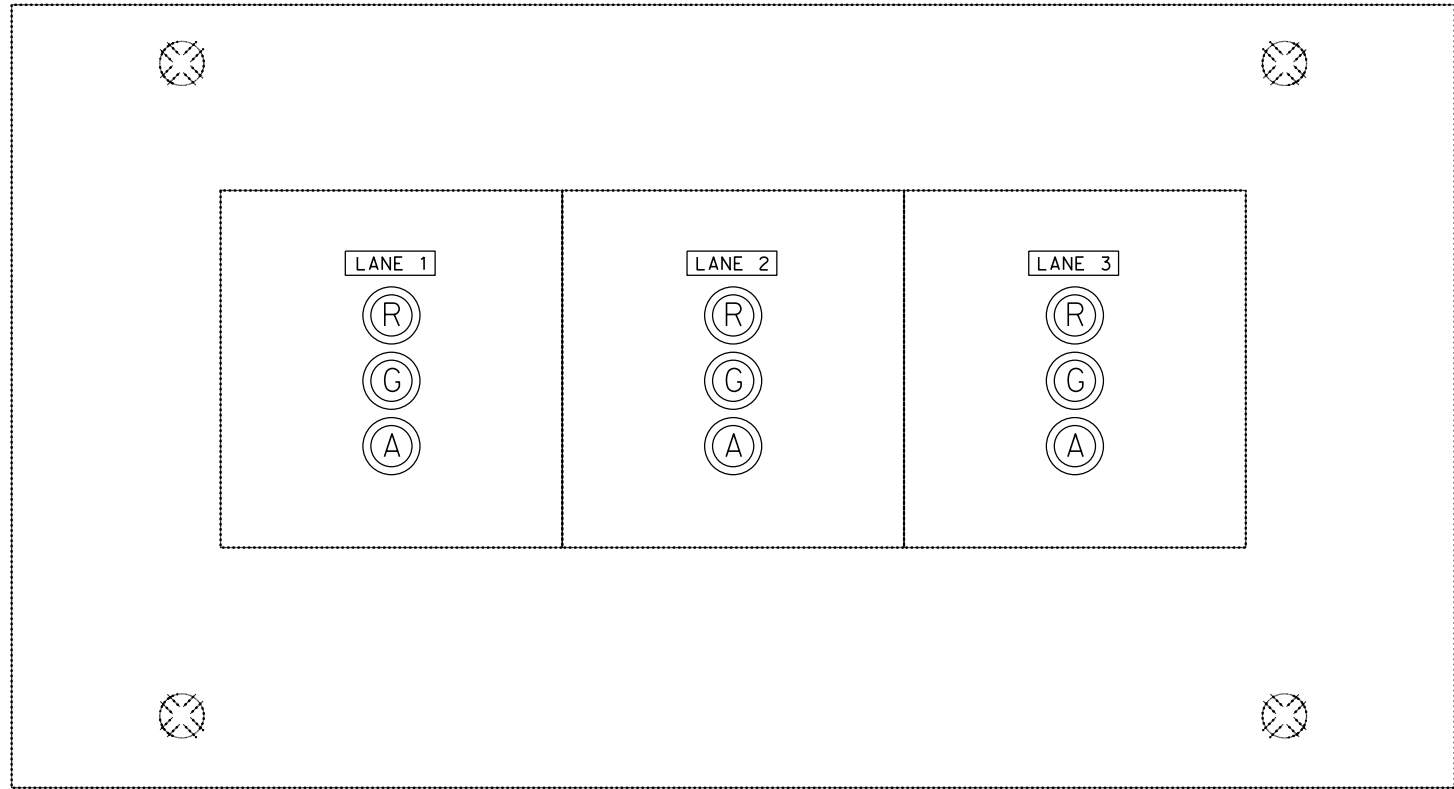
NOTES:

1. SIZE OF CONSOLE SWITCH PANEL WILL BE FIELD DETERMINED BY CONTRACTOR TO ACCOMMODATE NUMBER OF LANES.
2. SEE SHEET E-3 FOR LOCATION OF SWITCH CONSOLE PANEL.
3. SEE SHEET E-13 FOR PROPOSED WIRING CONFIGURATION.
4. CONTRACTOR TO LABEL PUSH BUTTON SWITCH WITH R, G, AND A LETTERS FOR RED, GREEN, AND AMBER LANE INDICATION.



LEGEND

- (R) PANEL MOUNT MOMENTARY RED LED ILLUMINATED PUSH BUTTON SWITCH
- (G) PANEL MOUNT MOMENTARY GREEN LED ILLUMINATED PUSH BUTTON SWITCH
- (A) PANEL MOUNT MOMENTARY AMBER LED ILLUMINATED PUSH BUTTON SWITCH
- (A) AMBER INDICATOR LED LIGHT



INDICATOR LIGHT SWITCH CONSOLE PANEL  
AND TOLL BOOTH INDICATOR SWITCH BOX  
(ANTIOCH BRIDGE)

NO SCALE

E-12

SHEET	OF
12	16

BORDER LAST REVISED 2/1/2008


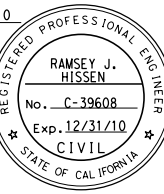
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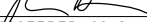
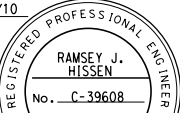
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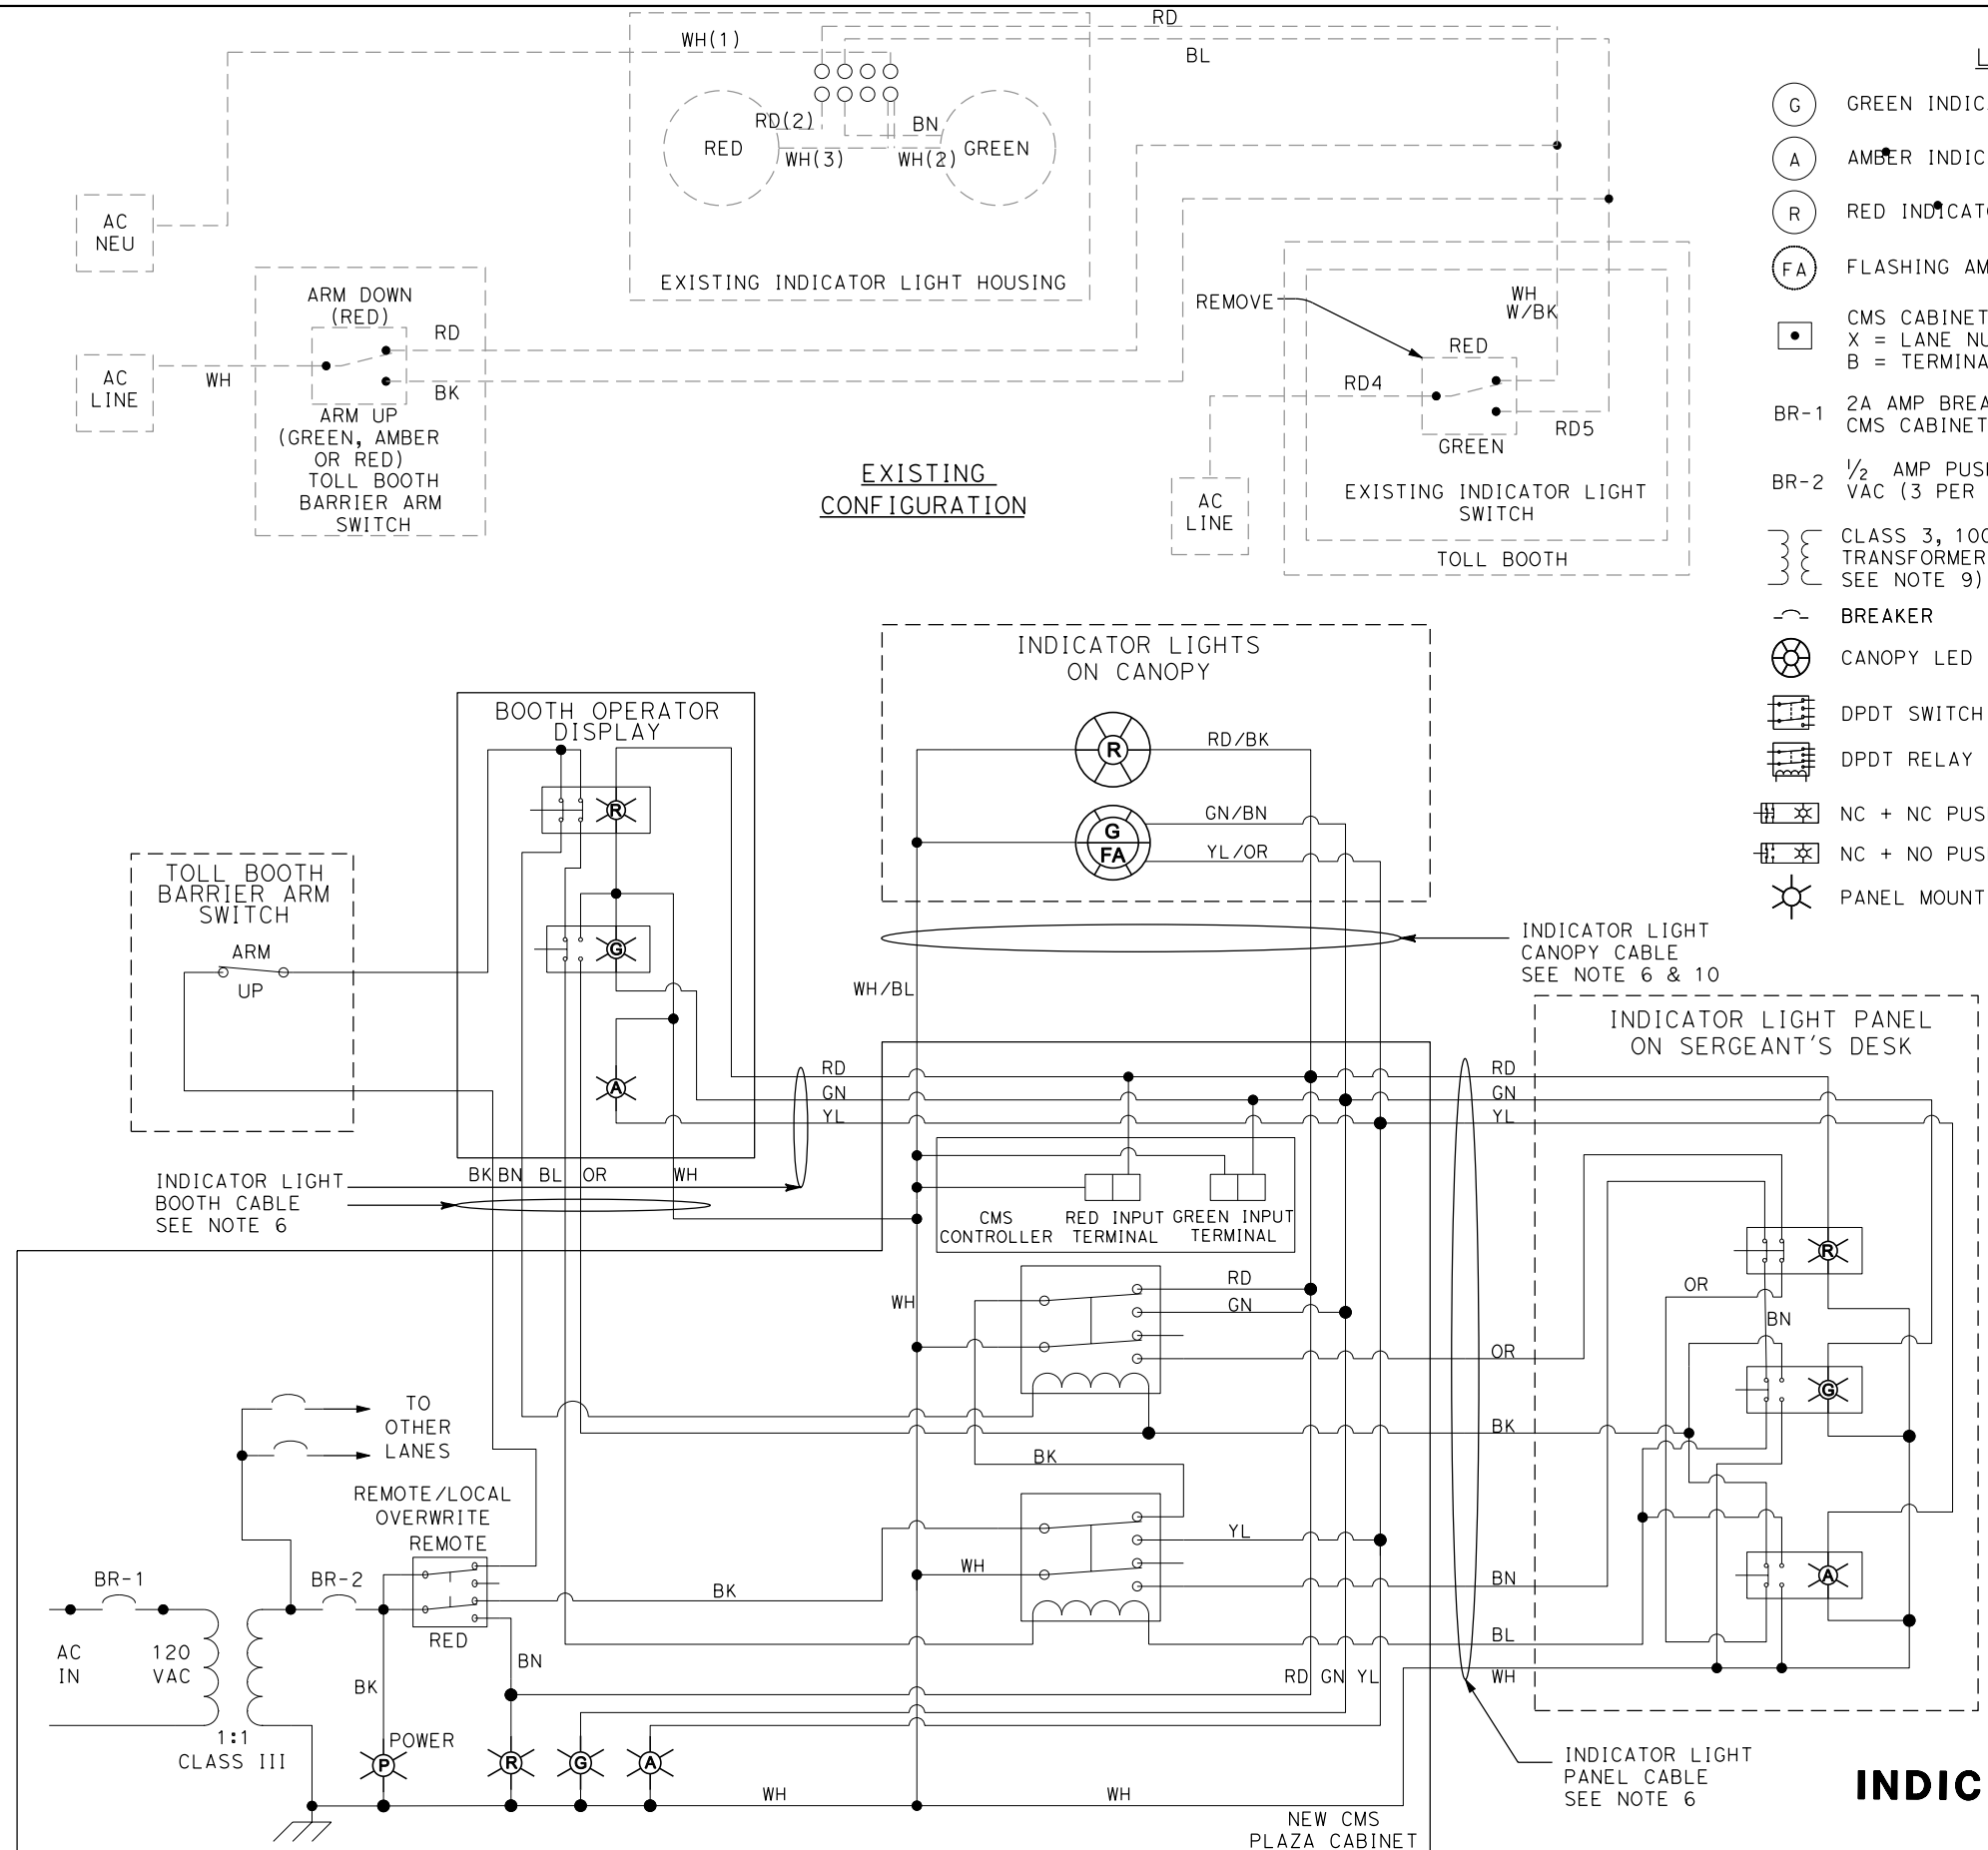
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




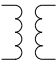







EA TBD (BATA-0006)

DIST	COUNTY	ROUTE	POST MILES TOTAL PROJECT	SHEET NO.	TOTAL SHEETS
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PLANS APPROVAL DATE					
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DATE PLOTTED => \$DATE  
TIME PLOTTED => \$TIME

Dist	COUNTY	ROUTE	POST MILES TOTAL PROJECT	SHEET No.	TOTAL SHEETS
04	CC	160	0.70	29	123
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PLANS APPROVAL DATE					
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- ### LEGEND
- |   |  |
|---|--|
|  | GREEN INDICATOR LED LIGHT, 120 VAC   |
|  | AMBER INDICATOR LED LIGHT, 120 VAC   |
|  | RED INDICATOR LED LIGHT, 120 VAC   |
|  | FLASHING AMBER LED LIGHT, 120 VAC  |
|  | CMS CABINET TERMINAL BLOCK X-B<br>X = LANE NUMBER<br>B = TERMINAL BLOCK NUMBER |
| BR-1  | 2A AMP BREAKER, 120 VAC (1 PER CMS CABINET)                                    |
| BR-2  | 1/2 AMP PUSH BUTTON BREAKER, 120 VAC (3 PER CMS CABINET - SEE NOTE 7)          |
|  | CLASS 3, 100 WATT 1:1, 120 VAC TRANSFORMER (PER 3 CMS CONTROLLERS SEE NOTE 9)  |
|  | BREAKER  |
|  | CANOPY LED INDICATOR   |
|  | DPDT SWITCH  |
|  | DPDT RELAY   |
|  | NC + NC PUSH BUTTON SWITCH W/ INDICATOR  |
|  | NC + NO PUSH BUTTON SWITCH W/ INDICATOR  |
|  | PANEL MOUNT LIGHT INDICATOR (120 VAC)  |

- NOTES:**
1. ELECTRICAL DIAGRAM SHOWS A SINGLE (ONE) FASTRAK LANE FOR SIMPLICITY.
  2. SEE SHEET E-12 FOR INDICATOR LIGHT SWITCH CONSOLE PANEL DETAIL.
  3. POWER TO TRANSFORMER FROM CMS CABINET POWER STRIP. ONE TRANSFORMER PER CMS CABINET.
  4. REMOVE EXISTING SWITCH AND INSTALL NEW INDICATOR LED LIGHTS AND PUSH BUTTON SWITCHES ON WALL BOX.
  5. BELDEN 5506UE OR APPROVED EQUIVALENT.
  6. REPLACE EXISTING GREEN INDICATOR LIGHT ON CANOPY WITH NEW GREEN / FLASHING AMBER LED LIGHT.
  7. ONE (1)  $\frac{1}{2}$  AMP PUSH BUTTON BREAKER PER CMS CONTROLLER OR THREE (3)  $\frac{1}{2}$  AMP PUSH BUTTON BREAKERS PER CMS CABINET WITH 3 CMS CONTROLLERS.
  8. INTERCEPT EXISTING GATE ARM CABLE IN TOLL BOOTH.
  9. ONE (1) CLASS THREE, 100W 1:1, 120 VAC TRANSFORMER PER 3 INDICATOR LIGHT CONTROL LANES.
  10. USE TWO CONDUCTORS FOR NEUTRAL, TWO CONDUCTORS FOR RED, TWO CONDUCTORS FOR GREEN, AND TWO CONDUCTORS FOR FLASHING AMBER CONNECTIONS FROM CMS CABINET TO INDICATOR LIGHTS ON CANOPY.

## INDICATOR LIGHT WIRING DIAGRAM FOR LANES 1-3 (ANTIOCH BRIDGE)

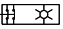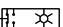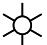





x

x

x

x

x

\$REQUEST

STATE OF CALIFORNIA - DEPARTMENT OF TRANSPORTATION

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DESIGNED BY

CONSULTANT FUNCTIONAL SUPERVISOR

REVISED BY

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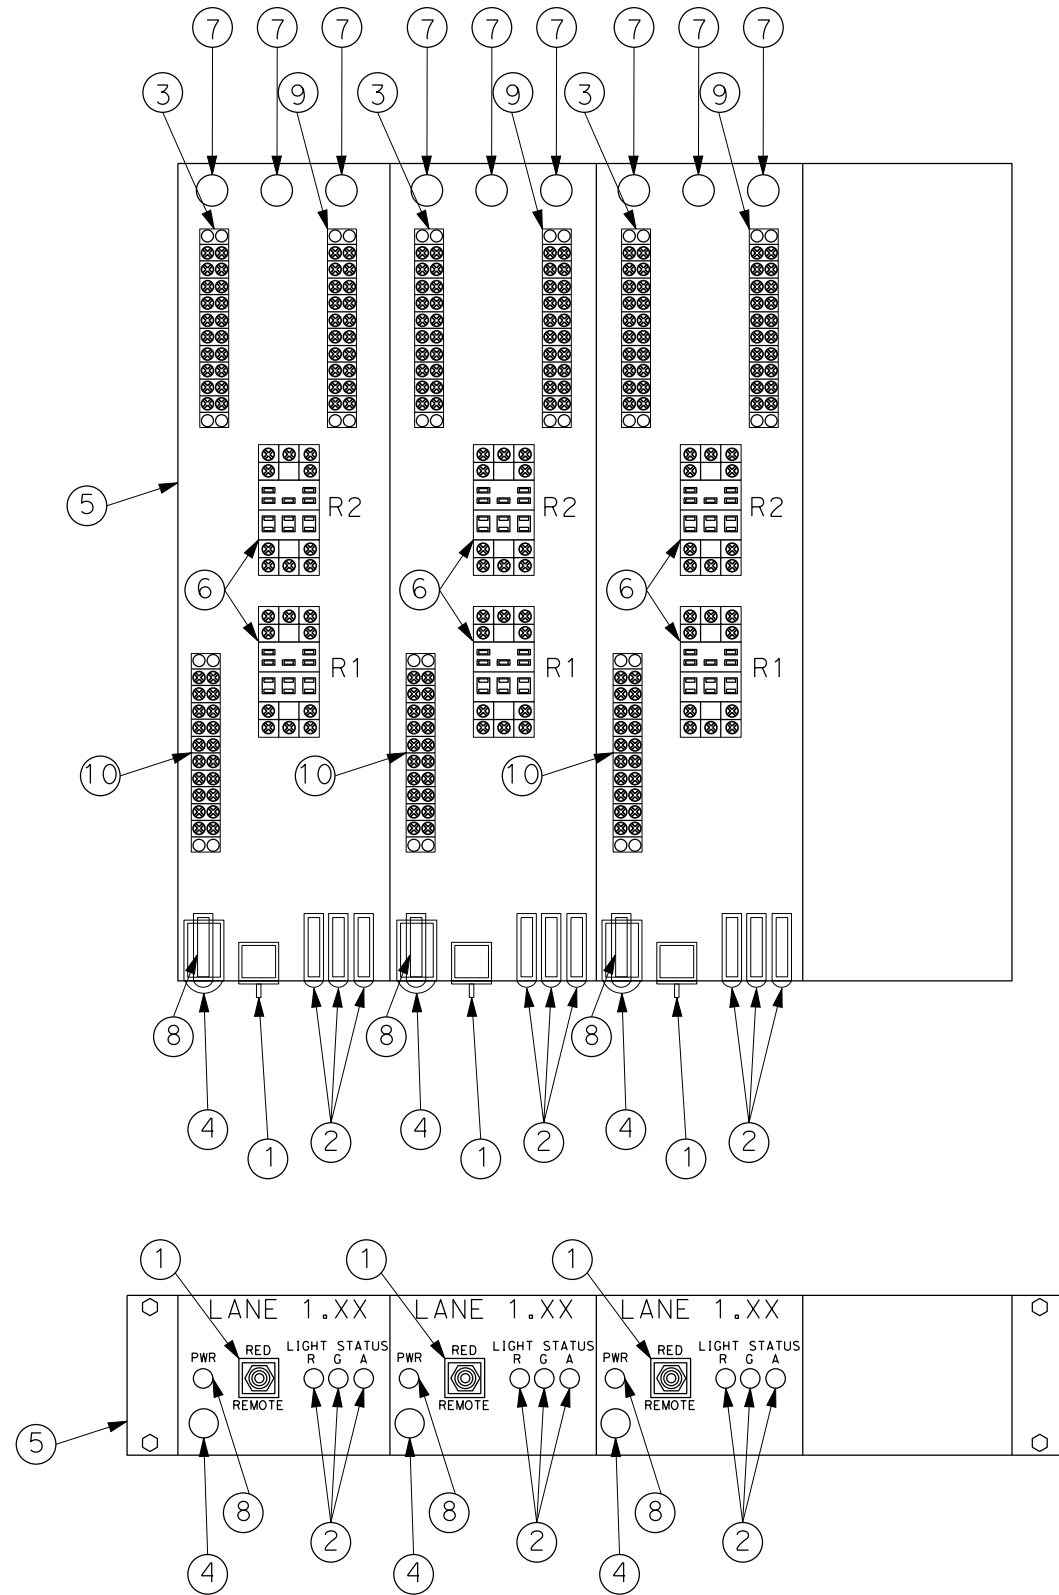
CHECKED BY

DATE REVISED

BORDER LAST REVISED 2/1/2008

ITEM	COMPONENT
①	ONE (1) NEW PANEL MOUNT DPDT TOGGLE SWITCH
②	NEW PANEL MOUNT RED, GREEN, AMBER LED INDICATOR LIGHTS (120VAC)
③	TERMINAL BLOCKS FOR INDICATOR LIGHT CANOPY CABLE AND POWER
④	ONE (1) NEW PANEL MOUNT 1/2 AMP PUSH BUTTON BREAKER (120 VAC)
⑤	INSTALL NEW PULL OUT DRAWER FOR WIRING OF NEW INDICATOR LIGHT RELAYS.
⑥	TWO (2) NEW DPDT RELAYS
⑦	DRILLED HOLES AT BOTTOM OF DRAWER FOR INDICATOR LIGHT CABLE
⑧	NEW PANEL MOUNT BLUE LED INDICATOR LIGHT (120VAC) FOR POWER INDICATION
⑨	TERMINAL BLOCKS FOR INDICATOR LIGHT BOOTH CABLE
⑩	TERMINAL BLOCKS FOR INDICATOR LIGHT PANEL CABLE

TOP VIEW



FRONT VIEW

# INDICATOR LIGHT CABINET DRAWER LAYOUT (ANTIOCH BRIDGE)

NO SCALE

E-16

SHEET	OF
16	16

USERNAME => \$USER  
DGN FILE => \$REQUEST

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Dist	COUNTY	ROUTE	POST MILES TOTAL PROJECT	SHEET No.	TOTAL SHEETS
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REGISTERED CIVIL ENGINEER			3/12/10 DATE	REGISTERED PROFESSIONAL ENGINEER RAMSEY J. HISEN No. C-39608 Exp. 12/31/10 CIVIL STATE OF CALIFORNIA	
PLANS APPROVAL DATE					
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## NOTES:

1. ALL EQUIPMENT SHALL BE SECURED. NO EQUIPMENT WILL BE LAYING IN BOTTOM OF CABINET. INSTALLATION SHALL BE NEAT, DRESSED AND ACCORDING TO THE PLANS.
2. CONTRACTOR SHALL SUBMIT MATERIAL SUBMITTALS FOR ALL CABINET COMPONENTS TO THE ENGINEER FOR REVIEW AND APPROVAL PRIOR TO PROCUREMENT AND INSTALLATION.
3. INDICATOR LIGHT CABLES TO BE WIRED ACCORDING TO THE INDICATOR LIGHT WIRING DIAGRAM AS SHOWN ON SHEET E-13.
4. INDICATOR LIGHT DRAWER LAYOUT SHOWN FOR TYPICAL CMS CABINET.
5. ROUTE ALL CABLES THROUGH DRILLED HOLES AT BOTTOM OF DRAWER. INCLUDE PLASTIC GROMMETS IN HOLE.
6. TERMINATE ALL CABLES ON NEW TERMINATION BLOCKS.
7. FASTEN ALL CABLES TO DRAWER TO PREVENT STRAINING ON TERMINATION BLOCKS.
8. EACH CABINET DRAWER SHALL BE DESIGNED TO ACCOMMODATE UP TO FOUR (4) INDICATOR CONTROL LANES.
9. CONTRACTOR TO LEAVE AT LEAST ONE RACK UNIT OF SPACE BETWEEN DRAWER AND BOTTOM OF CABINET.

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DIST	COUNTY	ROUTE	POST MILES TOTAL PROJECT	SHEET No	TOTAL SHEETS
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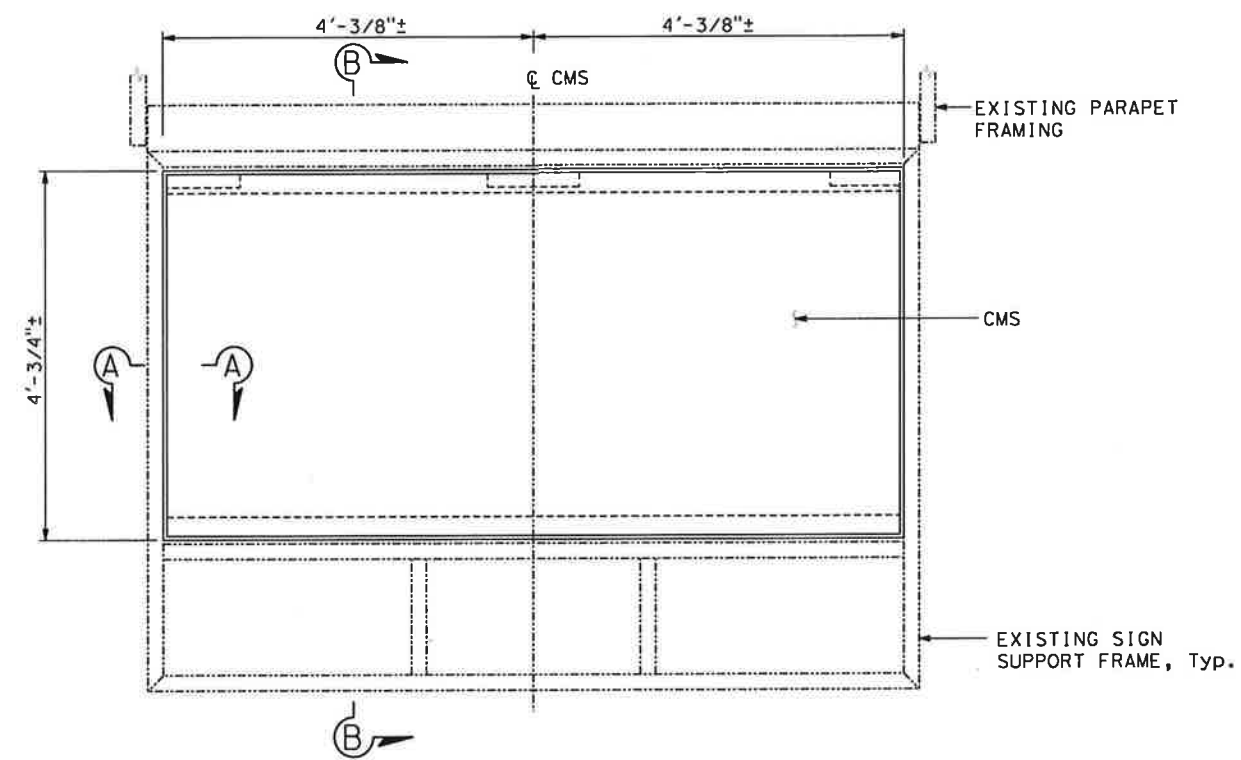
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PLANS APPROVAL DATE


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101 EIGHTH STREET  
OAKLAND, CALIFORNIA 94607

MGE ENGINEERING, INC.  
7415 GREENHAVEN DRIVE, SUITE 100  
SACRAMENTO, CALIFORNIA 95831




**CMS SUPPORT ELEVATION**  
1"=1'-0"

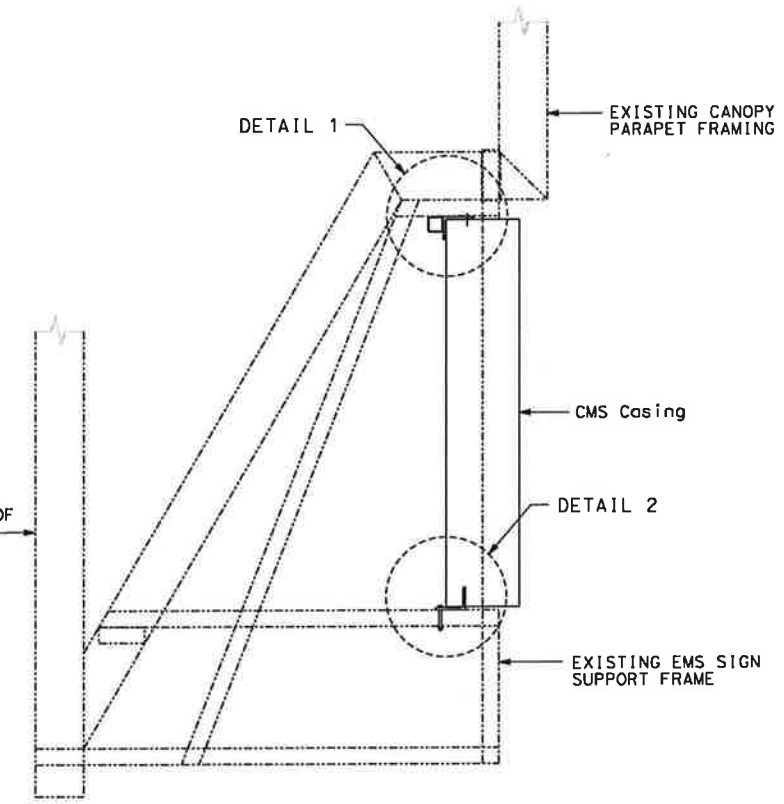


**SECTION B-B**  
1"=1'-0"

Note:  
For location and number of new CMS panels, see Layout Sheet L-5.


Legend:  
————— Indicates New Structure  
- - - - - Indicates Exist Structure

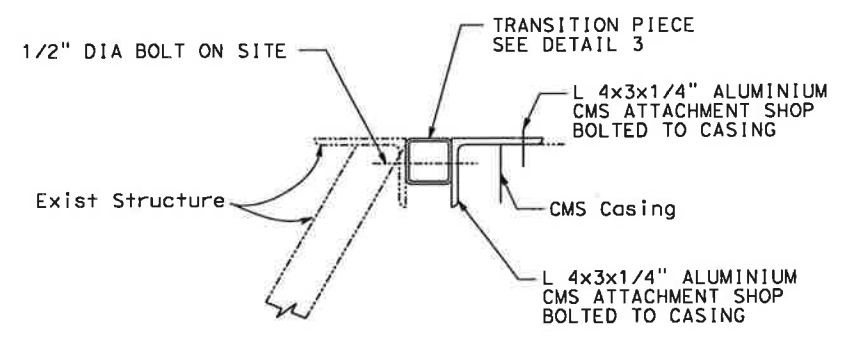

**DETAIL 1**  
3"=1'-0"

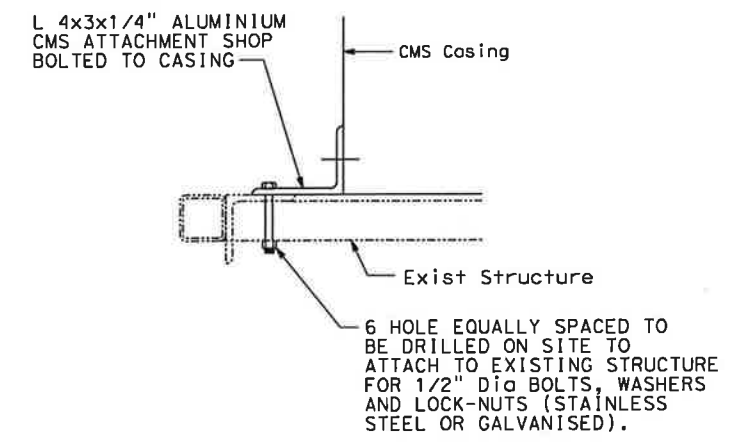

**DETAIL 2**  
3"=1'-0"

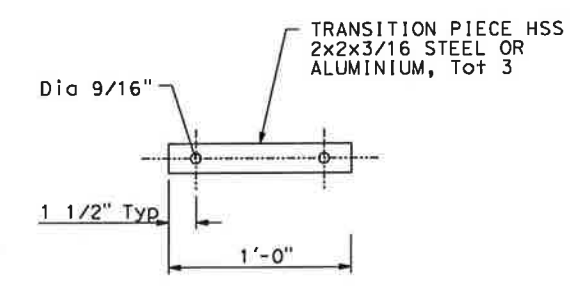

**DETAIL 3**  
2"=1'-0"

Note:  
The Contractor shall verify all controlling field dimensions before ordering or fabricating any material.

DESIGN OVERSIGHT	DESIGN	BY	G. Xu	CHECKED	PREPARED FOR THE STATE OF CALIFORNIA DEPARTMENT OF TRANSPORTATION	Guoping Xu PROJECT ENGINEER	BRIDGE NO.	CARQUINEZ BRIDGE	SHEET S-1										
		DETAILS	BY	E. Garnica			CHECKED			POST MILE									
		QUANTITIES	BY				CHECKED			0.63									
SIGN OFF DATE						CU EA	DISREGARD PRINTS BEARING EARLIER REVISION DATES	REVISION DATES (PRELIMINARY STAGE ONLY)					SHEET	OF					
DESIGN DETAIL SHEET (ENGLISH) (REV. 2/25/05)							ORIGINAL SCALE IN INCHES FOR REDUCED PLANS						0	1	2	3	1	1	
										FILE => ...\\Structural\\carr_CMS-1.dgn									



STATE OF CALIFORNIA - DEPARTMENT OF TRANSPORTATION	CONSULTANT FUNCTIONAL SUPERVISOR				
<b>CT Caltrans®</b>		CALCULATED-DESIGNED BY	REVISOR BY		
		CHECKED BY	DATE REVISED		


PROJECT NOTES:

- 1) INSTALL NEW CAT-5e CABLE IN EXISTING CONDUIT.
- 2) REMOVE AND DISPOSE OF EXISTING GREEN, BLACK, & WHITE CABLES.
- 3) INSTALL NEW TYPE 2 (2 1/2" C) CONDUIT.
- 4) RE-USE AT (E) PANEL-D THE (E) 20A-1P CIRCUIT BREAKER #36 FOR NEW CMS CONTROLLER RACK.
- 5) INSTALL NEW TYPE 1 (3/4" C) CONDUIT WITH 2 #12 & 1 #12G (120V, CMS) FROM (E) PANEL-D TO NEW CMS CABINET. PROVIDE CONDUIT SUPPORT EVERY 5 FT. O.C. MAX.
- 6) CORE DRILL (E) CONCRETE SLAB.
- 7) INSTALL NEW TYPE 1 (1" C) CONDUIT.
- 8) INSTALL TYPE 3 JUNCTION BOX AS SPECIFIED IN CONTRACT DOCUMENTS. SECURE PULL BOX TO CANOPY ROOF.
- 9) INSTALL NEW TYPE 2 (1" C) CONDUIT WITH 4 #12 & 1 #12G (120V, CMS SIGNS).
- 10) ALL WALL, CEILING AND FLOOR CONCRETE PENETRATIONS SHALL BE CORE-DRILLED AS DIRECTED AND APPROVED BY CALTRANS SUFFICIENTLY LARGE TO ACCOMMODATE CONDUIT PLUS FLUSH MOUNTED END BELL. ALL CORE-DRILLS SHALL BE MADE WATER-TIGHT, SEALED AROUND CONDUIT PER CALTRANS REQUIREMENTS WITH FAST-SETTING EPOXY RESIN THROUGHOUT THE DEPTH OF HOLE.
- 11) INSTALL NEW INDICATOR LIGHT CANOPY CABLE.
- 12) INSTALL NEW INDICATOR LIGHT BOOTH CABLE.
- 13) INSTALL NEW INDICATOR LIGHT CONSOLE CABLE.
- 14) INSTALL NEW CMS COMM CABLE.
- 15) INSTALL NEW TYPE 4 (1" C) CONDUIT WITH 2 #12 & 1 #12G (120V, CMS SIGN).
- 16) (E) CMS WORKSTATION TO REMAIN.
- 17) INSTALL NEW TYPE 4 (1 1/2" C) CONDUIT.
- 18) INSTALL NEW 14 #12 & 7 #12G (120V, CMS SIGNS).
- 19) (E) FDU TO REMAIN.
- 20) REMOVE AND DISPOSE OF EXISTING INDICATOR LIGHT CABLE.
- 21) INSTALL NEW CMS PANEL AS SPECIFIED IN CONTRACT DOCUMENTS.
- 22) INSTALL NEW SEVEN (7) 15A-1P CIRCUIT BREAKERS AT (E) PANEL-CMS IN (E) SPACES 11,13,15,10,12,14 AND 16 (FOR CMS SIGNS 6,7,8,9,10,11 AND 12).
- 23) ROUTE NEW CABLES THROUGH EXISTING CONDUIT.
- 24) MODIFY EXISTING GREEN INDICATOR LIGHT AND REPLACE WITH GREEN/FLASHING AMBER LED INDICATOR BULB. REPLACE EXISTING RED INDICATOR LIGHT WITH RED LED INDICATOR BULB. IF EXISTING RED INDICATOR LIGHT IS LED, FURNISH NEW RED LED INDICATOR BULB TO BATA ASA SPARE.
- 25) INSTALL NEW TYPE 2 (1 1/2" C) CONDUIT.

- 26) INSTALL NEW TYPE 2 (1 1/4" C) CONDUIT WITH 6 #12 & 3 #12G (120V, CMS SIGN)
- 27) ROUTE NEW CMS COMM CABLE THROUGH EXISTING JUNCTION BOX.
- 28) INSTALL NEW TYPE 3 EQUIPMENT RACK FOR LANES 6-12 AS SPECIFIED IN CONTRACT DOCUMENTS.
- 29) INSTALL INDICATOR LIGHT SWITCH CONSOLE PANEL.
- 30) REMOVE EXISTING INDICATOR LIGHT SWITCH IN TOLL BOOTH.
- 31) INSTALL NEW CMS CONTROLLERS. ROUTE CAT-5E PATCH CABLES FROM EACH CMS CONTROLLER TO NEW ETHERNET SWITCH IN EXISTING CMS CABINET.
- 32) INSTALL NEW TYPE 1 (2" C) CONDUIT.
- 33) INSTALL NEW TYPE 2 (2" C) CONDUIT.
- 34) INSTALL TYPE 1 JUNCTION BOX AS SPECIFIED IN CONTRACT DOCUMENTS.
- 35) INSTALL NEW TYPE 1 (1 1/2" C) CONDUIT.
- 36) INSTALL NEW TYPE 1 (2 1/2" C) CONDUIT.
- 37) INSTALL NEW TYPE 2 (1" C) WITH 2 #12 & 1 #12G (120V, CMS SIGN)
- 38) INSTALL NEW TYPE 4 (2" C) CONDUIT
- 39) INSTALL AND TERMINATE INDICATOR LIGHT CABLES TO NEW TERMINAL BLOCKS AND WIRE TO SWITCH PANEL AS SHOWN IN PLANS AND APPROVED BY THE ENGINEER.
- 40) INSTALL LB FITTING.
- 41) INSTALL NEW LED PUSH BUTTON INDICATOR BOX.
- 42) PROVIDE NEW REVISED (TYPED WRITTEN) PANEL SCHEDULE.
- 43) INSTALL NEW TYPE 4 (1" C) CONDUIT.
- 44) INSTALL NEW TYPE 1 (1 1/2" C) CONDUIT.
- 45) REPLACE EXISTING RED INDICATOR LIGHT WITH NEW RED LED INDICATOR BULB. IF EXISTING RED INDICATOR LIGHT IS LED, FURNISH NEW RED LED INDICATOR BULB TO BATA AS A SPARE.

Dist	COUNTY	ROUTE	POST MILES TOTAL PROJECT	SHEET TOTAL SHEETS	TOTAL SHEETS
04	Soi	80	0.63	35	123




REGISTERED CIVIL ENGINEER

3/12/10  
DATE

PLANS APPROVAL DATE

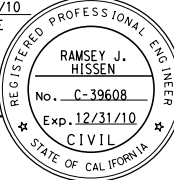

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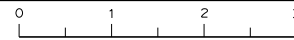
  

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## PROJECT NOTES (CARQUINEZ BRIDGE)



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SHEET	OF	LAST REVISION
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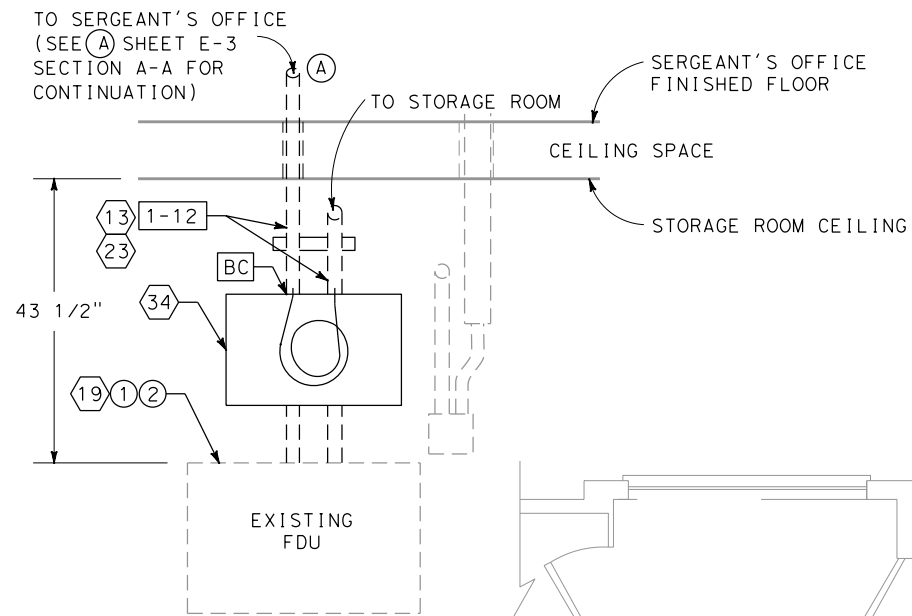






Dist	COUNTY	ROUTE	POST MILES TOTAL PROJECT	SHEET NO.	TOTAL SHEETS
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PLANS APPROVAL DATE _____					
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SHEET NOTES:

- ① CONTRACTOR TO DISCONNECT EXISTING FIBER CABLES AND JUMPER CABLES AND PULL BACK TO CUT IN NEW TYPE 1 JUNCTION BOX. INSTALL NEW CHANNEL STRUTS ABOVE NEW JUNCTION BOX AND SECURE CONDUITS TO WALL.
- ② CONTRACTOR TO RE-TERMINATE FIBER AND JUMPER CABLES AND ROUTE NEW INDICATOR LIGHT CONSOLE CABLES THROUGH EXISTING 2" CONDUIT AND UP TO NEW INDICATOR LIGHT SWITCH CONSOLE PANEL THROUGH EXISTING 1 1/2" CONDUIT TO SEARGENTS OFFICE.



SECTION A- A  
CONDUIT ELEVATION  
(STORAGE ROOM TO SERGEANT'S OFFICE)

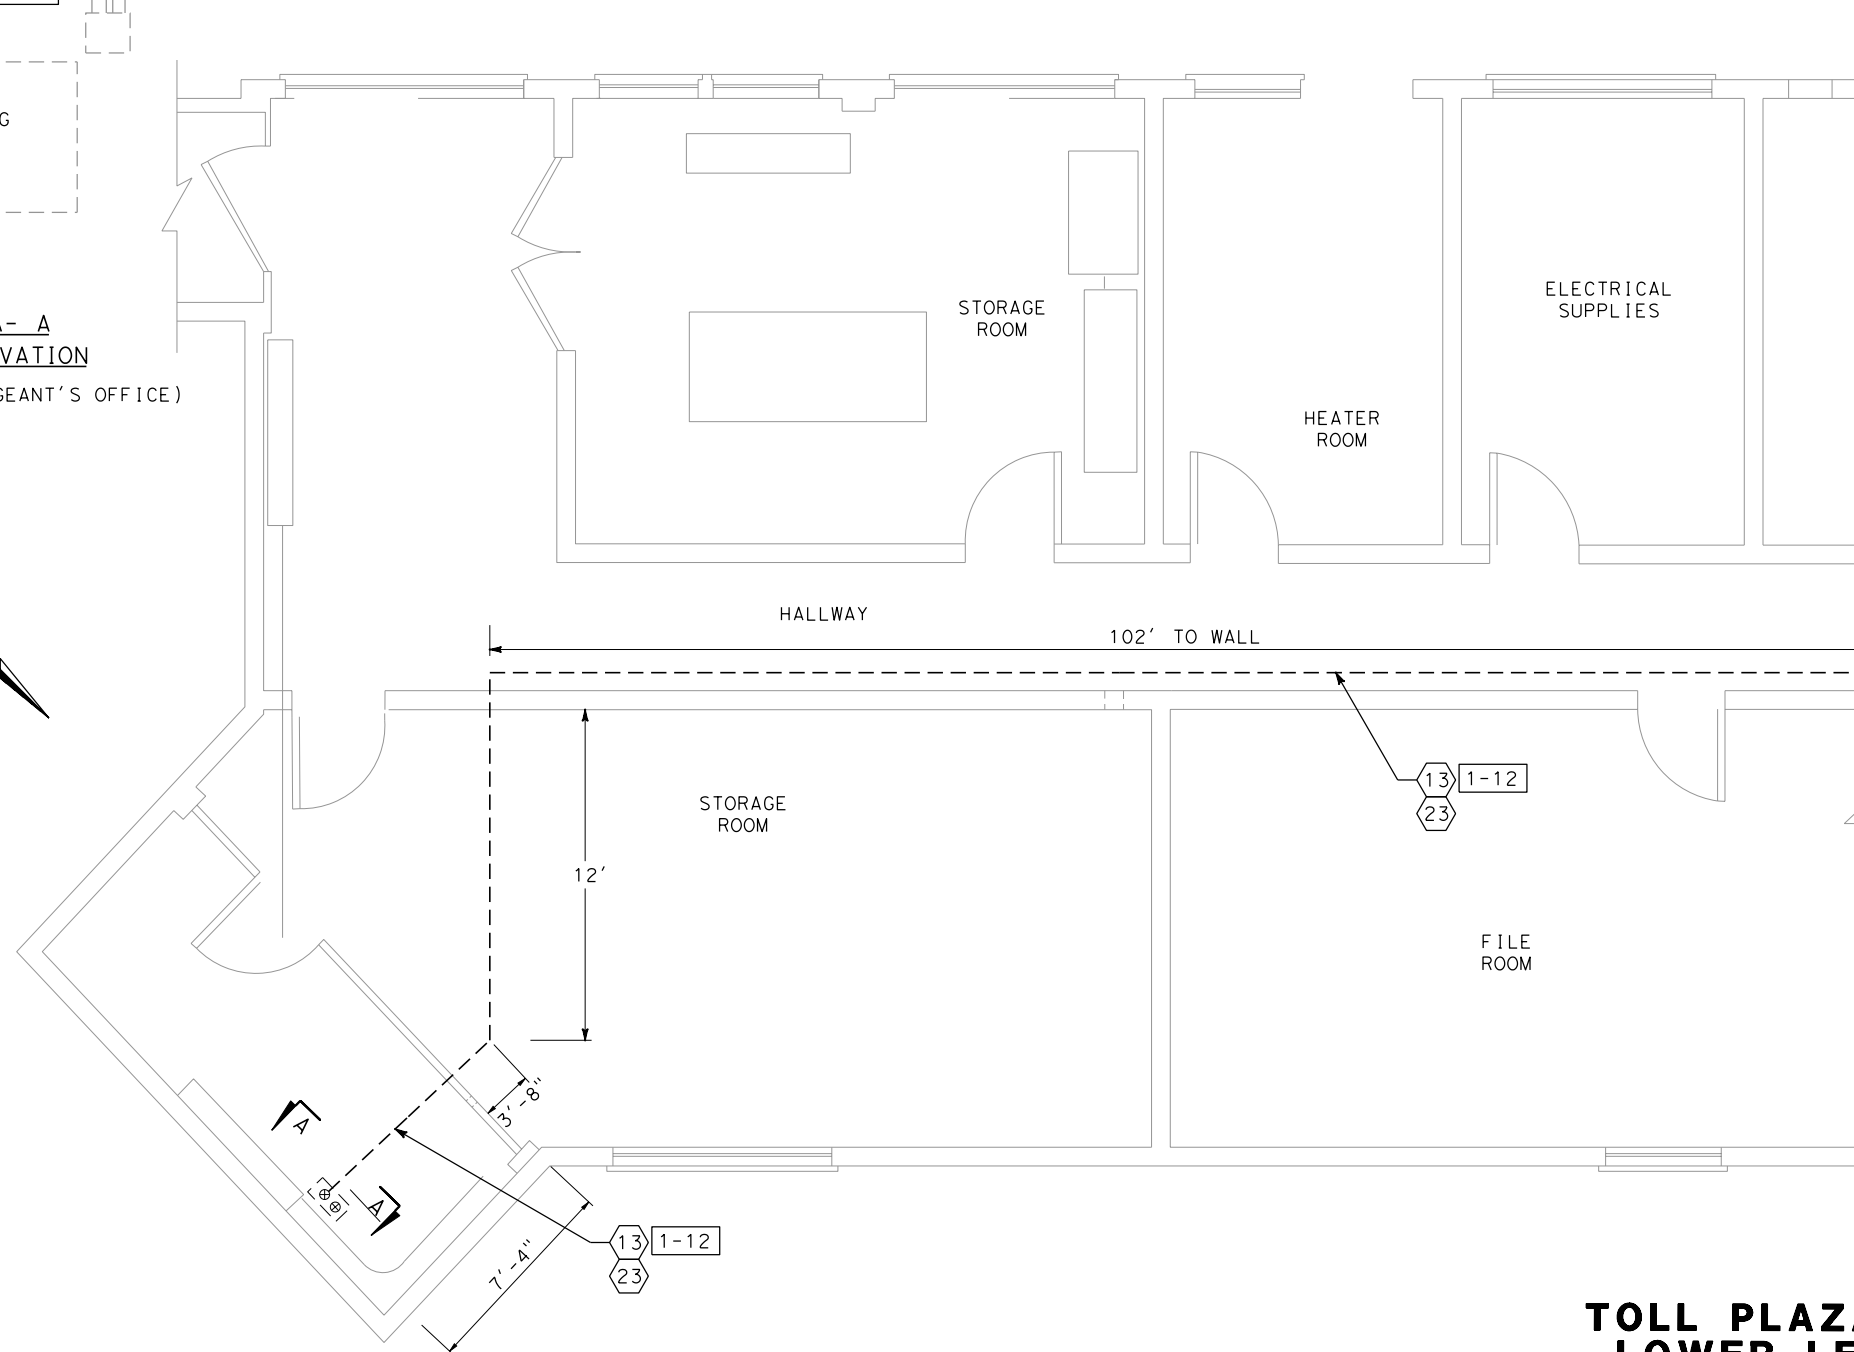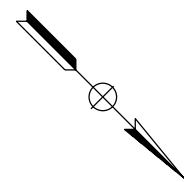

BASEMENT - PARTIAL FLOOR PLAN VIEW

# TOLL PLAZA OPERATIONS BUILDING LOWER LEVEL CONDUIT ROUTING (CARQUINEZ BRIDGE)

NO SCALE

**E - 4**


SHEET	OF
4	19

DATE PLOTTED => \$DATE	TIME PLOTTED => \$TIME
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#REQUEST	STATE OF CALIFORNIA - DEPARTMENT OF TRANSPORTATION	CONSULTANT FUNCTIONAL SUPERVISOR	CALCULATED-DESIGNED BY	CHECKED BY	REVISED BY	DATE REVISED

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BASEMENT - PARTIAL PLAN VIEW


TOLL PLAZA OPERATIONS BUILDING  
LOWER LEVEL CONDUIT ROUTING  
(CARQUINEZ BRIDGE)

NO SCALE

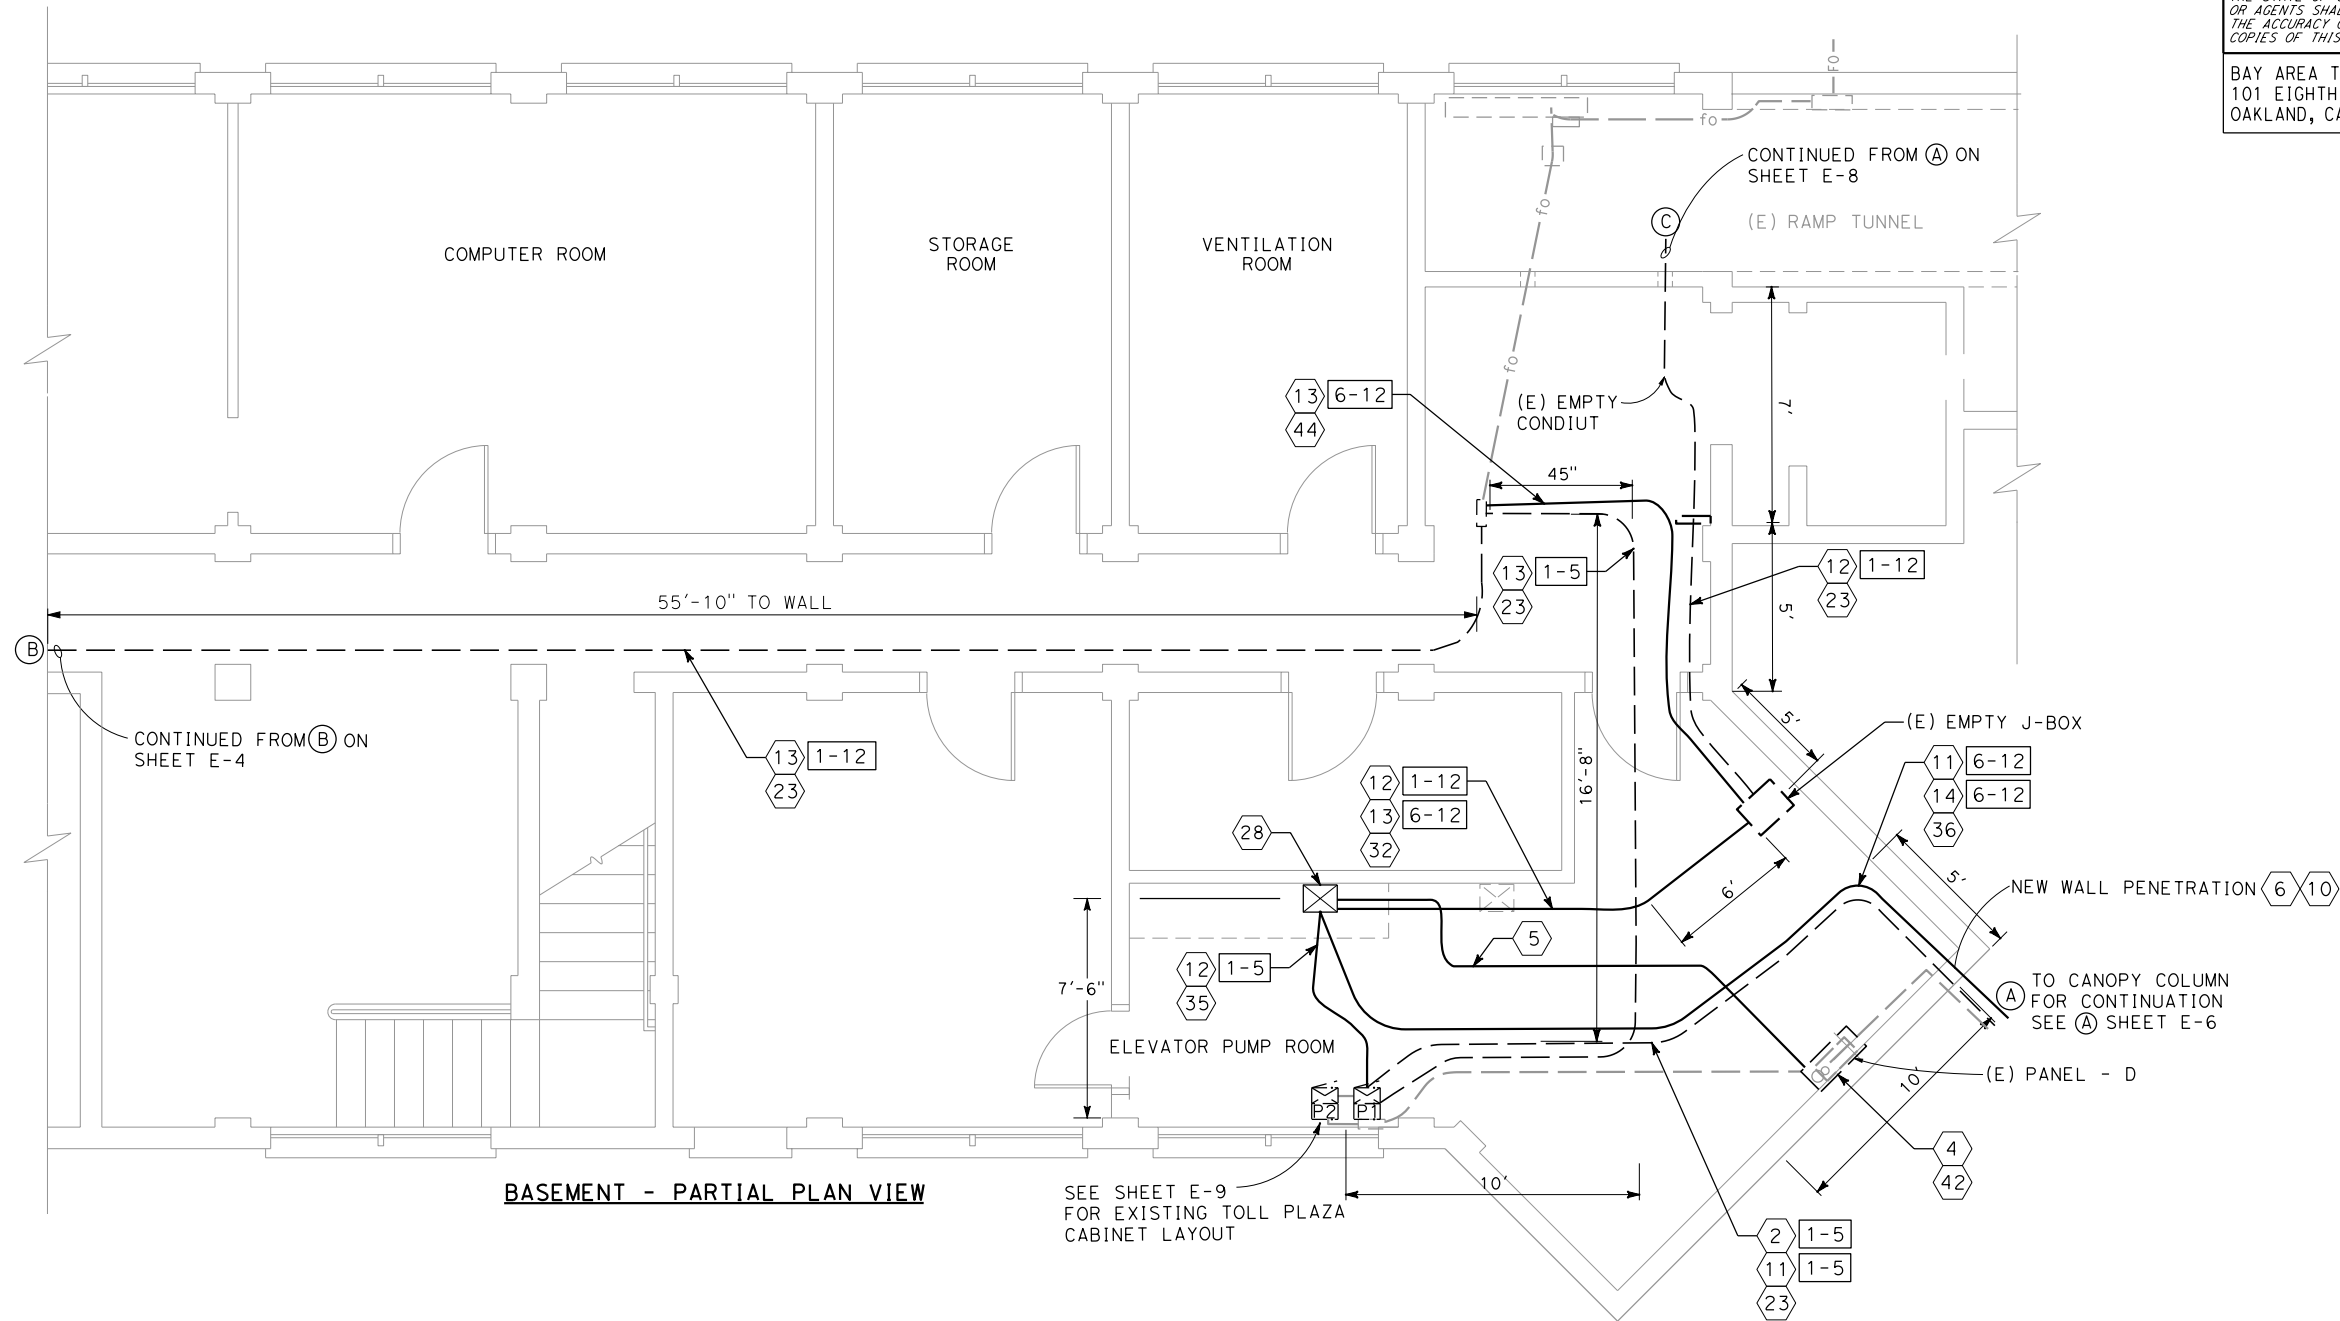E-5

SHEET	OF
5	19

DIST	COUNTY	ROUTE	POST MILES TOTAL PROJECT	SHEET NO.	TOTAL SHEETS
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REGISTERED CIVIL ENGINEER

3/12/10  
DATE



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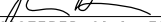
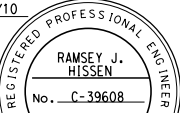
STATE OF CALIFORNIA

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101 EIGHTH STREET  
OAKLAND, CA 94607





URS CORPORATION  
55 S. MARKET STREET  
SUITE 1500  
SAN JOSE, CA 95113



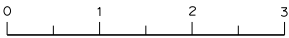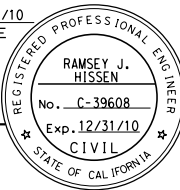

Dist	COUNTY	ROUTE	POST MILES TOTAL PROJECT	SHEET No.	TOTAL SHEETS
04	Soi	80	0.63	40	123
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PLANS APPROVAL DATE					
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- ## SHEET NOTES:
- ① ABANDONED EXISTING CONDUIT IN PLACE.
  - ② CONTRACTOR TO SUPPLY CONDUIT SUPPORT.
  - ③ FINAL LOCATION OF CONDUIT AND JUNCTION BOX ROUTING AND ATTACHMENT DETAILS SHALL BE COORDINATED BY THE CONTRACTOR WITH THE ENGINEER PRIOR TO INSTALLATION.
  - ④ REMOVE AND SALVAGE EXISTING STATIC SIGNS IN LANES 1-3 AND INSTALL NEW CMS PANELS.
  - ⑤ SEE SHEET S-1 FOR CMS PANEL MOUNTING TO CANOPY DETAILS.

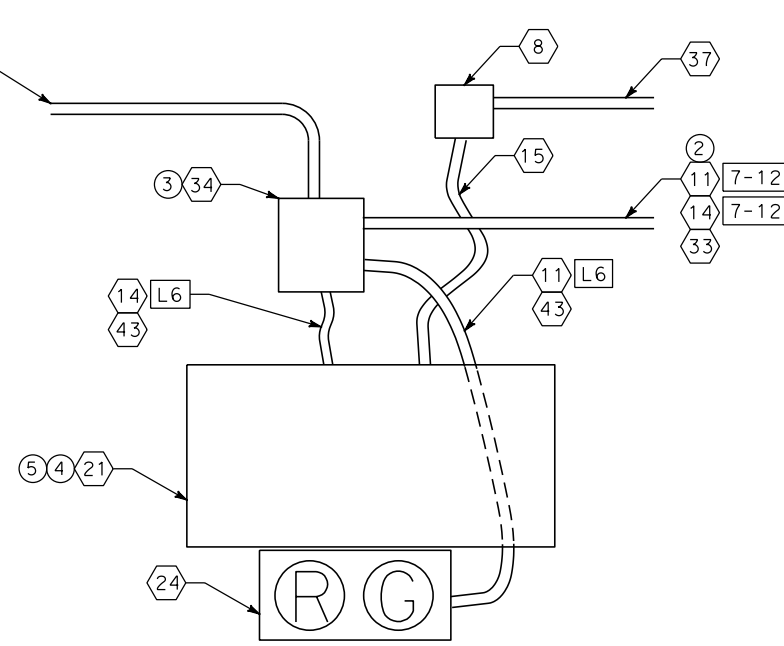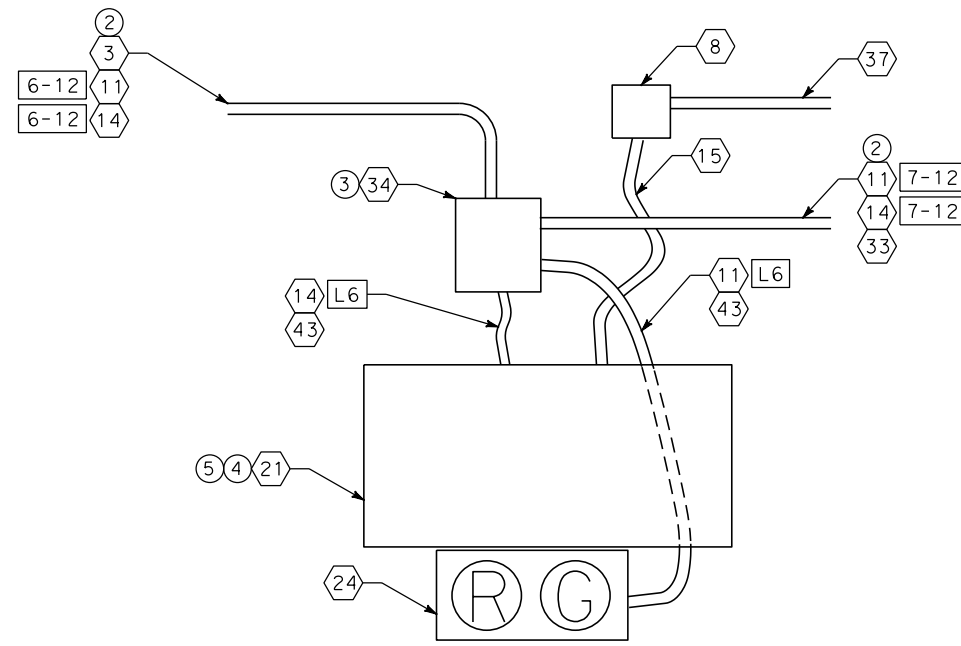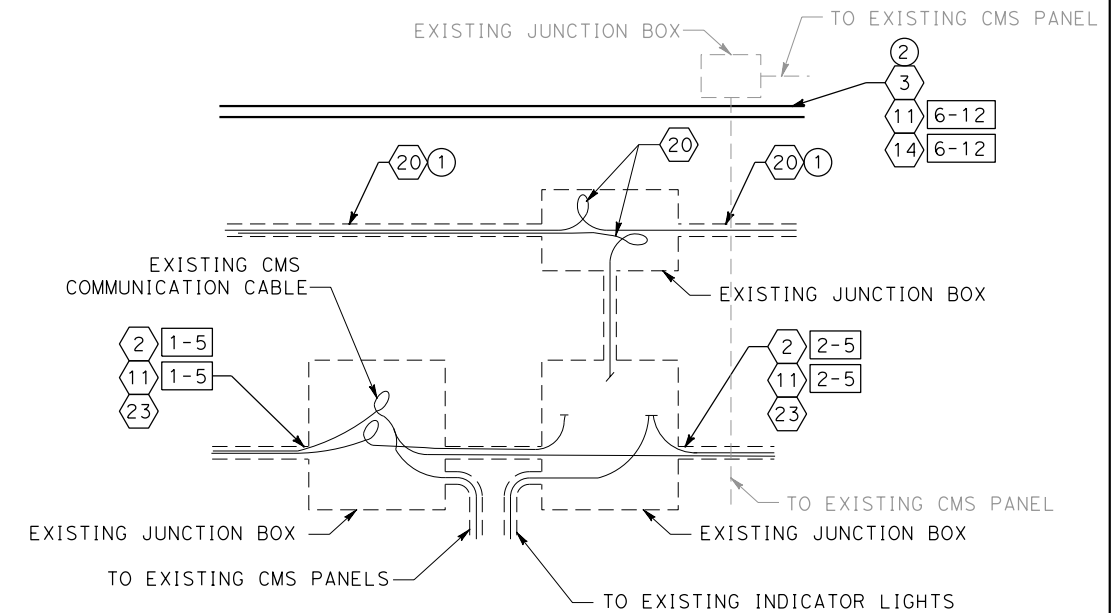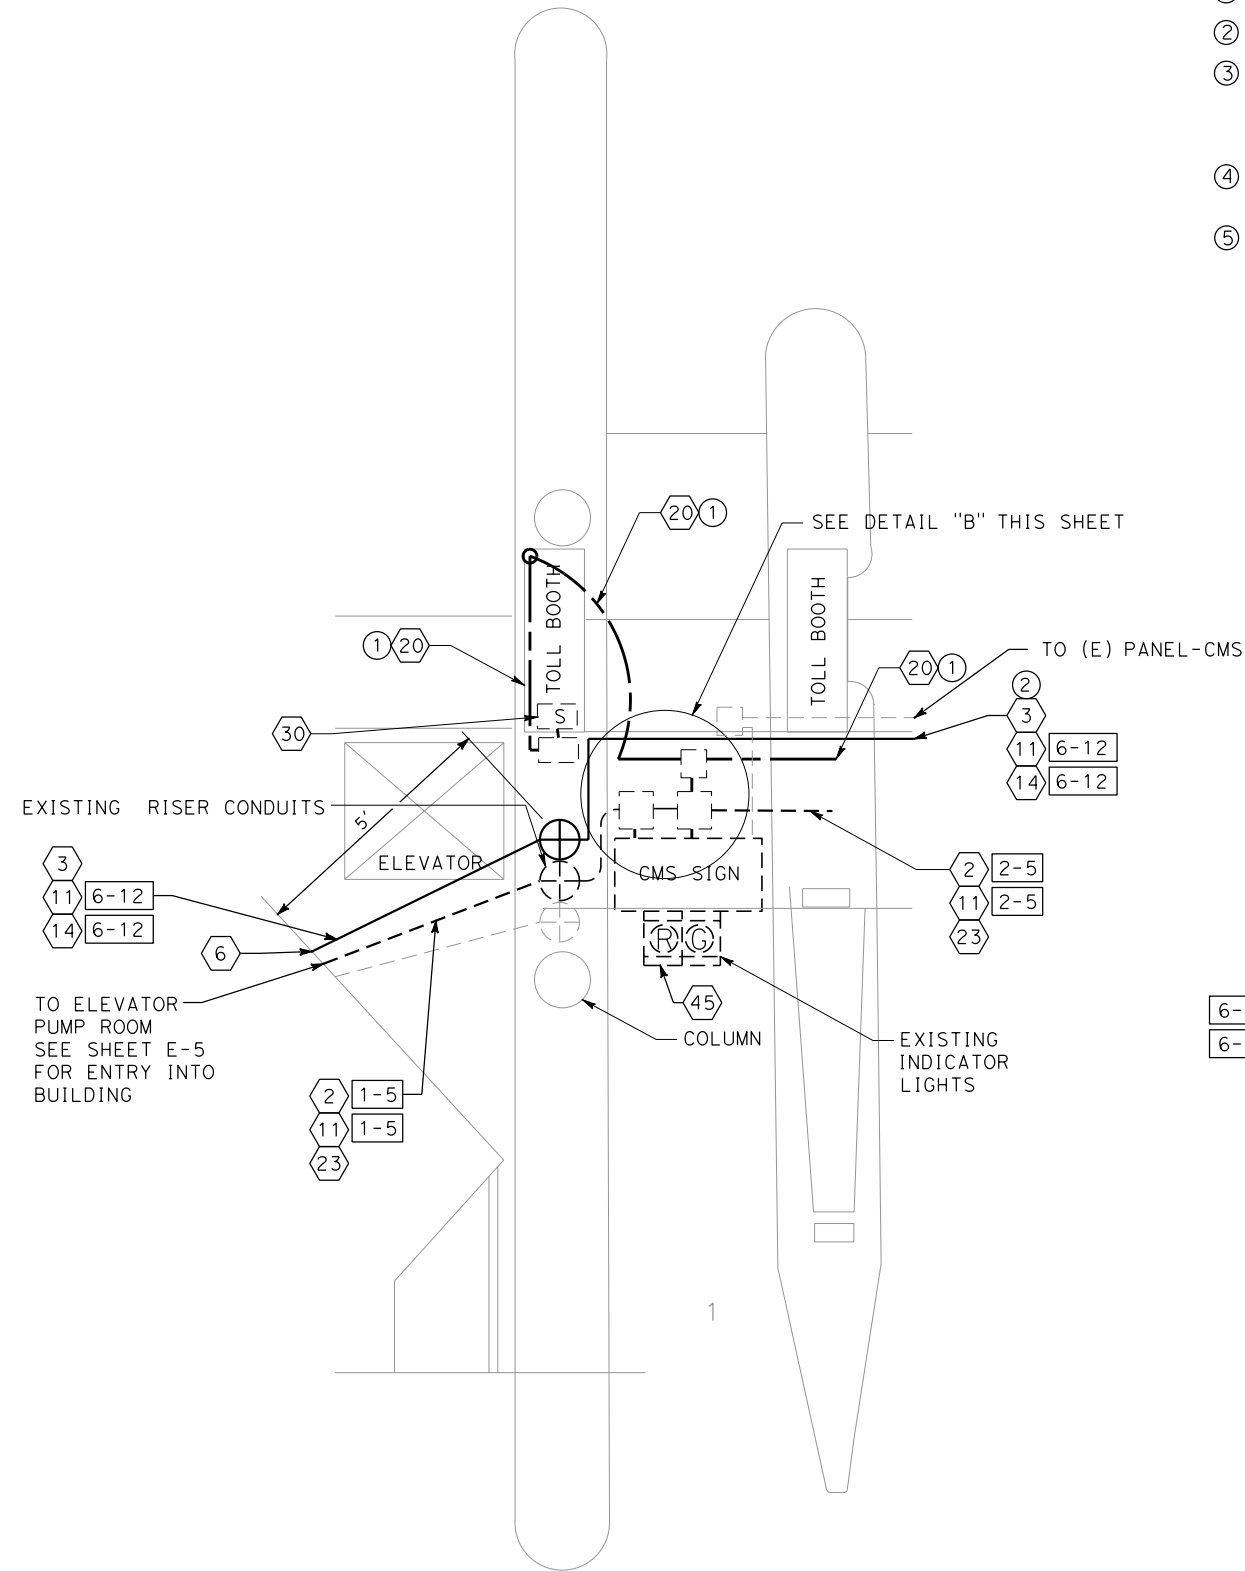

## TOLL PLAZA OPERATIONS BUILDING CONDUIT ROUTING DETAILS (CARQUINEZ BRIDGE)





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\$#REQUEST

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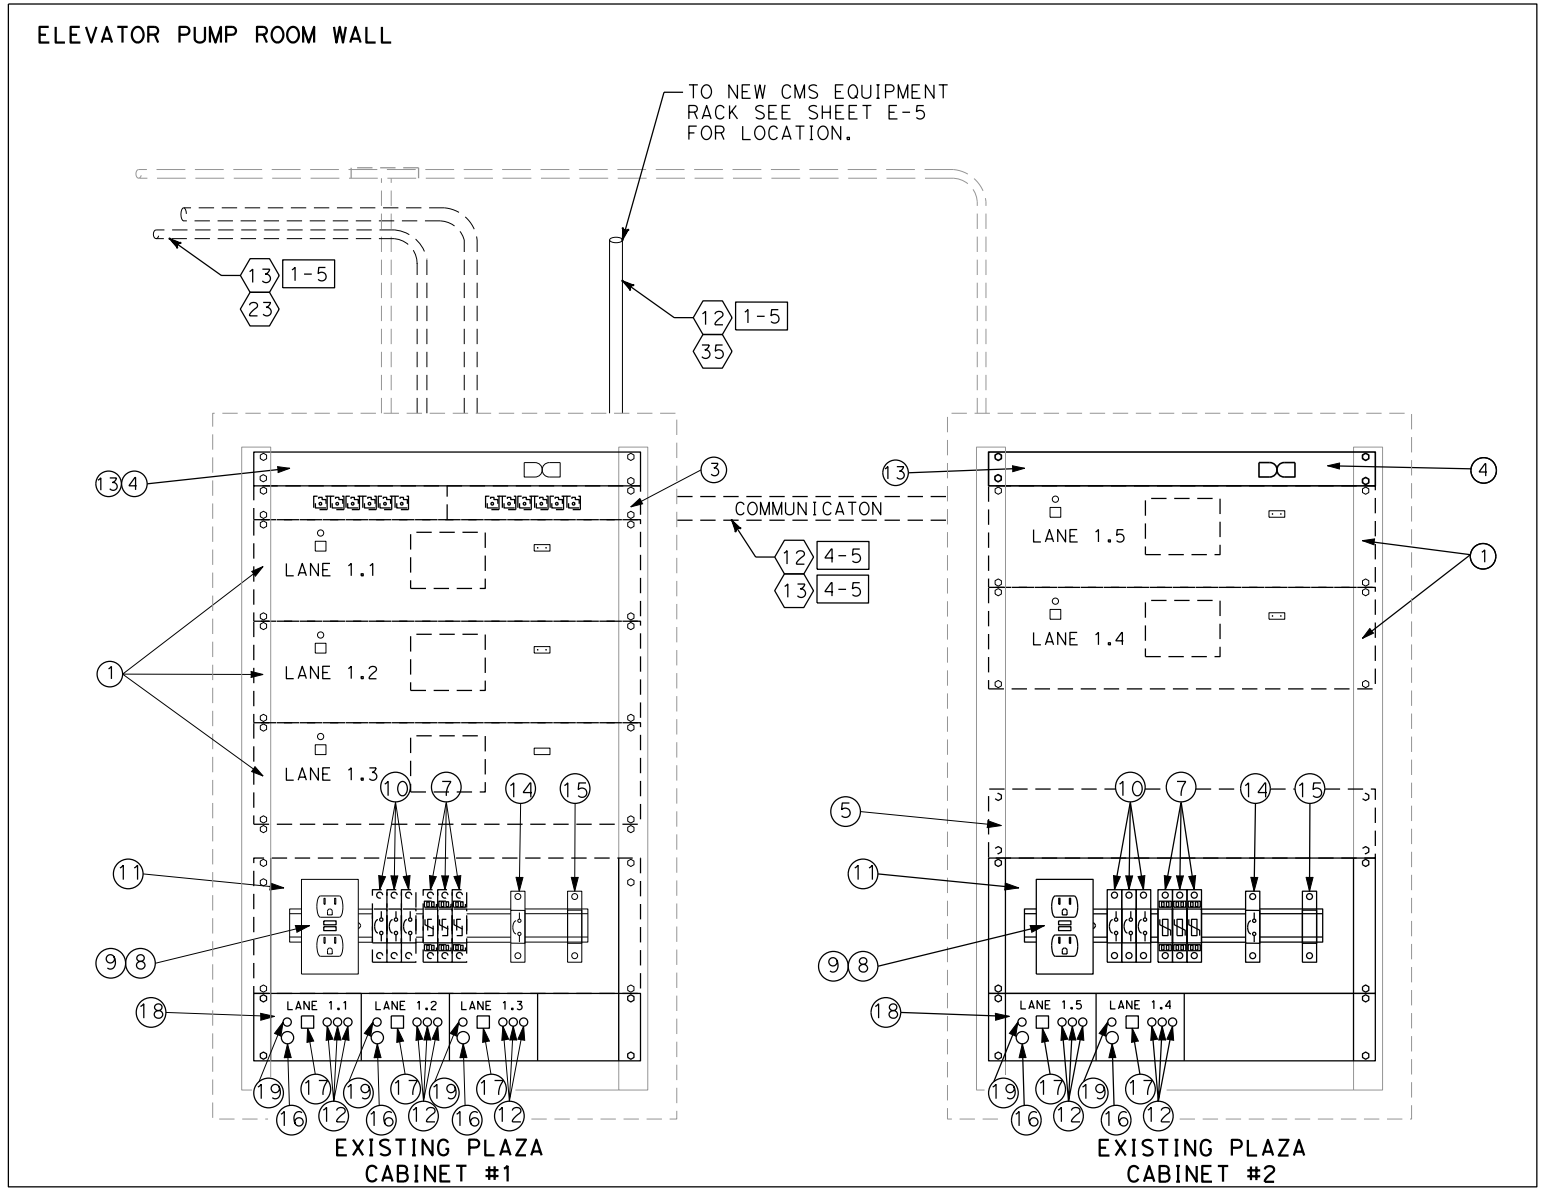
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DATE REVISED

ITEM	COMPONENT
①	REMOVE/REPLACE EXISTING CMS CONTROLLERS WITH NEW CMS CONTROLLERS.
②	REMOVE EXISTING ETHERNET SWITCH AT CABINET BOTTOM AND FURNISH AND INSTALL NEW RACK MOUNTABLE SWITCH WITH 14-10/100BASE-T AND 2-100BASE-FX(SM) PORTS. FIBER PORT TO MATCH EXISTING. INSTALL NEW SWITCH RIGHT UNDER CMS CONTROLLER (RACK MOUNTED-NO SHELVES).
③	EXISTING PLAZA F.O. PATCH PANEL.
④	REMOVE/REPLACE EXISTING POWER STRIP WITH NEW RACK MOUNTABLE IP ADDRESSABLE POWER STRIP.
⑤	EXISTING UPS TO BE REMOVED

ITEM	COMPONENT
⑥	NEW ELECTRICAL PANEL
⑦	EXISTING DATA TVSS TO BE REMOVED.
⑧	NEW 15 AMP GFI OUTLET
⑨	REMOVE EXISTING 15 AMP OUTLET
⑩	REMOVE EXISTING 1/4 AMP BREAKERS.
⑪	EXISTING ELECTRICAL PANEL
⑫	NEW PANEL MOUNT RED, GREEN, AMBER LED INDICATOR LIGHTS (120VAC)
⑬	MOVE EXISTING EQUIPMENT TO ACCOMODATE NEW CABINET LAYOUT.
⑭	ONE (1) NEW 2 AMP BREAKER (120 VAC)

ITEM	COMPONENT
⑮	ONE (1) NEW NEC CLASS 3, 100 WATT 1:1, 120 VAC TRANSFORMER
⑯	ONE (1) NEW PANEL MOUNT 1/2 AMP PUSH BUTTON BREAKER (120 VAC)
⑰	ONE (1) NEW PANEL MOUNT DPDT TOGGLE SWITCH
⑱	INSTALL NEW PULL OUT DRAWER FOR WIRING OF NEW INDICATOR LIGHT RELAYS. SEE SHEET E-20 FOR CABINET DRAWER LAYOUT.
⑲	NEW PANEL MOUNT BLUE LED INDICATOR LIGHT (120 VAC) FOR POWER INDICATION



DETAIL A  
EXISTING TOLL PLAZA CABINET ELEVATION

CMS PLAZA CABINET ELEVATION  
VIEW FOR LANES 1-5  
(CARQUINEZ BRIDGE)


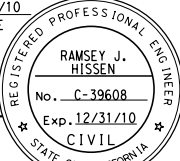
NO SCALE

E-9

SHEET	OF
9	19

NOTES:

- EQUIPMENT TO MEET CALTRANS TEES REQUIREMENTS.
- REMOVED EQUIPMENT AND MATERIALS SHALL BE RETURNED TO BATA.
- ALL EQUIPMENT SHALL BE SECURED. NO EQUIPMENT WILL BE LAYING IN BOTTOM OF CABINET. INSTALLATION SHALL BE NEAT, DRESSED AND ACCORDING TO THE PLANS.
- CONTRACTOR SHALL SUBMIT MATERIAL SUBMITTALS FOR ALL CABINET COMPONENTS TO THE ENGINEER FOR REVIEW AND APPROVAL PRIOR TO PROCUREMENT AND INSTALLATION.
- CONTRACTOR TO INSTALL, CONNECT, AND INTEGRATE ALL EQUIPMENT IN CMS CABINETS.
- DO NOT CONNECT POWER STRIP TO GFI. CONNECT TO CABINET POWER SOURCE DIRECTLY BY MEANS OF A SEPERATE NEMA 5-15 SOCKET.
- CONTRACTOR TO LEAVE ONE (1) RACK UNIT OF SPACE AT BOTTOM OF CABINET.
- EXISTING CMS CONTROLLER TO BE REPLACED WITH NEW CONTROLLER. NEW CMS CONTROLLER TO BE PROVIDED BY BATA.

DIST	COUNTY	ROUTE	POST MILES TOTAL PROJECT	SHEET No.	TOTAL SHEETS
04	SoI	80	0.63	42	123
 REGISTERED CIVIL ENGINEER			3/12/10 DATE		
PLANS APPROVAL DATE					
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DATE REVISED


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ITEM	COMPONENT
①	NEW CMS CONTROLLER
②	ONE (1) NEW PANEL MOUNT 1/2 AMP PUSH BUTTON BREAKER (120 VAC)
③	NEW IP ADDRESSABLE POWER STRIP
④	NEW ELECTRICAL PANEL
⑤	NEW 15 AMP GFI OUTLET
⑥	THREE (3) NEW 2 AMP BREAKER (120 VAC)
⑦	THREE (3) NEW NEC CLASS 3, 100 WATT 1:1, 120 VAC TRANSFORMERS

NOTE: CABINET AND EQUIPMENT TO MEET CALTRANS TEES REQUIREMENTS

ITEM	COMPONENT
⑧	INSTALL NEW PULL OUT DRAWER FOR WIRING OF NEW INDICATOR LIGHT RELAYS. SEE SHEET E-19 FOR CABINET DRAWER LAYOUT.
⑨	NEW PANEL MOUNT RED, GREEN, AMBER LED INDICATOR LIGHTS (120VAC)
⑩	ONE (1) NEW PANEL MOUNT DPDT TOGGLE SWITCH
⑪	NEW PANEL MOUNT BLUE LED INDICATOR LIGHT (120VAC) FOR POWER INDICATION

TO NEW CMS PLAZA CABINET #1  
SEE SHEET E-5  
FOR LOCATION.

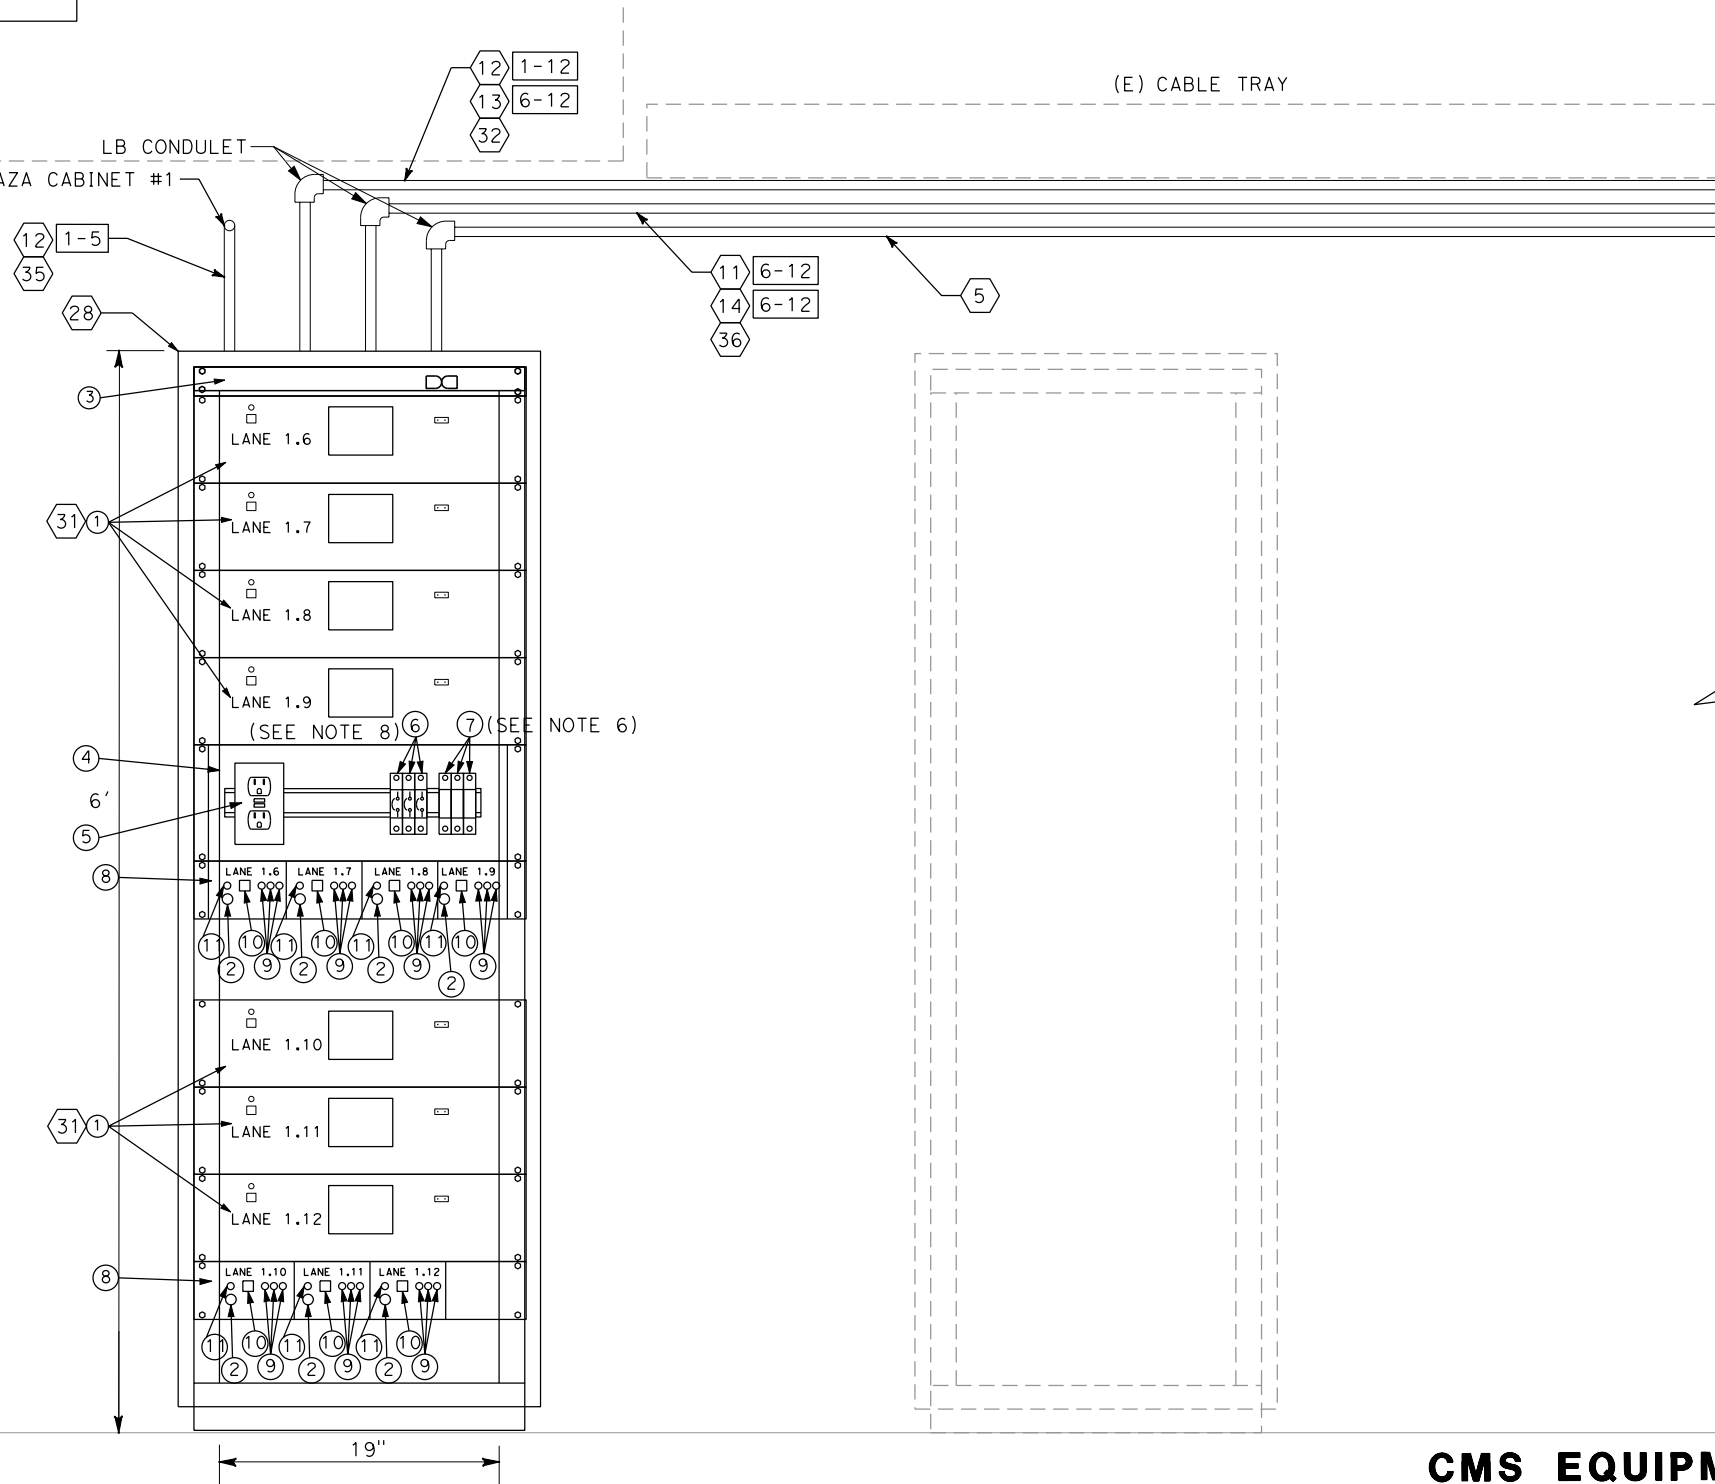

COMPUTER ROOM

## CMS EQUIPMENT RACK LAYOUT FOR LANES 6-12 (CARQUINEZ BRIDGE)

E-10

NO SCALE

Dist	COUNTY	ROUTE	POST MILES TOTAL PROJECT	SHEET NO.	TOTAL SHEETS
04	SoI	80	0.63	43	123

REGISTERED CIVIL ENGINEER 3/12/10 DATE

PLANS APPROVAL DATE

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101 EIGHTH STREET  
OAKLAND, CA 94607

URS CORPORATION  
55 S. MARKET STREET  
SUITE 1500  
SAN JOSE, CA 95113

REGISTERED PROFESSIONAL ENGINEER  
RAMSEY J. HESSEN  
No. C-39608  
Exp. 12/31/10  
CIVIL  
STATE OF CALIFORNIA

### SHEET NOTES:

- ANY EXISTING FURNITURE REQUIRED TO BE RE-ARRANGED FOR PLACEMENT OF CMS EQUIPMENT RACK SHALL BE COORDINATED WITH LIEUTENANT.
- SECURE CONDUIT USING CONDUIT CLAMPS OR CHANNEL STRUTS. SEE SHEET E-18 FOR TYP CONDUIT MOUNTING.
- ALL CABLING IN CMS CABINETS SHALL BE INSTALLED AND NEATLY DRESSED AND SECURED IN CABINETS. SPARE COILED CABLING SHALL BE PROVIDED IN JUNCTION BOXES.
- CONTRACTOR TO INSTALL, CONNECT, AND INTEGRATE ALL EQUIPMENT IN CMS CABINETS (I.E., TRANSFORMERS, BREAKERS, ETC.).
- NEW IP ADDRESSABLE POWER STRIP TO BE RACK MOUNTABLE.
- CONTRACTOR TO CONNECT THREE (3) LANES TO ONE (1) TRANSFORMER, TWO (2) LANES TO ONE (1) TRANSFORMER, AND TWO (2) LANES TO THE OTHER TRANSFORMER.
- DO NOT CONNECT POWER STRIP TO GFI. CONNECT TO CABINET POWER SOURCE DIRECTLY BY MEANS OF A SEPARATE NEMA 5-15 SOCKET.
- CONTRACTOR TO CONNECT THREE (3) LANES TO ONE (1) 2 AMP BREAKER, TWO (2) LANES TO ONE (1) 2 AMP BREAKER, AND TWO (2) LANES TO THE OTHER 2 AMP BREAKER.

RELATIVE BORDER SCALE  
IS IN INCHES

0 1 2 3

USERNAME => \$USER  
DGN FILE => \$REQUEST

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EA TBD (BATA-0006)

SHEET	OF
10	19

LAST REVISION  
00-00-00  
DATE PLOTTED => \$DATE  
TIME PLOTTED => \$TIME



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\$REQUEST

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BORDER LAST REVISED 2/1/2008

RELATIVE BORDER SCALE  
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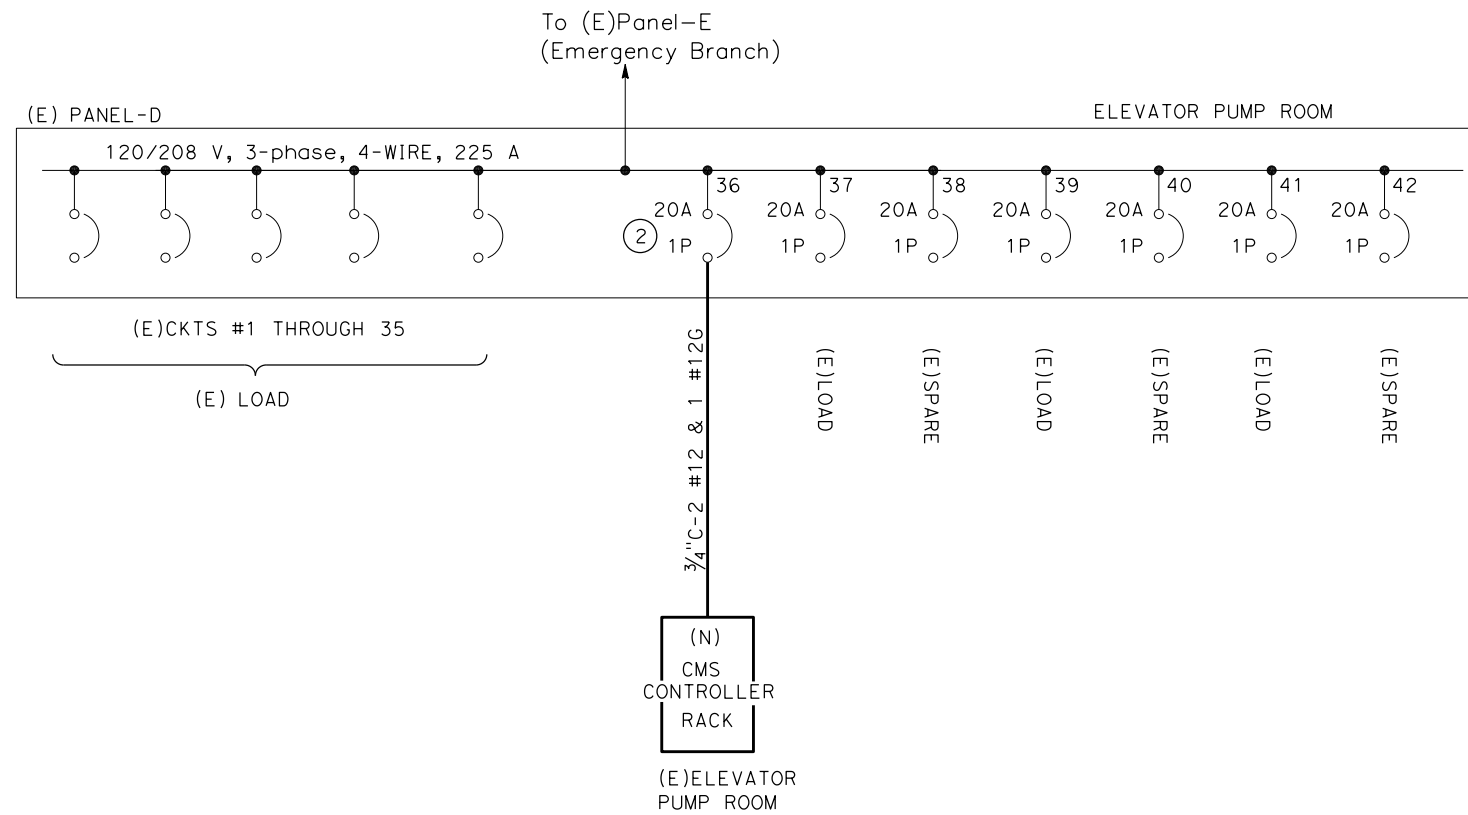
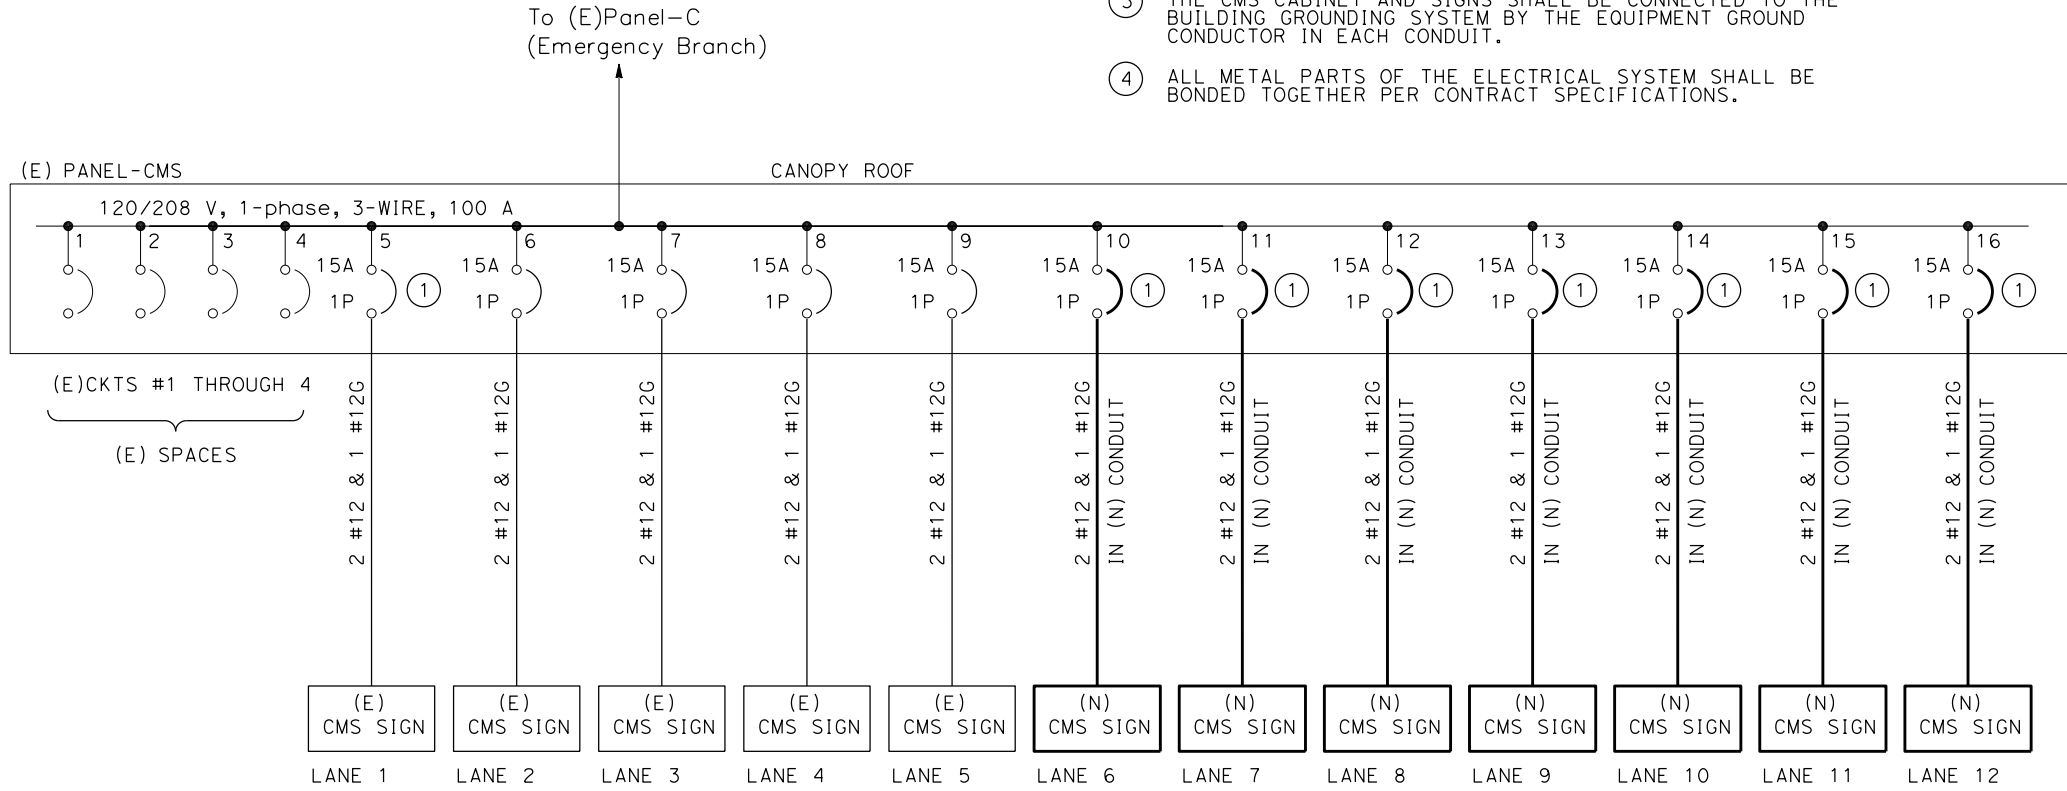
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NOTES:

- 1 INSTALL NEW CIRCUIT BREAKER IN EXISTING SPACE.
- 2 CONNECT NEW BRANCH CIRCUIT TO EXISTING CIRCUIT BREAKER.
- 3 THE CMS CABINET AND SIGNS SHALL BE CONNECTED TO THE BUILDING GROUNDING SYSTEM BY THE EQUIPMENT GROUND CONDUCTOR IN EACH CONDUIT.
- 4 ALL METAL PARTS OF THE ELECTRICAL SYSTEM SHALL BE BONDED TOGETHER PER CONTRACT SPECIFICATIONS.



PARTIAL ONE LINE DIAGRAM  
(CARQUINEZ BRIDGE)

NO SCALE

E-12

SHEET	OF
12	19

DIST	COUNTY	ROUTE	POST MILES TOTAL PROJECT	SHEET NO.	TOTAL SHEETS
04	SoI	80	0.63	45	123
Carol Light			3/12/10	DATE	
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PLANS APPROVAL DATE					
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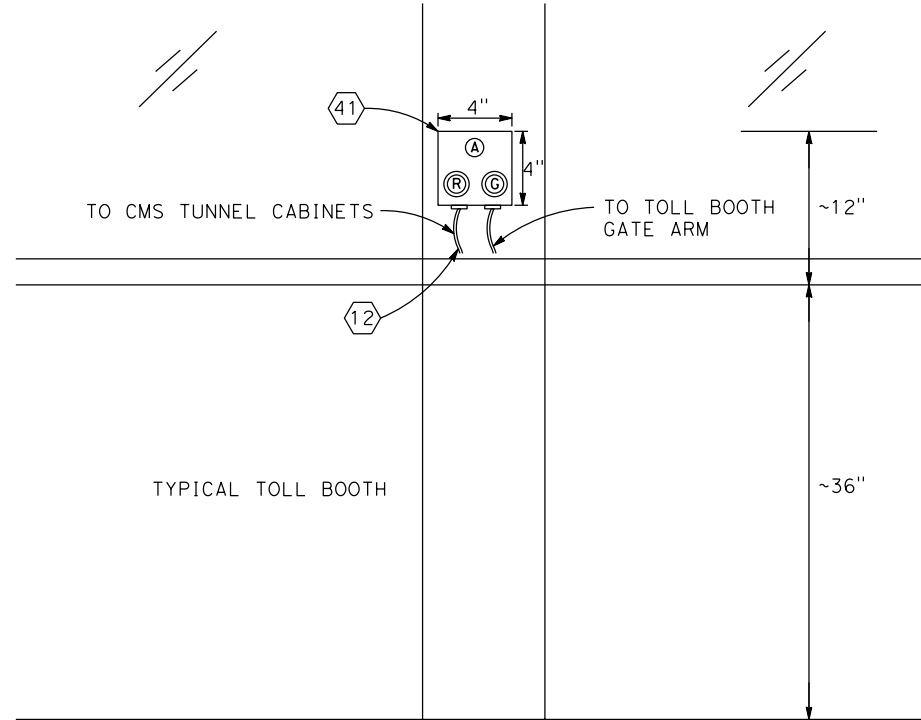
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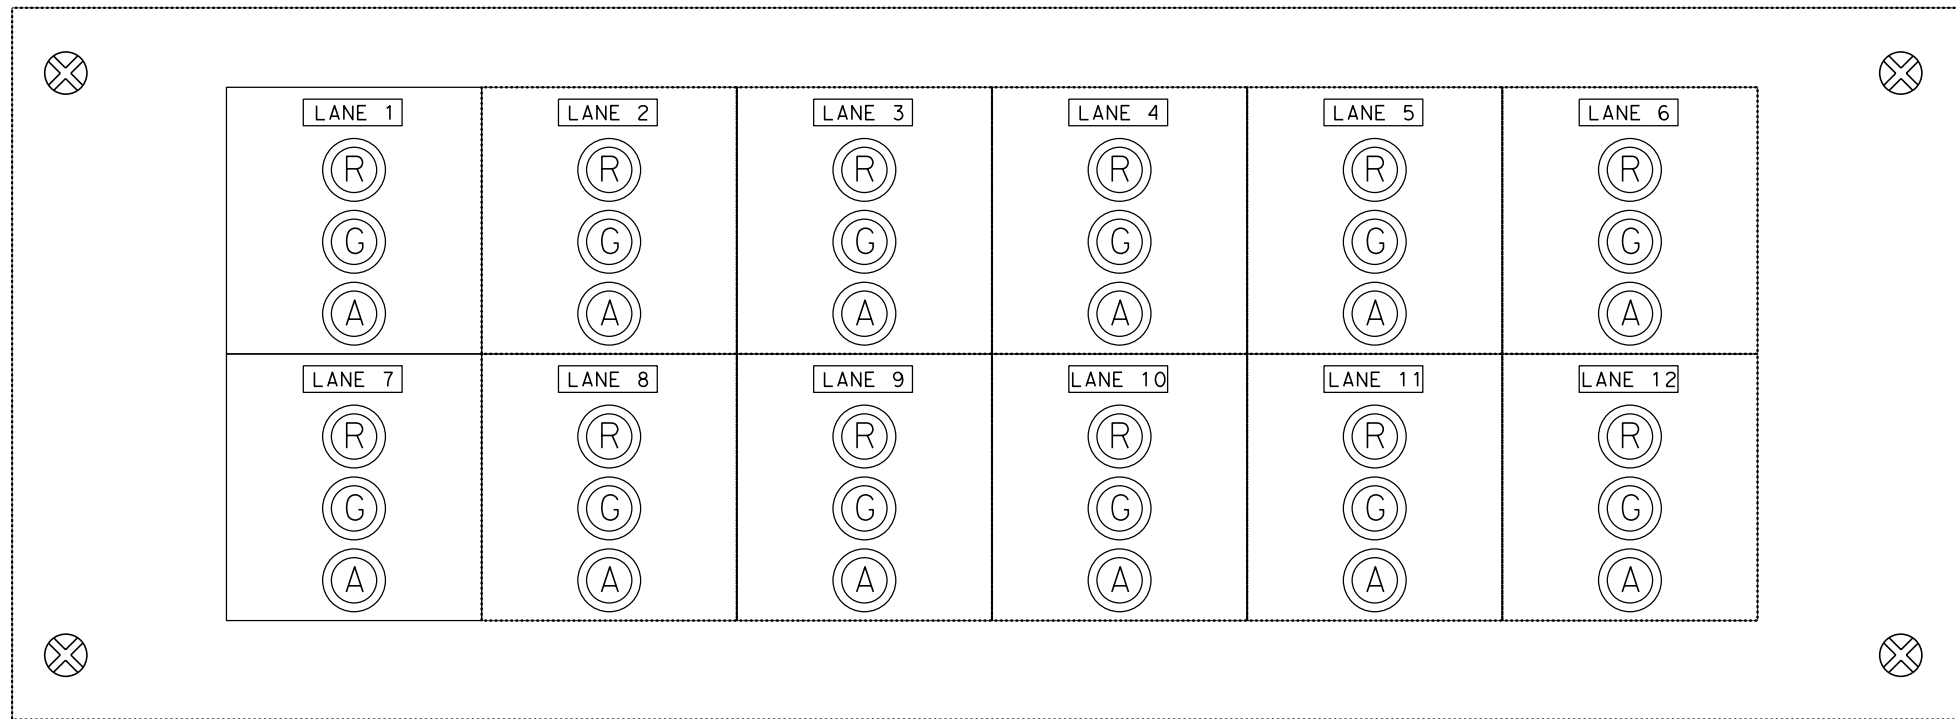


NEW TOLL BOOTH INDICATOR LIGHT SWITCH BOX

- LEGEND**
- (R) PANEL MOUNT MOMENTARY RED LED ILLUMINATED PUSH BUTTON SWITCH
  - (G) PANEL MOUNT MOMENTARY GREEN LED ILLUMINATED PUSH BUTTON SWITCH
  - (A) PANEL MOUNT MOMENTARY AMBER LED ILLUMINATED PUSH BUTTON SWITCH
  - (A) AMBER INDICATOR LED LIGHT

**NOTES:**

1. SIZE OF CONSOLE SWITCH PANEL WILL BE FIELD DETERMINED BY CONTRACTOR TO ACCOMMODATE NUMBER OF LANES.
2. SEE SHEET E-3 FOR LOCATION OF SWITCH CONSOLE PANEL.
3. SEE SHEETS E-15 TO E-16 FOR PROPOSED WIRING CONFIGURATION.
4. CONTRACTOR TO LABEL PUSH BUTTON SWITCH WITH R, G, AND A LETTERS FOR RED, GREEN, AND AMBER LANE INDICATION.



NEW INDICATOR LIGHT SWITCH CONSOLE PANEL

**INDICATOR LIGHT SWITCH CONSOLE PANEL  
AND TOLL BOOTH INDICATOR SWITCH BOX  
(CARQUINEZ BRIDGE)**

NO SCALE

**E-14**

SHEET	OF
14	19

Dist	COUNTY	ROUTE	POST MILES TOTAL PROJECT	SHEET NO.	TOTAL SHEETS
04	SoI	80	0.63	47	123
REGISTERED CIVIL ENGINEER			3/12/10 DATE	REGISTERED PROFESSIONAL ENGINEER RAMSEY J. HISSEN No. C-39608 Exp. 12/31/10 CIVIL STATE OF CALIFORNIA	
PLANS APPROVAL DATE					
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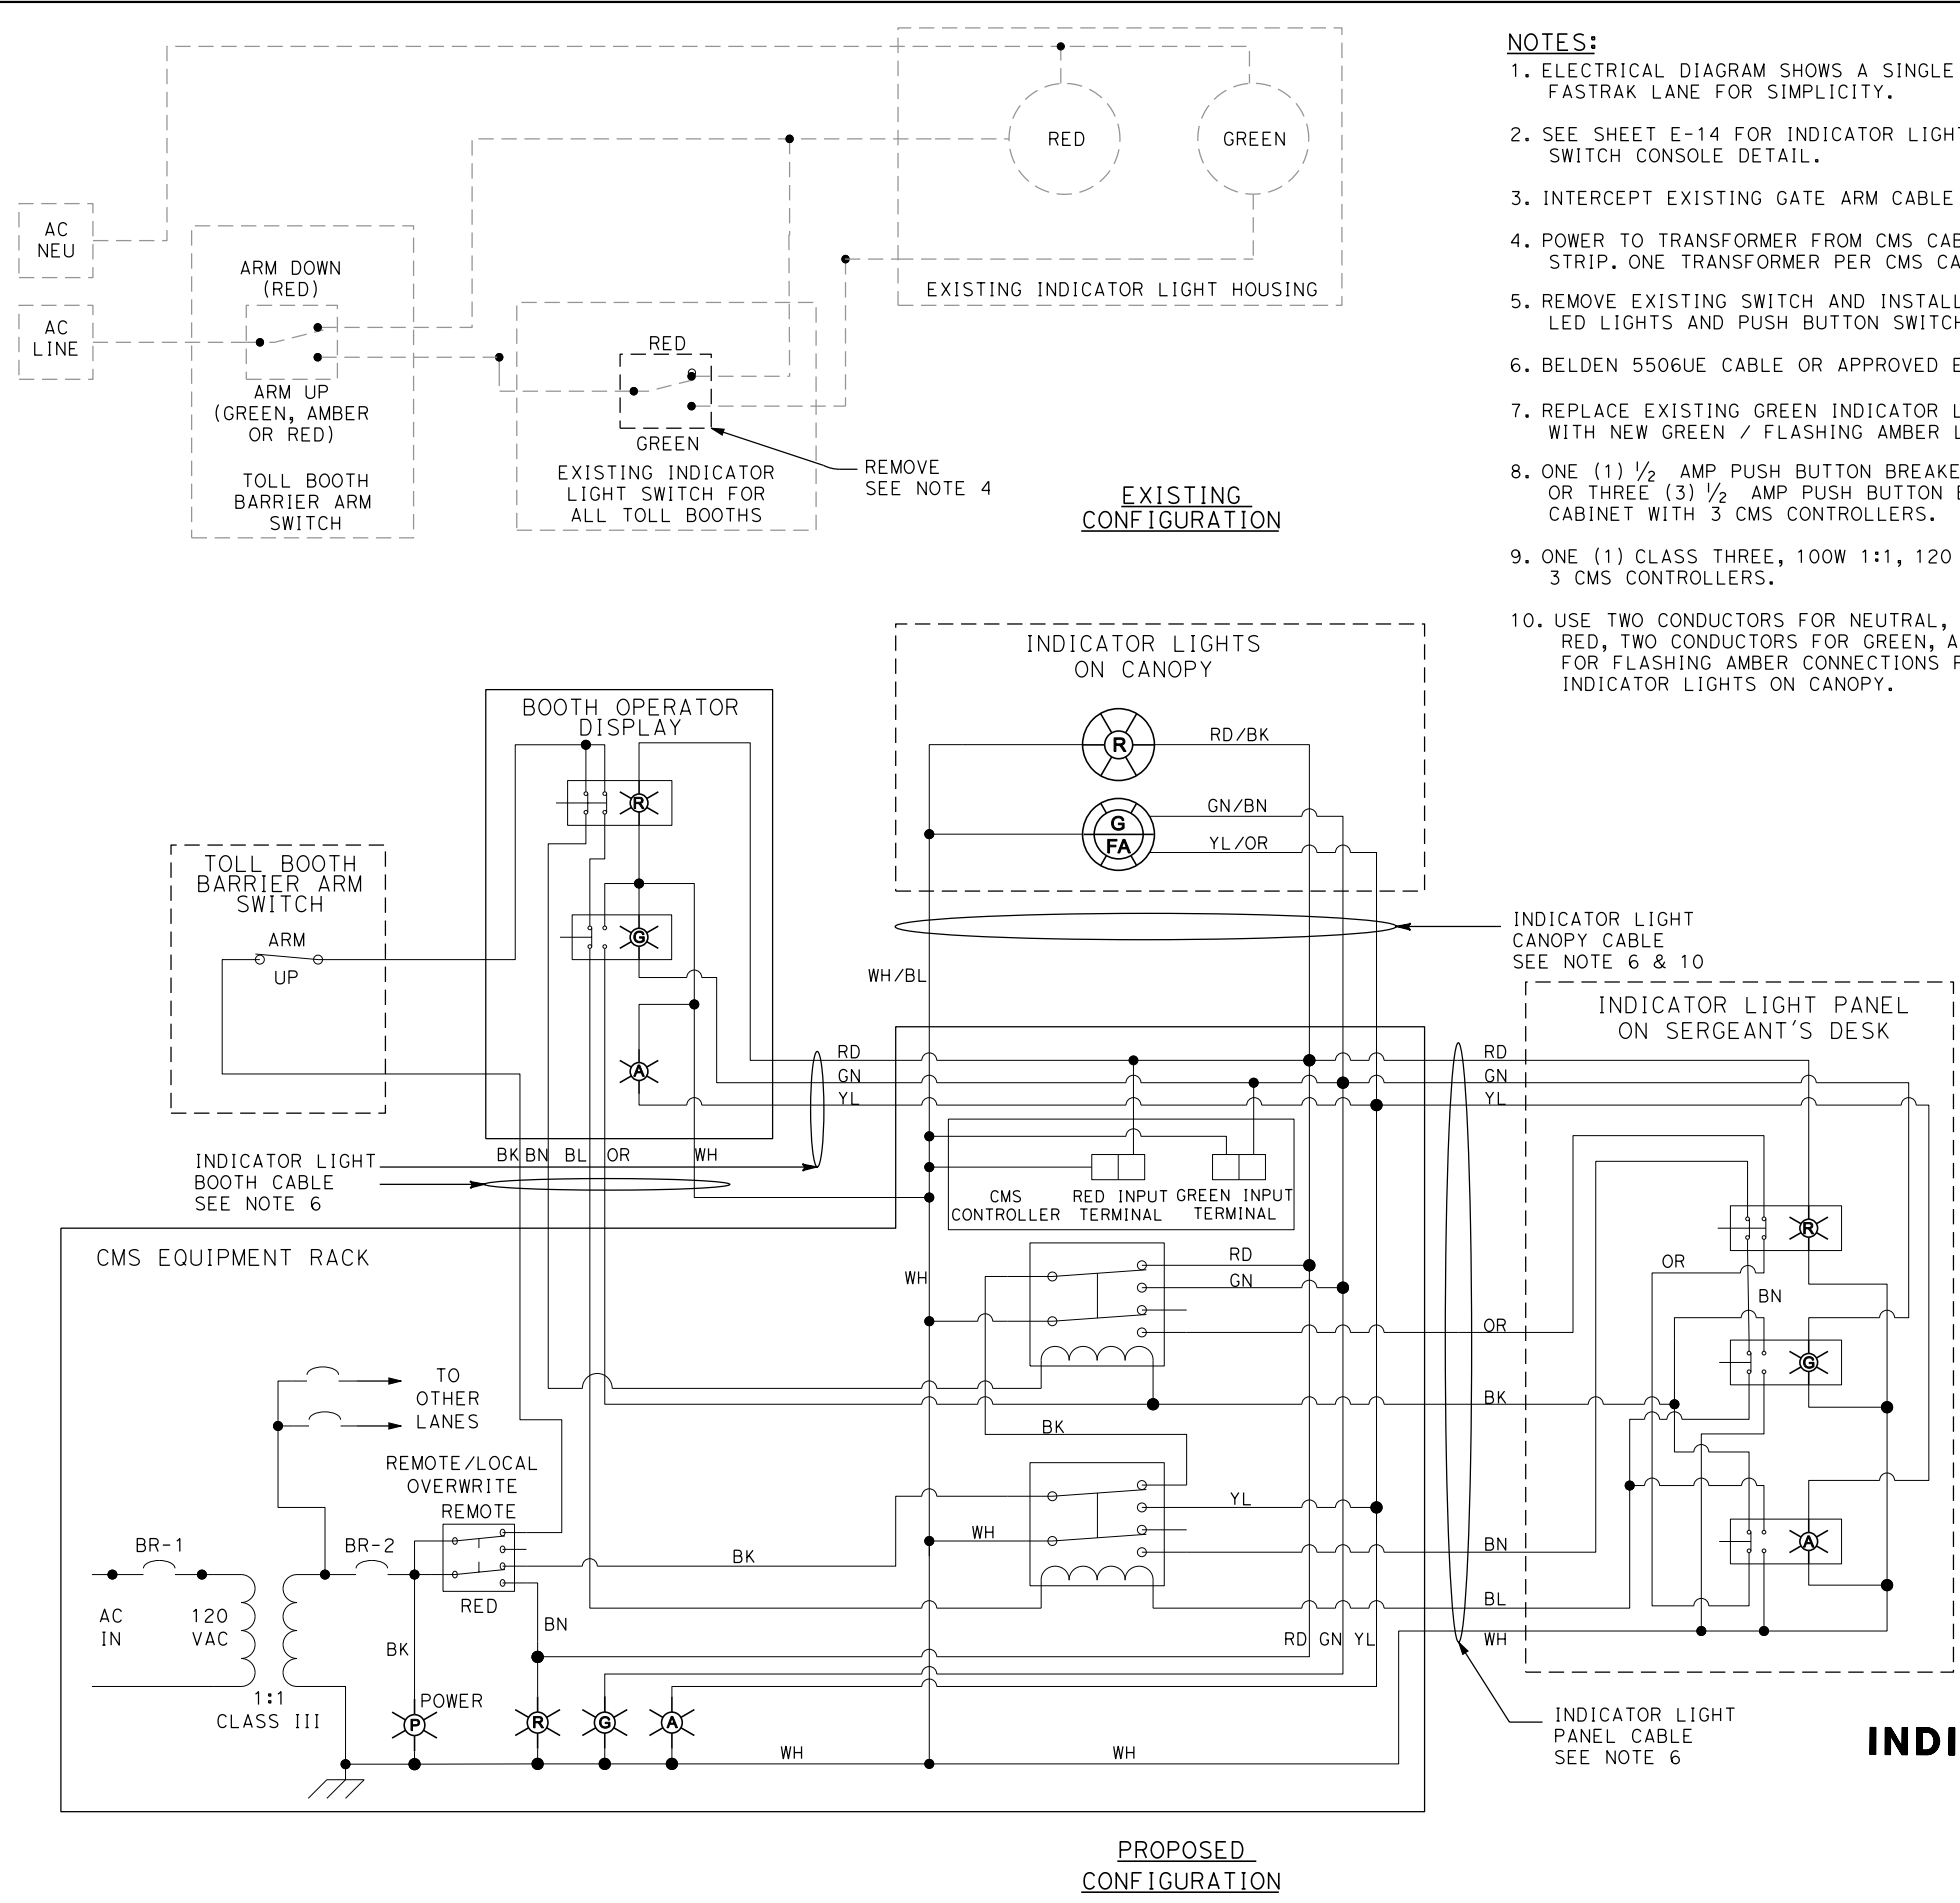




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#### NOTES:

1. ELECTRICAL DIAGRAM SHOWS A SINGLE (ONE) FASTRAK LANE FOR SIMPLICITY.
2. SEE SHEET E-14 FOR INDICATOR LIGHT SWITCH CONSOLE DETAIL.
3. INTERCEPT EXISTING GATE ARM CABLE IN TOLL BOOTH.
4. POWER TO TRANSFORMER FROM CMS CABINET POWER STRIP. ONE TRANSFORMER PER CMS CABINET.
5. REMOVE EXISTING SWITCH AND INSTALL NEW INDICATOR LED LIGHTS AND PUSH BUTTON SWITCHES ON WALL BOX.
6. BELDEN 5506UE CABLE OR APPROVED EQUIVALENT.
7. REPLACE EXISTING GREEN INDICATOR LIGHT ON CANOPY WITH NEW GREEN / FLASHING AMBER LED LIGHT.
8. ONE (1) 1/2 AMP PUSH BUTTON BREAKER PER CMS CONTROLLER OR THREE (3) 1/2 AMP PUSH BUTTON BREAKERS PER CMS CABINET WITH 3 CMS CONTROLLERS.
9. ONE (1) CLASS THREE, 100W 1:1, 120 VAC TRANSFORMER PER 3 CMS CONTROLLERS.
10. USE TWO CONDUCTORS FOR NEUTRAL, TWO CONDUCTORS FOR RED, TWO CONDUCTORS FOR GREEN, AND TWO CONDUCTORS FOR FLASHING AMBER CONNECTIONS FROM CMS CABINET TO INDICATOR LIGHTS ON CANOPY.

#### LEGEND

- (G) GREEN INDICATOR LED LIGHT, 120 VAC
- (A) AMBER INDICATOR LED LIGHT, 120 VAC
- (R) RED INDICATOR LED LIGHT, 120 VAC
- (FA) FLASHING AMBER LED LIGHT, 120 VAC
- CMS CABINET TERMINAL BLOCK X-B  
X = LANE NUMBER  
B = TERMINAL BLOCK NUMBER
- BR-1 2A AMP BREAKER, 120 VAC (1 PER CMS CABINET)
- BR-2 1/2 AMP PUSH BUTTON BREAKER, 120 VAC (3 PER CMS CABINET - SEE NOTE 8)
- CLASS 3, 100 WATT 1:1, 120 VAC TRANSFORMER (PER 3 CMS CONTROLLERS SEE NOTE 9)
- BREAKER
- CANOPY LED INDICATOR
- DPDT SWITCH
- DPDT RELAY
- NC + NC PUSH BUTTON SWITCH W/ INDICATOR
- NC + NO PUSH BUTTON SWITCH W/ INDICATOR
- PANEL MOUNT LIGHT INDICATOR (120 VAC)

## INDICATOR LIGHT WIRING DIAGRAM FOR LANES 6-12 (CARQUINEZ BRIDGE)

NO SCALE

E-16

SHEET	OF
16	19

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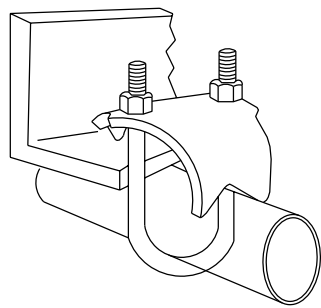
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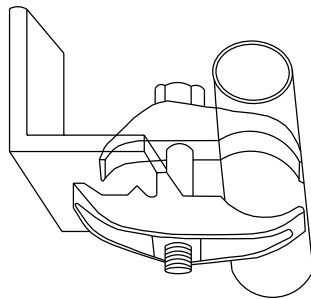


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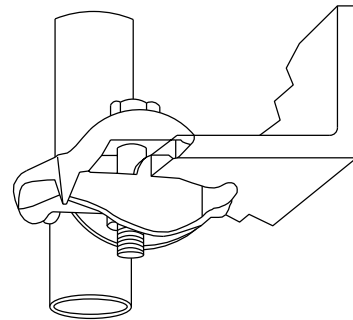
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				CHECKED BY	




FOR MOUNTING PIPES OR CONDUIT AT RIGHT ANGLES TO THE BEAM DETAIL




FOR MOUNTING PIPES OR CONDUIT PARALLEL TO THE BEAM DETAIL



FOR MOUNTING PIPES OR CONDUIT VERTICALLY ACROSS BEAM EDGE DETAIL

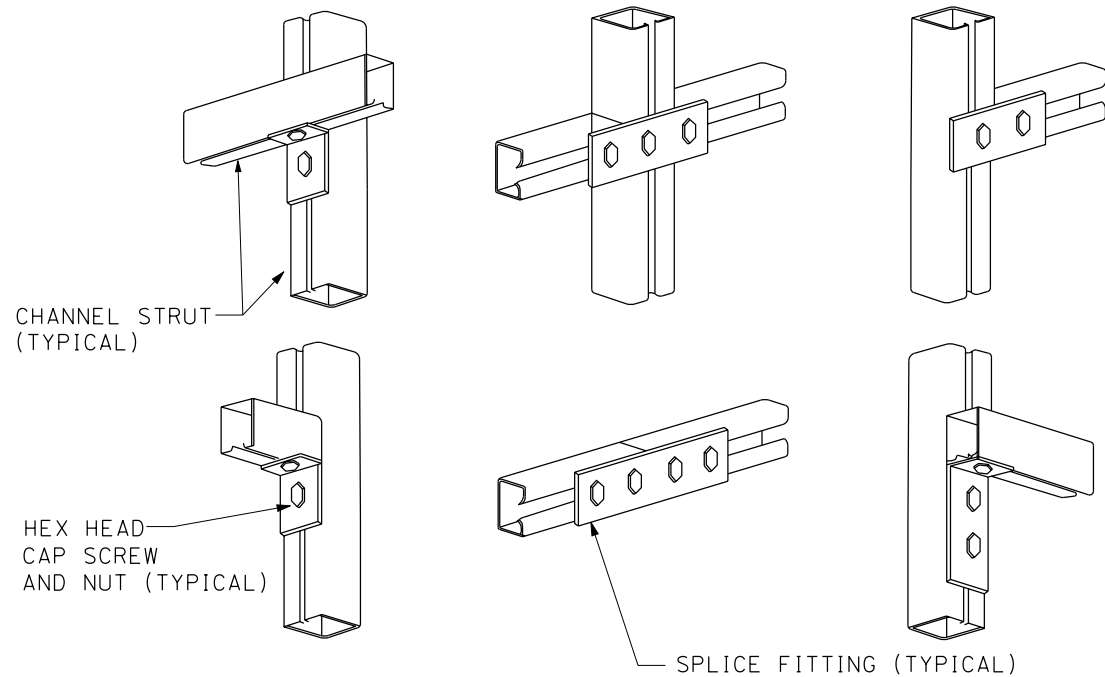

TYPICAL EQUIPMENT SUPPORT CHANNEL, FITTINGS AND FASTENERS

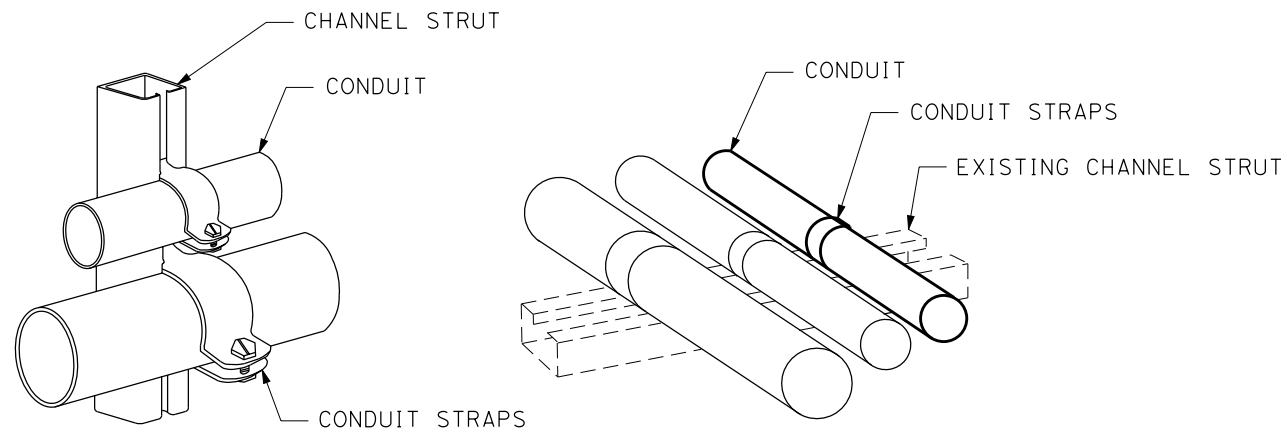

MOUNTING ON STRUT DETAILS

## CONDUIT MOUNTING AND ATTACHMENT DETAILS (CARQUINEZ BRIDGE)

NO SCALE

**E-18**


SHEET	OF
18	19

DIST	COUNTY	ROUTE	POST MILES TOTAL PROJECT	SHEET NO.	TOTAL SHEETS
04	SoI	80	0.63	51	123
REGISTERED CIVIL ENGINEER			3/12/10 DATE		
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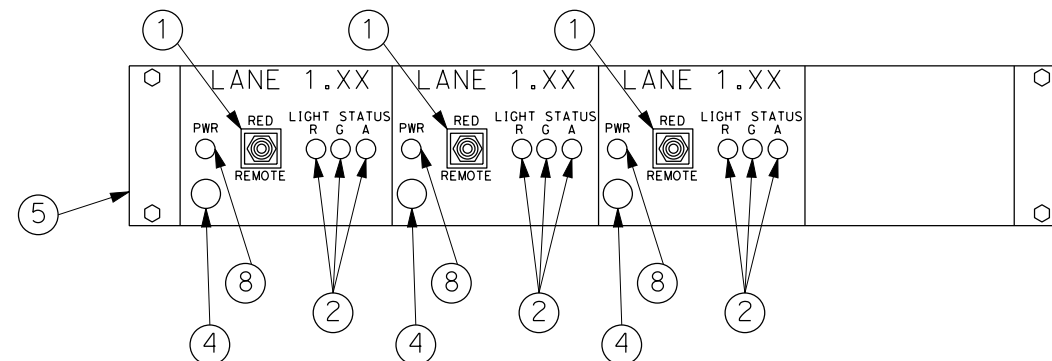
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			CHECKED BY	DATE REVISED		


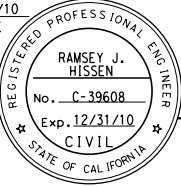
ITEM	COMPONENT
①	ONE (1) NEW PANEL MOUNT DPDT TOGGLE SWITCH
②	NEW PANEL MOUNT RED, GREEN, AMBER LED INDICATOR LIGHTS (120VAC)
③	TERMINAL BLOCKS FOR INDICATOR LIGHT CANOPY CABLE AND POWER
④	ONE (1) NEW PANEL MOUNT 1/2 AMP PUSH BUTTON BREAKER (120 VAC)
⑤	INSTALL NEW PULL OUT DRAWER FOR WIRING OF NEW INDICATOR LIGHT RELAYS.
⑥	TWO (2) NEW DPDT RELAYS
⑦	DRILLED HOLES AT BOTTOM OF DRAWER FOR INDICATOR LIGHT CABLE
⑧	NEW PANEL MOUNT BLUE LED INDICATOR LIGHT (120VAC) FOR POWER INDICATION
⑨	TERMINAL BLOCKS FOR INDICATOR LIGHT BOOTH CABLE
⑩	TERMINAL BLOCKS FOR INDICATOR LIGHT PANEL CABLE

TOP VIEW

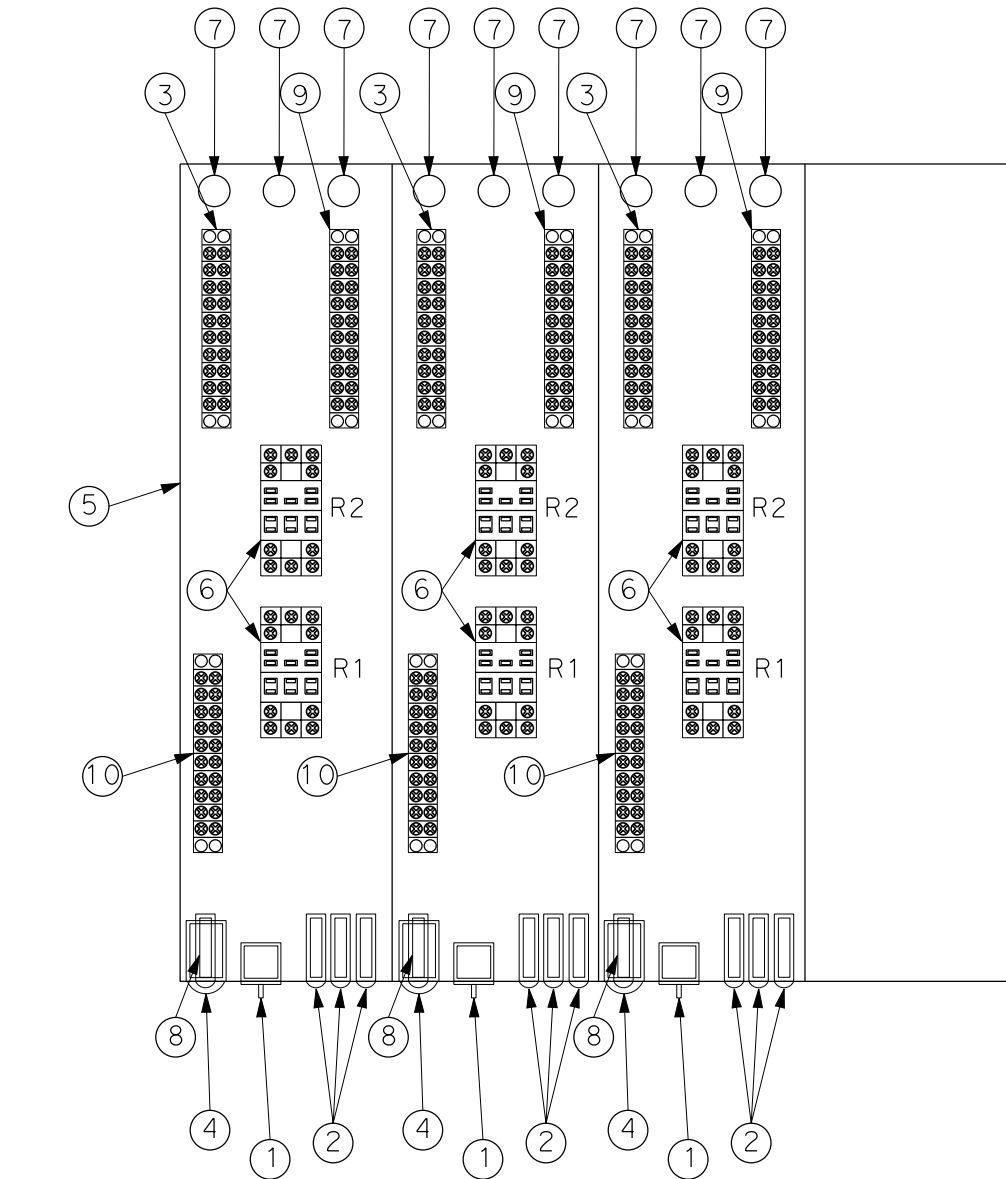

FRONT VIEW



Dist	COUNTY	ROUTE	POST MILES TOTAL PROJECT	SHEET TOTAL SHEETS
04	SoI	80	0.63	52 123
 REGISTERED CIVIL ENGINEER			3/12/10 DATE	
PLANS APPROVAL DATE _____				
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NOTES:

1. ALL EQUIPMENT SHALL BE SECURED.  
NO EQUIPMENT WILL BE LAYING IN  
BOTTOM OF CABINET. INSTALLATION  
SHALL BE NEAT, DRESSED AND  
ACCORDING TO THE PLANS.
2. CONTRACTOR SHALL SUBMIT MATERIAL  
SUBMITTALS FOR ALL CABINET COMPONENTS  
TO THE ENGINEER FOR REVIEW AND  
APPROVAL PRIOR TO PROCUREMENT AND  
INSTALLATION.
3. INDICATOR LIGHT CABLES TO BE WIRED  
ACCORDING TO THE INDICATOR LIGHT  
WIRING DIAGRAMS AS SHOWN ON SHEETS  
E-15 TO E-16.
4. INDICATOR LIGHT DRAWER LAYOUT SHOWN  
FOR TYPICAL CMS CABINET.
5. ROUTE ALL CABLES THROUGH DRILLED HOLES  
AT BOTTOM OF DRAWER. INCLUDE PLASTIC  
GROMMETS IN HOLE.
6. TERMINATE ALL CABLES ON NEW TERMINATION  
BLOCKS.
7. FASTEN ALL CABLES TO DRAWER TO PREVENT  
STRAINING ON TERMINATION BLOCKS.
8. EACH CABINET DRAWER SHALL BE DESIGNED TO  
ACCOMMODATE UP TO FOUR (4) INDICATOR CONTROL  
LANES.
9. CONTRACTOR TO LEAVE AT LEAST ONE RACK UNIT  
OF SPACE BETWEEN DRAWER AND BOTTOM OF CABINET.

## INDICATOR LIGHT CABINET DRAWER LAYOUT (CARQUINEZ BRIDGE)

NO SCALE

E-19

SHEET	OF
19	19

DIST	COUNTY	ROUTE	POST MILES TOTAL PROJECT	SHEET No	TOTAL SHEETS
04	Ala	84	R3.21	53	123



REGISTERED CIVIL ENGINEER DATE 3/12/10

PLANS APPROVAL DATE

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OAKLAND, CALIFORNIA 94607



**MGE ENGINEERING, INC.**  
7415 GREENHAVEN DRIVE, SUITE 100  
SACRAMENTO, CALIFORNIA 95831

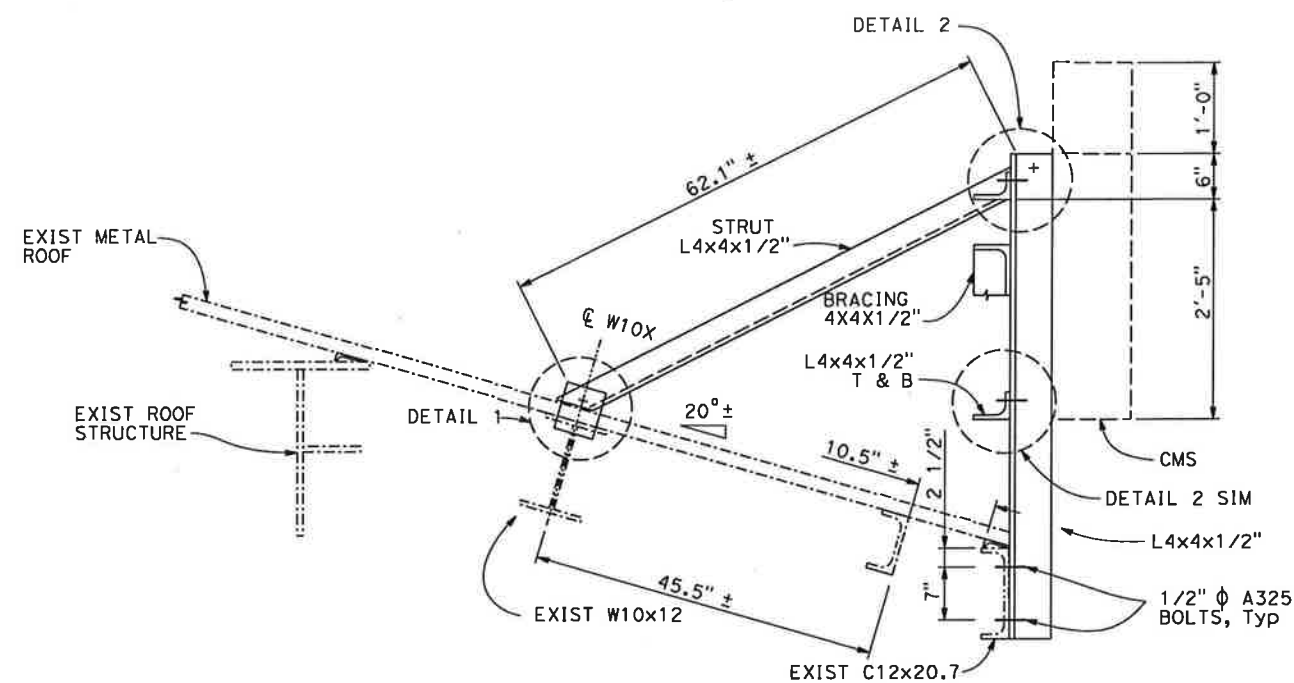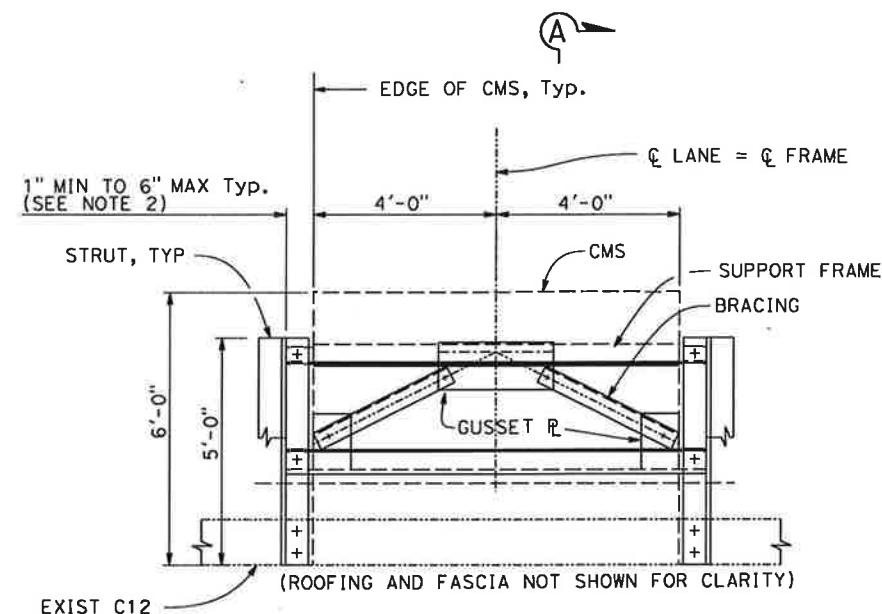

LEGEND:

— INDICATES NEW STRUCTURE

----- INDICATES EXIST STRUCTURE

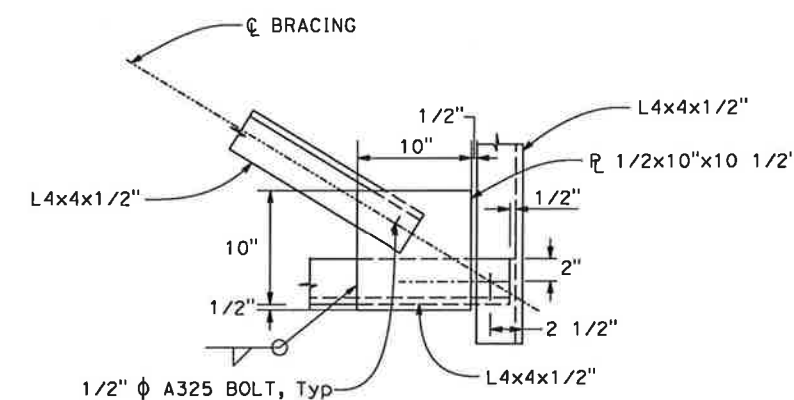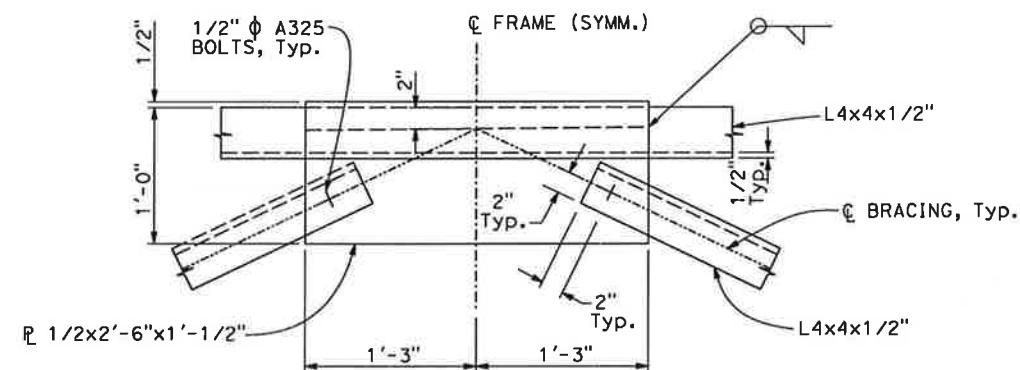


NOTES:


1. FOR NUMBER AND LOCATION OF CMS PANELS, SEE LAYOUT SHEET L-7.
2. DISTANCE FROM EDGE OF CMS TO EDGE OF FRAME MAY BE ADJUSTED AND DETERMINED IN THE FIELD SUCH THAT STRUT MEMBERS WILL BE ALIGNED WITH A VALLEY OF EXISTING CORRUGATED SHEET METAL AND TO ENSURE THAT FRAME WILL BE WIDE ENOUGH FOR CONNECTION TO CMS ATTACHMENT.
3. ALL STEEL MEMBERS SHALL BE GALVANIZED.
4. ALL BOLTS, WASHERS AND LOCK NUTS SHALL BE OF STAINLESS STEEL OR GALVANIZED.

DESIGN OVERSIGHT		DESIGN	BY	G. Xu	CHECKED	PREPARED FOR THE STATE OF CALIFORNIA DEPARTMENT OF TRANSPORTATION	Guoping Xu PROJECT ENGINEER	BRIDGE NO.	DUMBARTON TOLL PLAZA										SHEET														
		DETAILS	BY	E. Gornico	CHECKED			POST MILE											S-1														
SIGN OFF DATE		QUANTITIES	BY		CHECKED			R3.21	CMS SUPPORT DETAILS																								
DESIGN DETAIL SHEET (ENGLISH) (REV. 2/25/05)												ORIGINAL SCALE IN INCHES FOR REDUCED PLANS				0 1 2 3				CU EA	DISREGARD PRINTS BEARING EARLIER REVISION DATES				REVISION DATES (PRELIMINARY STAGE ONLY)				SHEET	QF			
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DIST	COUNTY	ROUTE	POST MILES TOTAL PROJECT	SHEET NO	TOTAL SHEETS
04	Ala	84	R3.21	54	123
REGISTERED CIVIL ENGINEER			DATE	3/12/10	
PLANS APPROVAL DATE			3/12/10		
The State of California or its officers or agents shall not be responsible for the accuracy or completeness of electronic copies of this plan sheet.					
BAY AREA TOLL AUTHORITY 101 EIGHTH STREET OAKLAND, CALIFORNIA 94607					
MGE ENGINEERING, INC. 7415 GREENHAVEN DRIVE, SUITE 100 SACRAMENTO, CALIFORNIA 95831					

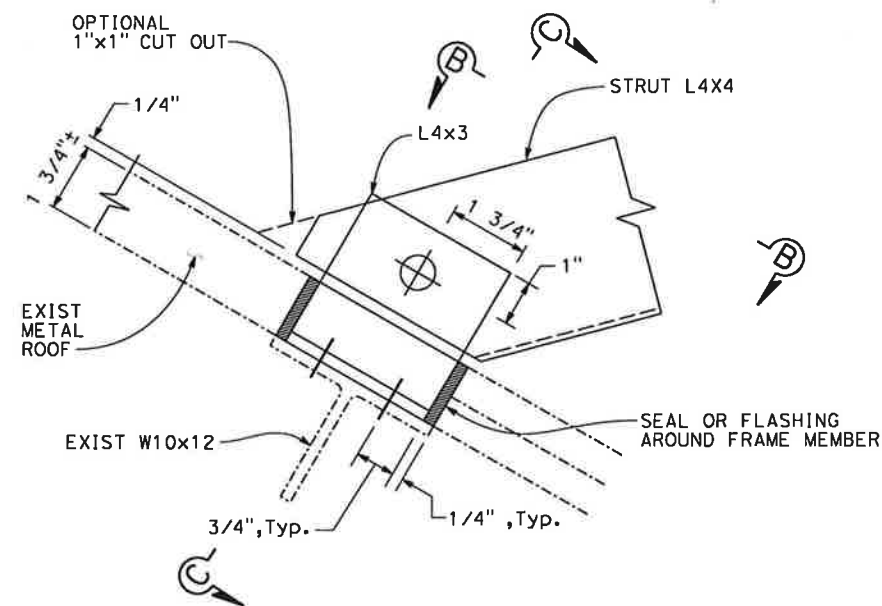


**DETAIL 1**  
SCALE: 6" = 1'-0"

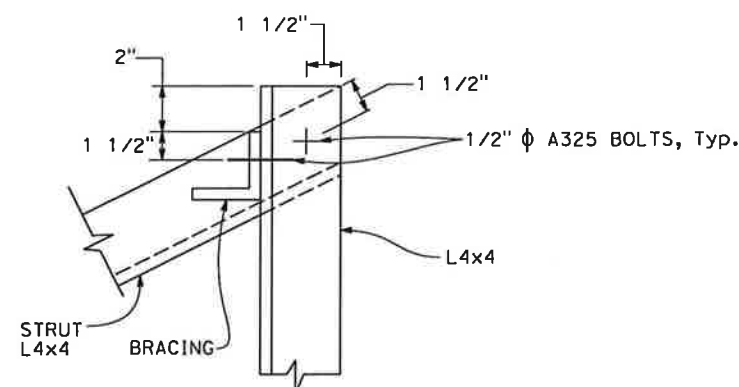


**DETAIL 2** (CMS NOT SHOWN)  
SCALE: 3" = 1'-0"

**LEGEND:**  
— INDICATES NEW STRUCTURE  
- - - INDICATES EXIST STRUCTURE  
/// INDICATES REMOVAL OF PORTION OF EXIST FRAME

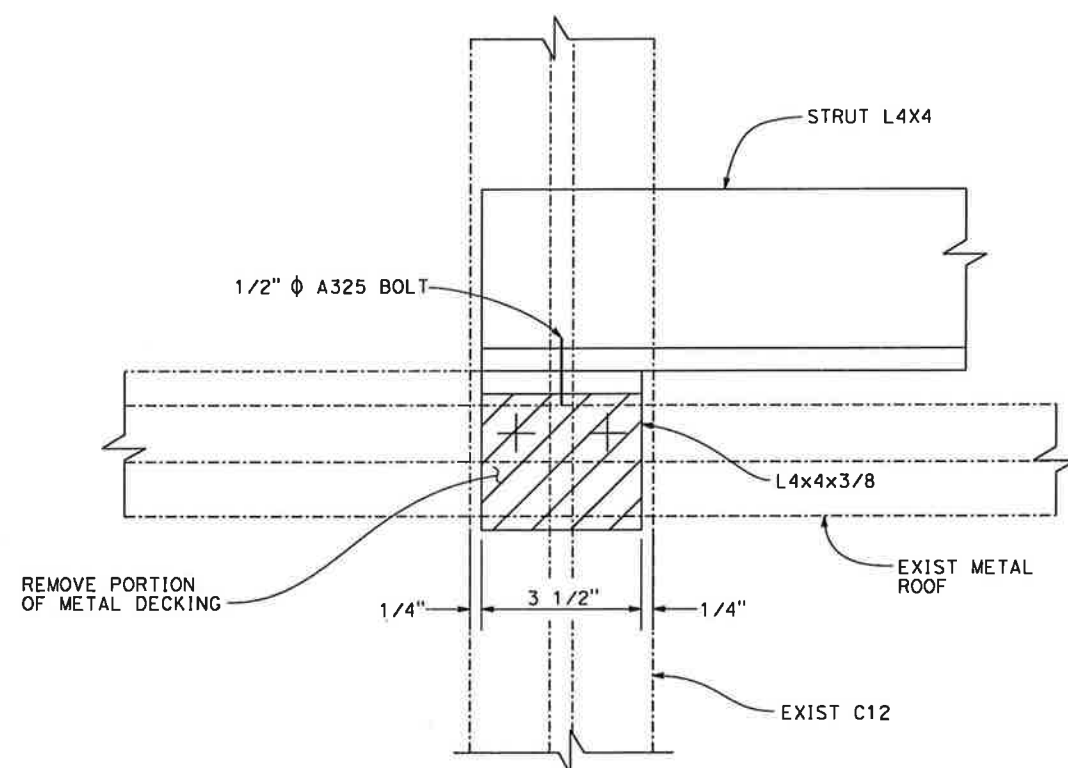

**SECTION B-B**  
SCALE: 6" = 1'-0"

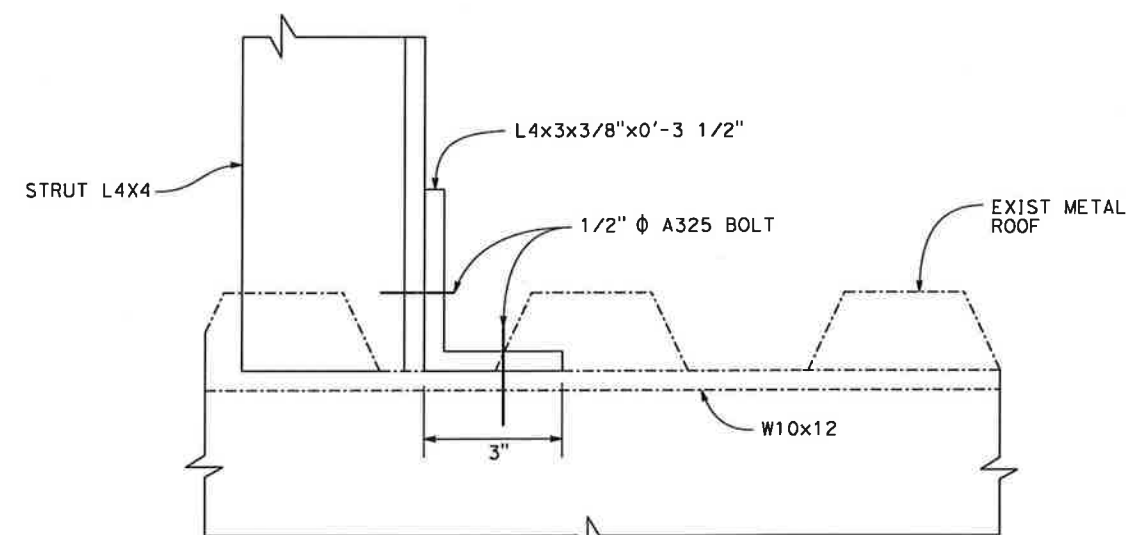

**SECTION C-C**  
SCALE: 6" = 1'-0"

**Note:**  
The Contractor shall verify all controlling field dimensions before ordering or fabricating any material.


**NOTE:**  
PARTIAL REMOVAL OF ROOFING AND FASCIA WILL BE NECESSARY FOR INSTALLATION OF SUPPORT FRAME. THE ROOFING AND FASCIAL SHALL BE REINSTATED AFTER INSTALLATION OF SUPPORT FRAME.

DESIGN OVERSIGHT	DESIGN BY G. Xu	CHECKED	PREPARED FOR THE STATE OF CALIFORNIA DEPARTMENT OF TRANSPORTATION	BRIDGE NO.	DUMBARTON TOLL PLAZA CMS SUPPORT DETAILS	SHEET S-2
SIGN OFF DATE	DETAILS BY E. Garnica	CHECKED	PROJECT ENGINEER	POST MILE R3.21		
DESIGN DETAIL SHEET (ENGLISH) (REV. 2/25/05)	QUANTITIES BY	CHECKED	CU EA	DISREGARD PRINTS BEARING EARLIER REVISION DATES	REVISION DATES (PRELIMINARY STAGE ONLY)	SHEET 2 OF 3

ORIGINAL SCALE IN INCHES FOR REDUCED PLANS: 0 1 2 3


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DIST	COUNTY	ROUTE	POST MILES TOTAL PROJECT	SHEET NO	TOTAL SHEETS
04	Ala	84	R3.21	55	123

  
REGISTERED CIVIL ENGINEER

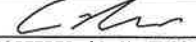3/12/10  
DATE


PLANS APPROVAL DATE

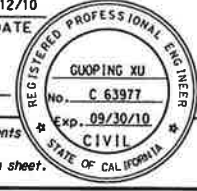


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OAKLAND, CALIFORNIA 94607


MGE ENGINEERING, INC.  
7415 GREENHAVEN DRIVE, SUITE 100  
SACRAMENTO, CALIFORNIA 95831

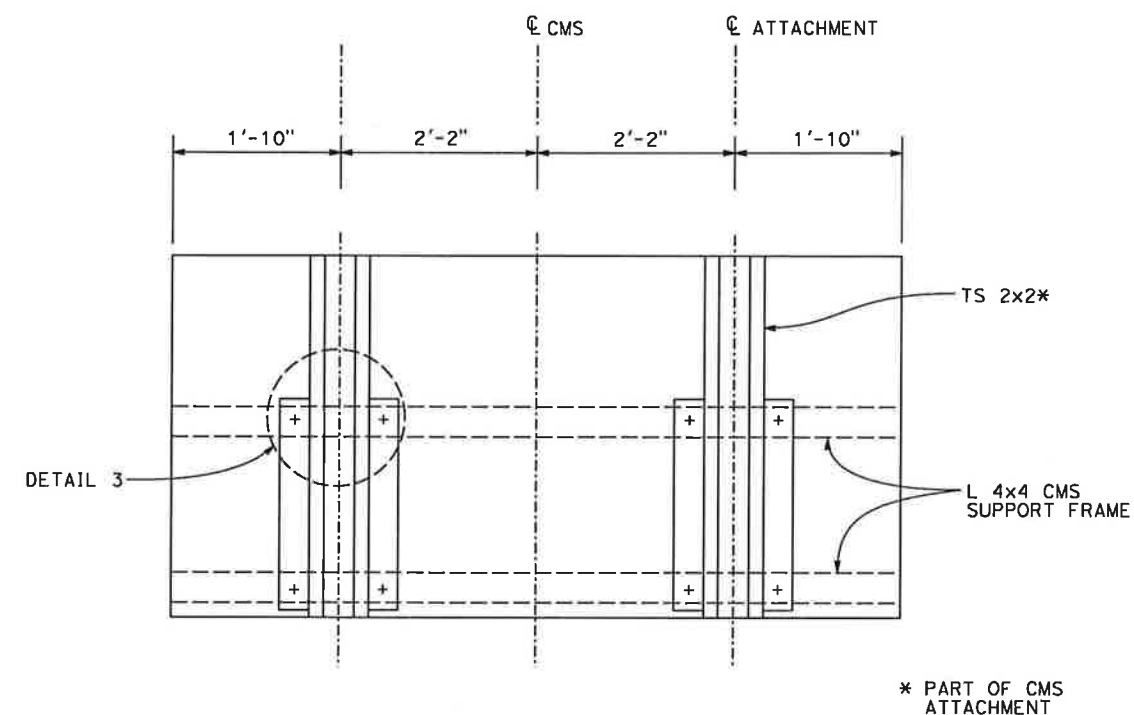

**BACK VIEW OF CMS**  
SCALE: 1" = 1'-0"

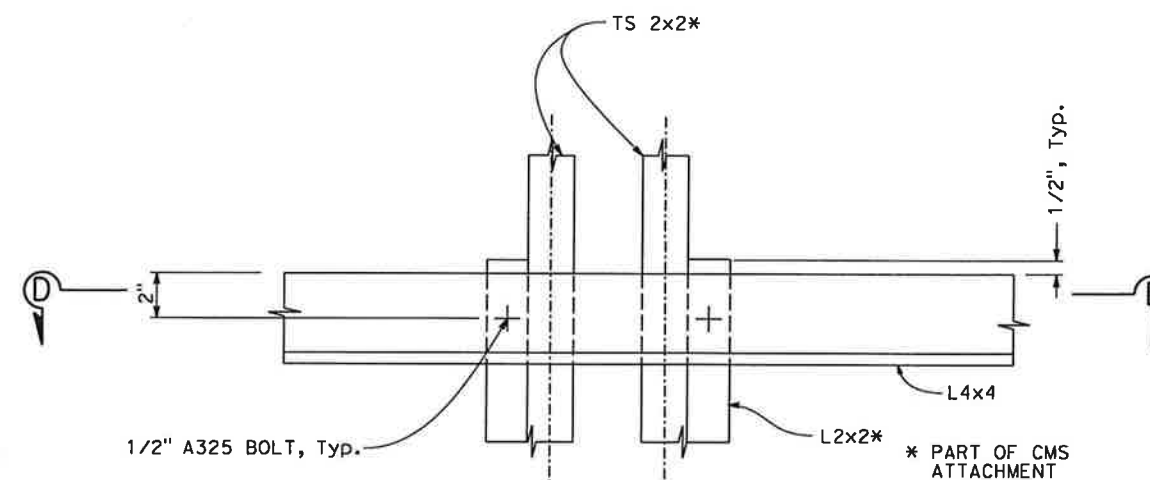

**DETAIL 3**  
SCALE: 3" = 1'-0"

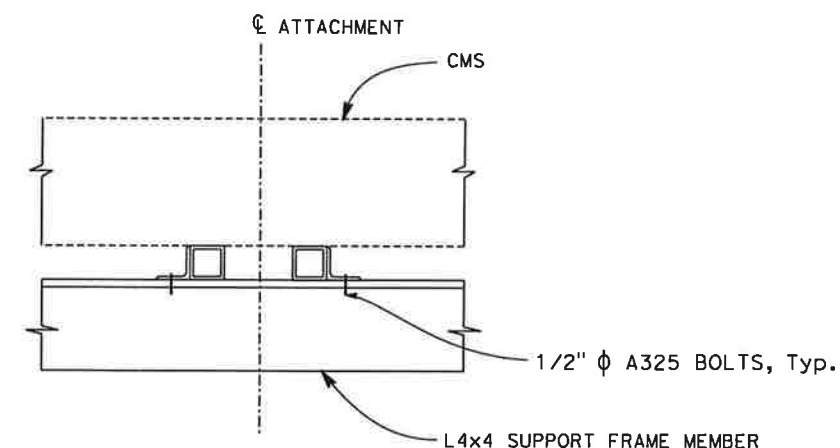

**SECTION D-D**  
SCALE: 3" = 1'-0"

Note:  
The Contractor shall verify all  
controlling field dimensions before  
ordering or fabricating any material.

**NOTE:**

POSITION OF BOLT HOLES SHALL BE FIELD MEASURED PRIOR TO BEING DRILLED OR  
OVERSIZED HOLES SHALL BE USED.

DESIGN OVERSIGHT		DESIGN	BY G. Xu	CHECKED	PREPARED FOR THE STATE OF CALIFORNIA DEPARTMENT OF TRANSPORTATION	Guoping Xu PROJECT ENGINEER	BRIDGE NO.	DUMBARTON TOLL PLAZA	SHEET		
		DETAILS	BY E. Garnica	CHECKED			POST MILE				
		QUANTITIES	BY	CHECKED			R3.21			CMS SUPPORT DETAILS	S-3
SIGN OFF DATE											
DESIGN DETAIL SHEET (ENGLISH) (REV. 2/25/05)		ORIGINAL SCALE IN INCHES FOR REDUCED PLANS				CU EA	DISREGARD PRINTS BEARING EARLIER REVISION DATES	REVISION DATES (PRELIMINARY STAGE ONLY)		SHEET	OF
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STATE OF CALIFORNIA - DEPARTMENT OF TRANSPORTATION	CONSULTANT FUNCTIONAL SUPERVISOR	CALCULATED-DESIGNED BY	REVISED BY	
<b>CT Caltrans®</b>		CHECKED BY	DATE REVISED	


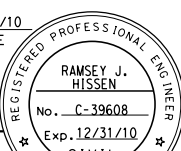
PROJECT NOTES:

- 1 INSTALL NEW TYPE D CABLE IN EXISTING CONDUIT.
- 2 INSTALL NEW TYPE D CABLE.
- 3 INSTALL (N) TYPE 1 JUNCTION BOX. MOUNT AND SECURE ON (E) TUNNEL CEILING.
- 4 INSTALL NEW THREE (3) 15A-1P CIRCUIT BREAKER IN (E) SPACES 14, 16 AND 18 (120V CMS SIGNS).
- 5 INSTALL NEW ONE (1) 15A-1P CIRCUIT BREAKER FOR NEW CMS CABINET #3 IN (E) SPACE 20.
- 6 INSTALL NEW TYPE 1 ( $\frac{3}{4}$ " C) CONDUIT WITH 2 #14 AND 1 #14G (120 V, CMS CABINET #3) AND PROVIDE CONDUIT SUPPORT.
- 7 INSTALL NEW TYPE 1 (1" C) CONDUIT.
- 8 INSTALL TYPE 3 JUNCTION BOX BELOW CANOPY AS SPECIFIED IN CONTRACT DOCUMENTS.
- 9 INSTALL NEW CAT-5e CABLE.
- 10 ALL WALL, CEILING AND FLOOR PENETRATIONS SHALL BE CORE-DRILLED AS DIRECTED AND APPROVED BY CALTRANS SUFFICIENTLY LARGE TO ACCOMMODATE CONDUIT PLUS FLUSH MOUNTED END BELL. ALL CORE-DRILLS SHALL BE MADE WATER-TIGHT, SEALED AROUND CONDUIT PER CALTRANS REQUIREMENTS WITH FAST-SETTING EPOXY RESIN THROUGHOUT THE DEPTH OF HOLE.
- 11 INSTALL NEW INDICATOR LIGHT CANOPY CABLE.
- 12 INSTALL NEW INDICATOR LIGHT BOOTH CABLE.
- 13 INSTALL NEW INDICATOR LIGHT CONSOLE CABLE.
- 14 INSTALL NEW CMS COMM CABLE.
- 15 EXISTING TYPE 3 JUNCTION BOX BELOW CANOPY.
- 16 FINAL LOCATION OF CMS WORKSTATION.
- 17 INSTALL NEW TYPE 4 (1 $\frac{1}{2}$ " C) CONDUIT.
- 18 INSTALL NEW FIBER OPTIC DUPLEX JUMPER CABLES.
- 19 (E) FDU TO REMAIN.
- 20 REMOVE AND DISPOSE OF EXISTING INDICATOR LIGHT CABLE.
- 21 INSTALL NEW CMS PANEL AS SPECIFIED IN CONTRACT DOCUMENTS.
- 22 INSTALL TYPE 2 (1  $\frac{1}{2}$ " C) CONDUIT WITH 4 #12 & 1 #12G (120V, CMS SIGN)
- 23 ROUTE NEW CABLES THROUGH EXISTING CONDUIT.
- 24 MODIFY EXISTING GREEN INDICATOR LIGHT AND REPLACE WITH GREEN/FLASHING AMBER LED INDICATOR BULB. REPLACE EXISTING RED INDICATOR LIGHT WITH RED LED INDICATOR BULB. IF EXISTING RED INDICATOR LIGHT IS LED, FURNISH NEW RED LED INDICATOR BULB TO BATA AS A SPARE.
- 25 INSTALL NEW TYPE 2 (1 $\frac{1}{2}$ " C) CONDUIT.

- 26) INSTALL NEW TYPE 2 (1 1/2" C) CONDUIT WITH 6 #12 & 3 #12G (120V, CMS SIGN)
- 27) ROUTE NEW CMS COMM CABLE THROUGH EXISTING JUNCTION BOX.
- 28) INSTALL NEW CMS PLAZA CABINET FOR LANES 1-3 AS SPECIFIED IN CONTRACT DOCUMENTS.
- 29) INSTALL INDICATOR LIGHT SWITCH CONSOLE PANEL.
- 30) REMOVE EXISTING INDICATOR LIGHT SWITCH IN TOLL BOOTH.
- 31) INSTALL NEW CMS CONTROLLERS. ROUTE CAT-5E PATCH CABLES FROM EACH CMS CONTROLLER TO NEW ETHERNET SWITCH IN EXISTING CMS CABINET.
- 32) INSTALL NEW TYPE 1 (2" C) CONDUIT.
- 33) INSTALL NEW TYPE 2 (2" C) CONDUIT.
- 34) INSTALL TYPE 1 JUNCTION BOX AS SPECIFIED IN CONTRACT DOCUMENTS.
- 35) INSTALL NEW TYPE 1 (1 1/2" C) CONDUIT.
- 36) INSTALL NEW 6"X6"X4" JUNCTION BOX
- 37) DISCONNECT AT (E) PANEL-Q BRANCH CIRCUITS #13, 15, AND 17, AND LABEL BREAKERS AS SPARES.
- 38) INSTALL NEW TYPE 4 (2" C) CONDUIT
- 39) INSTALL AND TERMINATE INDICATOR LIGHT CABLES TO NEW TERMINAL BLOCKS AND WIRE TO SWITCH PANEL AS SHOWN IN PLANS AND APPROVED BY THE ENGINEER.
- 40) INSTALL LB FITTING.
- 41) INSTALL NEW PUSH BUTTON LED INDICATOR BOX.
- 42) PROVIDE NEW REVISED (TYPED WRITTEN) PANEL SCHEDULE.
- 43) INSTALL NEW TYPE 4 (1" C) CONDUIT.
- 44) INSTALL NEW TYPE 1 (1 1/2" C) CONDUIT WITH 6 #12 & 3 #12G (120V, CMS SIGN) TO (E) PANEL-TB.
- 45) CORE DRILL (E) CONCRETE SLAB.
- 46) INSTALL TYPE 2 (1 1/2" C) CONDUIT WITH 2 #12 & 1 #12G (120V, CMS SIGN)
- 47) REPLACE EXISTING RED INDICATOR LIGHT WITH NEW RED LED INDICATOR BULB. IF EXISTING RED INDICATOR LIGHT IS LED, FURNISH NEW RED LED INDICATOR BULB TO BATA AS A SPARE.

Dist	COUNTY	ROUTE	POST MILES TOTAL PROJECT	SHEET No.	TOTAL SHEETS
04	Ala	84	R3.21	57	123

 REGISTERED CIVIL ENGINEER	3/12/10 DATE	
PLANS APPROVAL DATE		
<p><i>THE STATE OF CALIFORNIA OR ITS OFFICERS OR AGENTS SHALL NOT BE RESPONSIBLE FOR THE ACCURACY OR COMPLETENESS OF SCANNED COPIES OF THIS PLAN SHEET.</i></p>		


  

BAY AREA TOLL AUTHORITY 101 EIGHTEEN STREET OAKLAND, CA 94607	URS CORPORATION 55 S. MARKET STREET SUITE 1500 SAN JOSE, CA 95113
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## PROJECT NOTES (DUMBARTON BRIDGE)

**E-2**

SHEET	OF
2	15




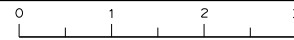

#REQUEST STATE OF CALIFORNIA - DEPARTMENT OF TRANSPORTATION CONSULTANT FUNCTIONAL SUPERVISOR CALCULATED-DESIGNED BY CHECKED BY REVISED BY DATE REVISED

Caltrans


CONDUITS TO BE INSTALLED THROUGH LUNCH ROOM.

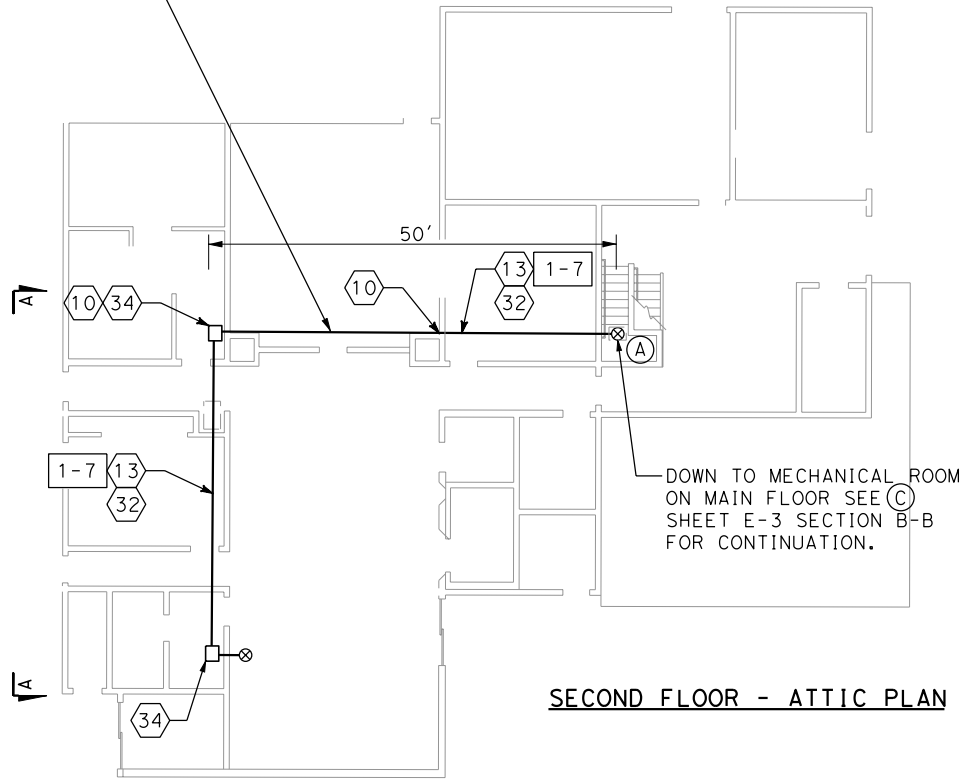

SECOND FLOOR - ATTIC PLAN

SHEET NOTES:

- ① CONTRACTOR TO USE EXISTING CONDUIT SUPPORT SYSTEM AS MUCH AS POSSIBLE. PROVIDE NEW SUPPORT SYSTEM AS NECESSARY.
- ② FINAL LOCATION OF CONDUIT AND JUNCTION BOX ROUTING AND ATTACHMENT DETAILS SHALL BE COORDINATED BY THE CONTRACTOR WITH THE ENGINEER PRIOR TO INSTALLATION.

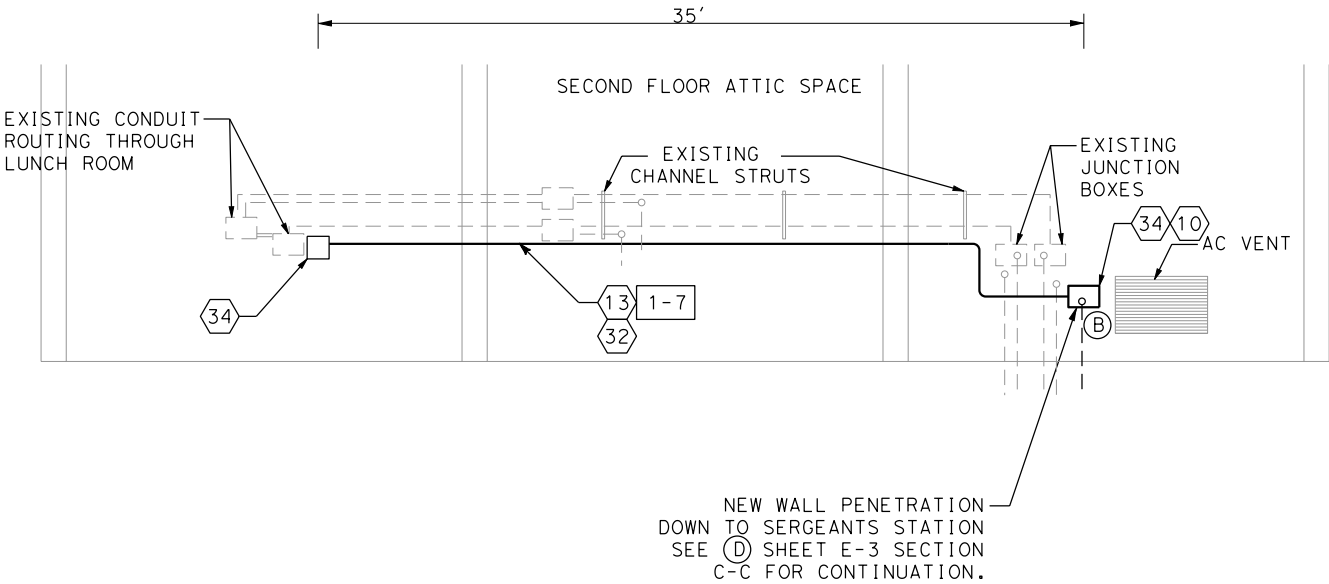

NEW WALL PENETRATION DOWN TO SERGEANTS STATION SEE (D) SHEET E-3 SECTION C-C FOR CONTINUATION.

SECTION A-A

TOLL PLAZA OPERATIONS BUILDING  
SECOND FLOOR ATTIC PLAN  
CONDUIT ROUTING  
(DUMBARTON BRIDGE)

NO SCALE

E-4

SHEET	OF
4	15

DIST	COUNTY	ROUTE	POST MILES TOTAL PROJECT	SHEET NO.	TOTAL SHEETS
04	Alameda	84	R3.21	59	123

REGISTERED CIVIL ENGINEER

3/12/10  
DATE

PLANS APPROVAL DATE

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101 EIGHTH STREET  
OAKLAND, CA 94607

URS CORPORATION  
55 S. MARKET STREET  
SUITE 1500  
SAN JOSE, CA 95113

REGISTERED PROFESSIONAL ENGINEER

RAMSEY J. HISSEN

No. C-39608

Exp. 12/31/10



CIVIL

STATE OF CALIFORNIA

REVISIONS

NO.	DESCRIPTION	DATE	BY	CHKD.
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3	REVISED PER COMMENTS	12/1/08	URS	URS
4	REVISED PER COMMENTS	12/1/08	URS	URS
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16	REVISED PER COMMENTS	12/1/08	URS	URS
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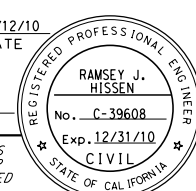
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REVISED BY	DATE REVISED				

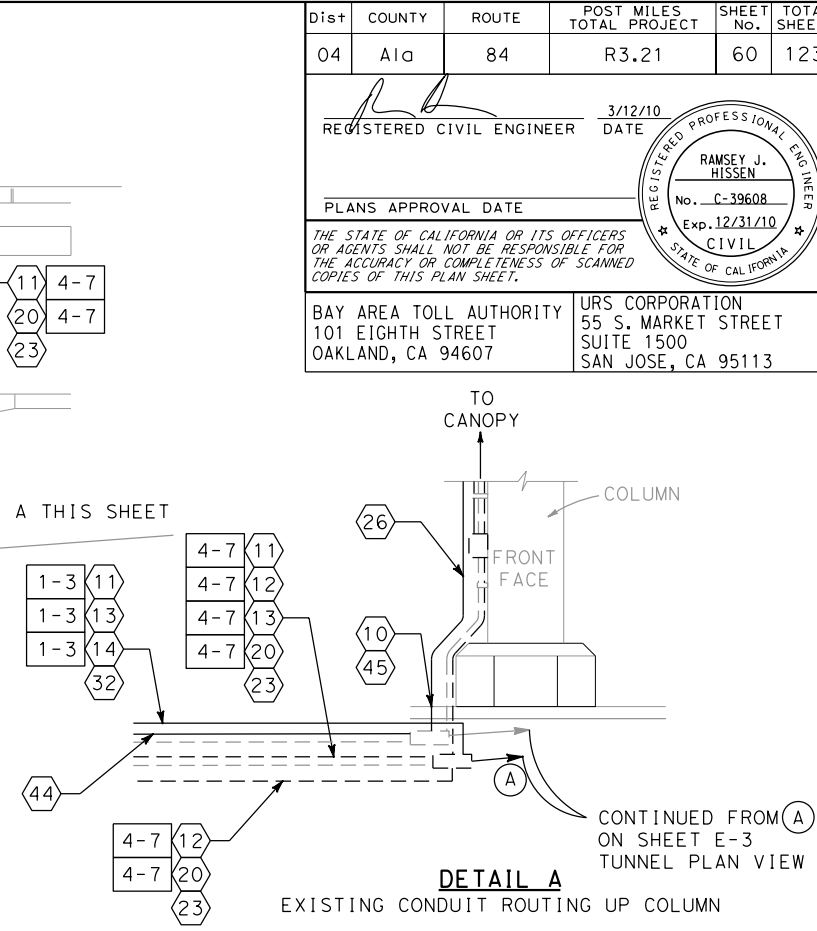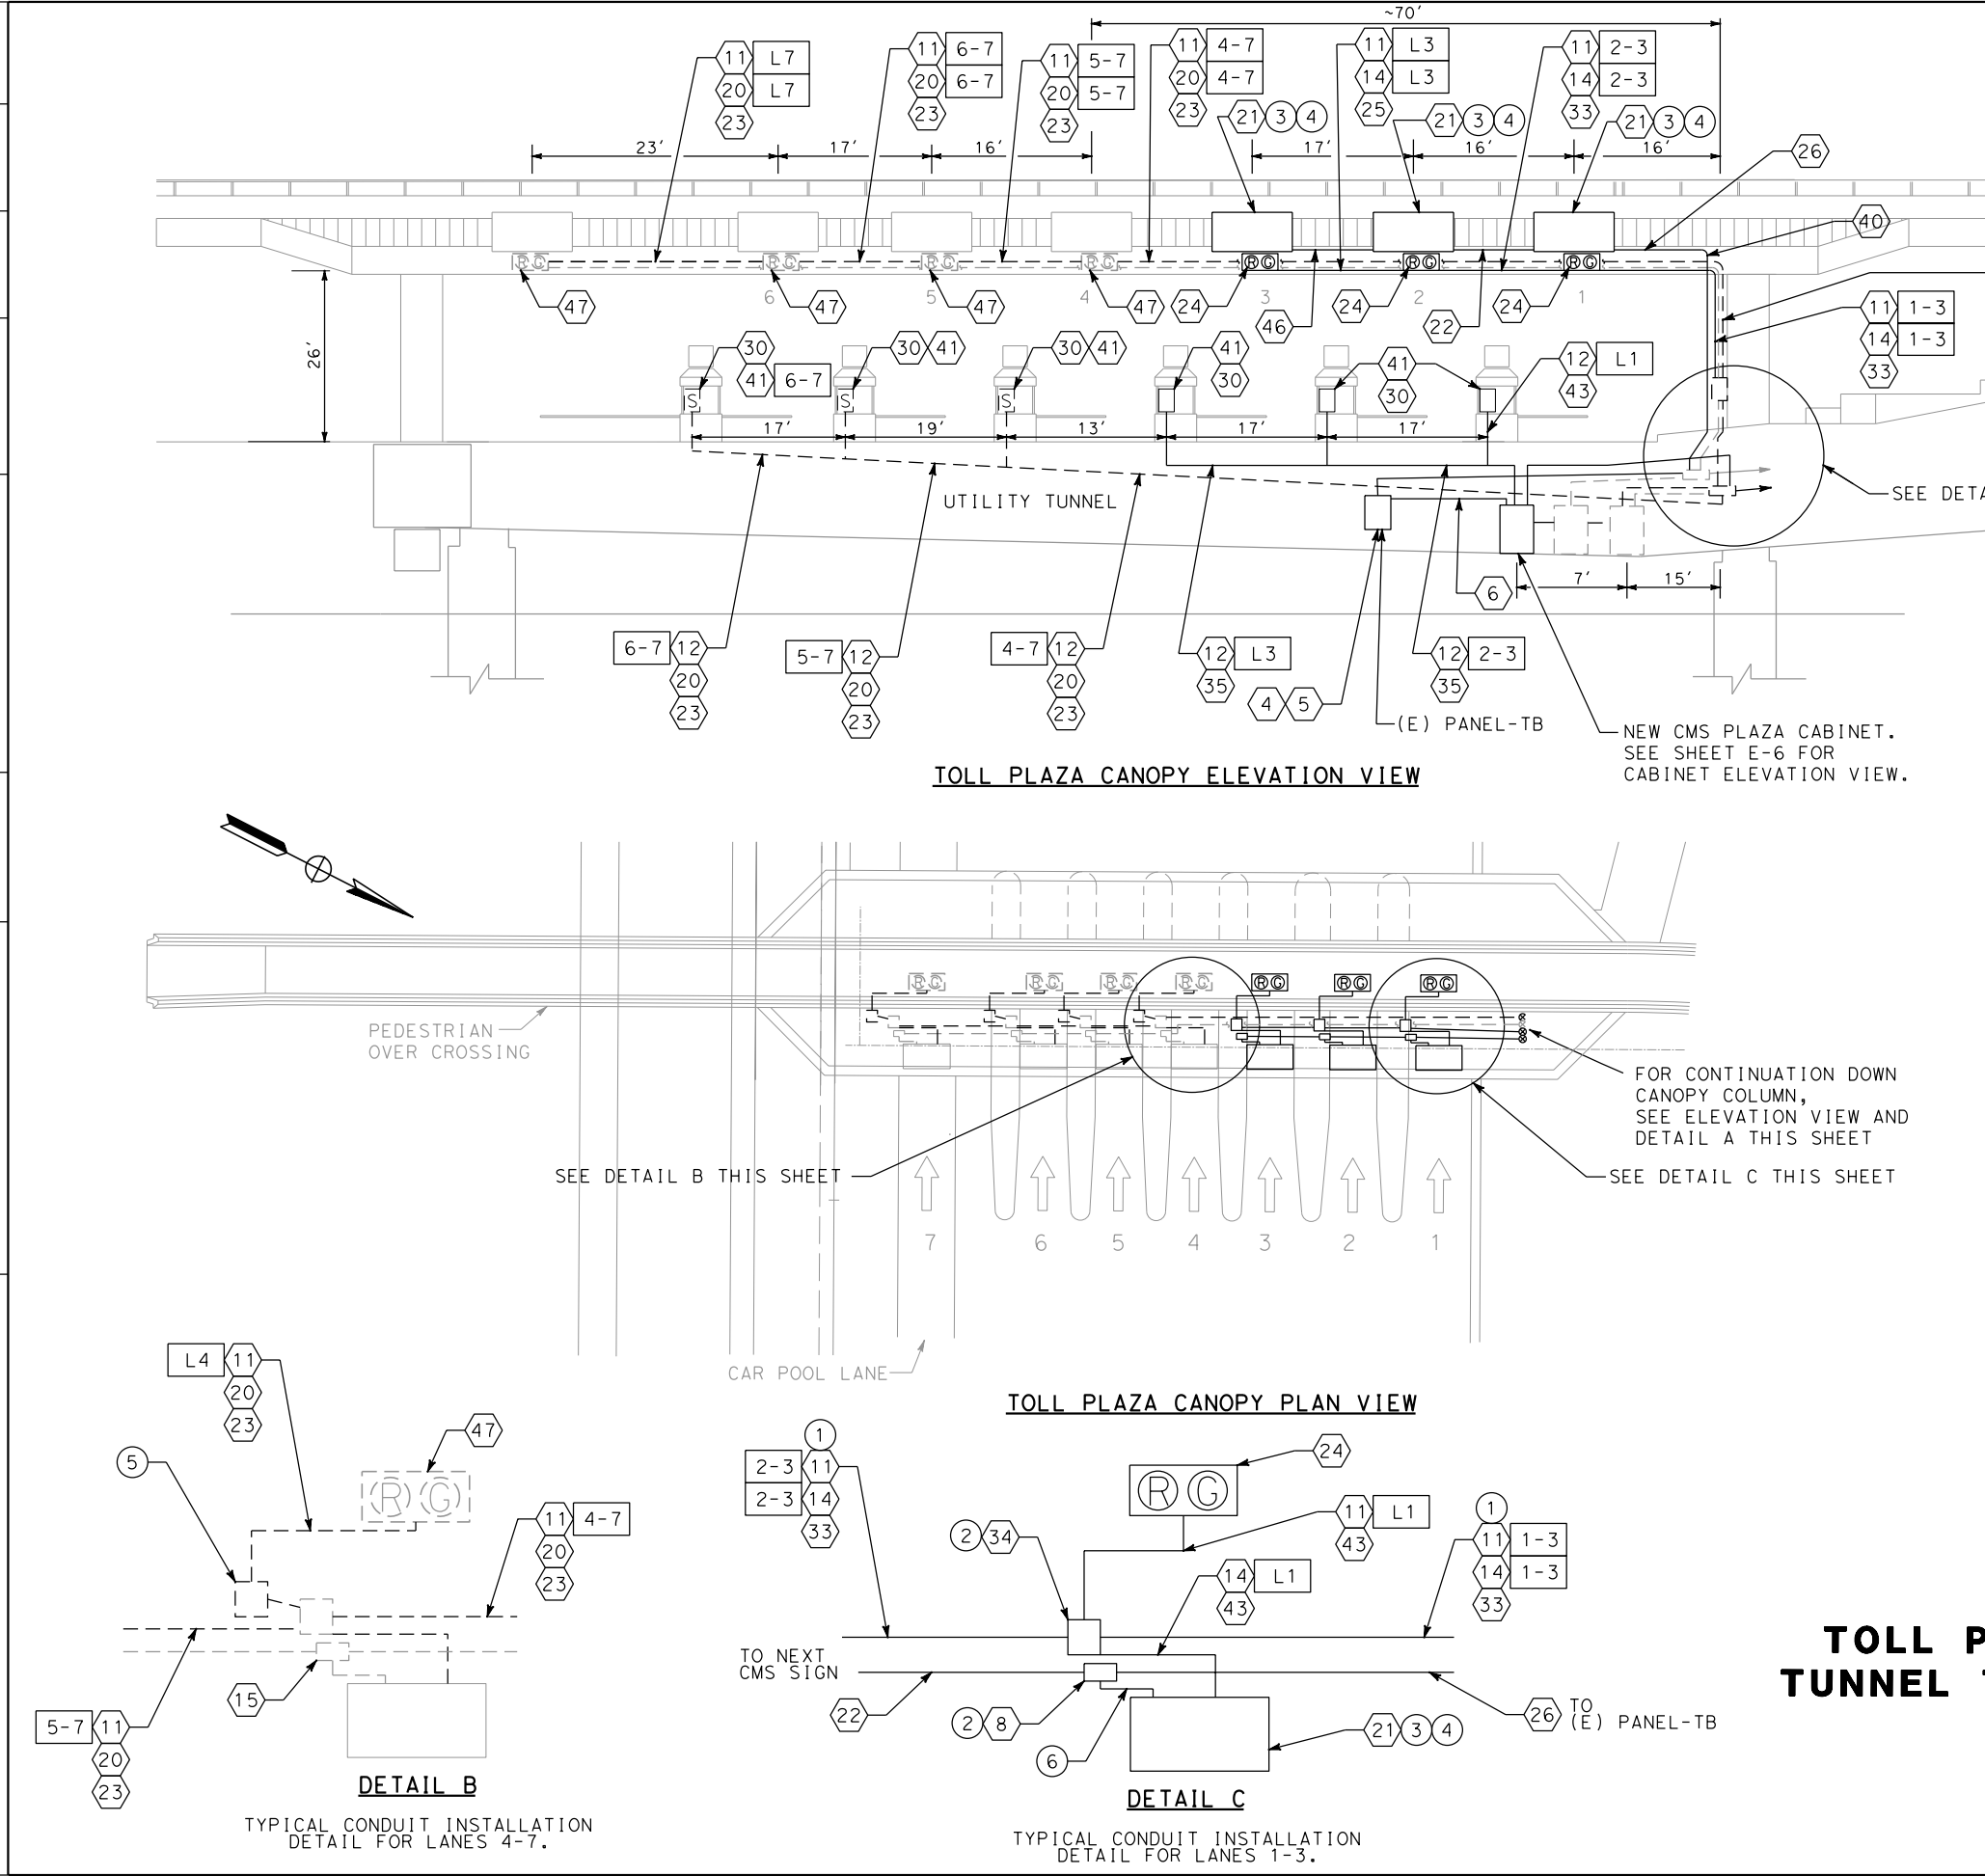

- NOTES:**
- 1 CONTRACTOR TO PROVIDE CONDUIT SUPPORT.
  - 2 FINAL LOCATION OF CONDUIT AND JUNCTION BOX ROUTING AND ATTACHMENT DETAILS SHALL BE COORDINATED BY THE CONTRACTOR WITH THE ENGINEER PRIOR TO INSTALLATION.
  - 3 REMOVE AND SALVAGE EXISTING STATIC SIGNS IN LANES 1-3 AND INSTALL NEW CMS PANELS.
  - 4 SEE SHEETS S-1, S-2 AND S-3 FOR CMS PANEL MOUNTING TO CANOPY DETAILS.
  - 5 CONTRACTOR TO REMOVE EXISTING RELAY AND CABLING TO INDICATOR LIGHT AND ROUTE NEW INDICATOR LIGHT CANOPY CABLE TO EXISTING CMS PLAZA CABINETS. SEE SHEET E-12 FOR INDICATOR LIGHT WIRING DIAGRAM FOR LANES 4-7.
  - 6 INSTALL NEW TYPE 4 (1" C) CONDUIT WITH 2 #12 & 1 #12G (120V, CMS POWER).

**TOLL PLAZA OPERATIONS BUILDING  
TUNNEL TO CANOPY CONDUIT ROUTING  
(DUMBARTON BRIDGE)**

NO SCALE



Dist	COUNTY	ROUTE	POST MILES TOTAL PROJECT	SHEET NO.	TOTAL SHEETS
04	Ala	84	R3.21	60	123
REGISTERED CIVIL ENGINEER			DATE	3/12/10	
PLANS APPROVAL DATE					
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BAY AREA TOLL AUTHORITY 101 EIGHTH STREET OAKLAND, CA 94607			URS CORPORATION 55 S. MARKET STREET SUITE 1500 SAN JOSE, CA 95113		



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\$#REQUEST

STATE OF CALIFORNIA - DEPARTMENT OF TRANSPORTATION




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DATE REVISED



NOTES:

1. REPLACE EXISTING GARRETCOM ETHERNET SWITCH IN CMS PLAZA CABINET #1 WITH NEW RACK MOUNTABLE SWITCH WITH MINIMUM 14 10/100 MBPS PORTS AND 2 FIBER 100 MBPS PORTS. OLD SWITCH SHALL BE RETURNED TO BATA.
2. ALL CABLING IN CMS CABINETS SHALL BE INSTALLED AND NEATLY DRESSED AND SECURED IN CABINETS. SPARE COILED CABLING SHALL BE PROVIDED IN JUNCTION BOXES.
3. CONTRACTOR TO REMOVE AND SALVAGE EXISTING TVSS. OLD TVSS SHALL BE RETURNED TO BATA.
4. SEE SHEETS E-3 AND E-5 FOR CMS CABINET LOCATIONS.
5. EXISTING CMS CONTROLLERS LOCATED IN EXISTING PLAZA CABINETS 1 AND 2 (LANES 1-4) SHALL BE REPLACED WITH NEW CMS CONTROLLERS TO BE PROVIDED WITH INTERNAL SURGE PROTECTION PER MANUFACTURER'S SPECS.
6. CONTRACTOR SHALL COORDINATE CLOSELY WITH BATA ON RE-CONFIGURATION OF CMS ETHERNET SWITCHES AND NETWORK OPERATIONS.
7. CONTRACTOR TO FIELD VERIFY THAT ALL TX/RX PORTS ARE MATCHED FOR PROPER OPERATIONS THROUGHOUT CMS NETWORK.
8. DO NOT CONNECT POWER STRIP TO GFI. CONNECT TO CABINET POWER SOURCE DIRECTLY BY MEANS OF A SEPARATE NEMA 5-15 SOCKET.

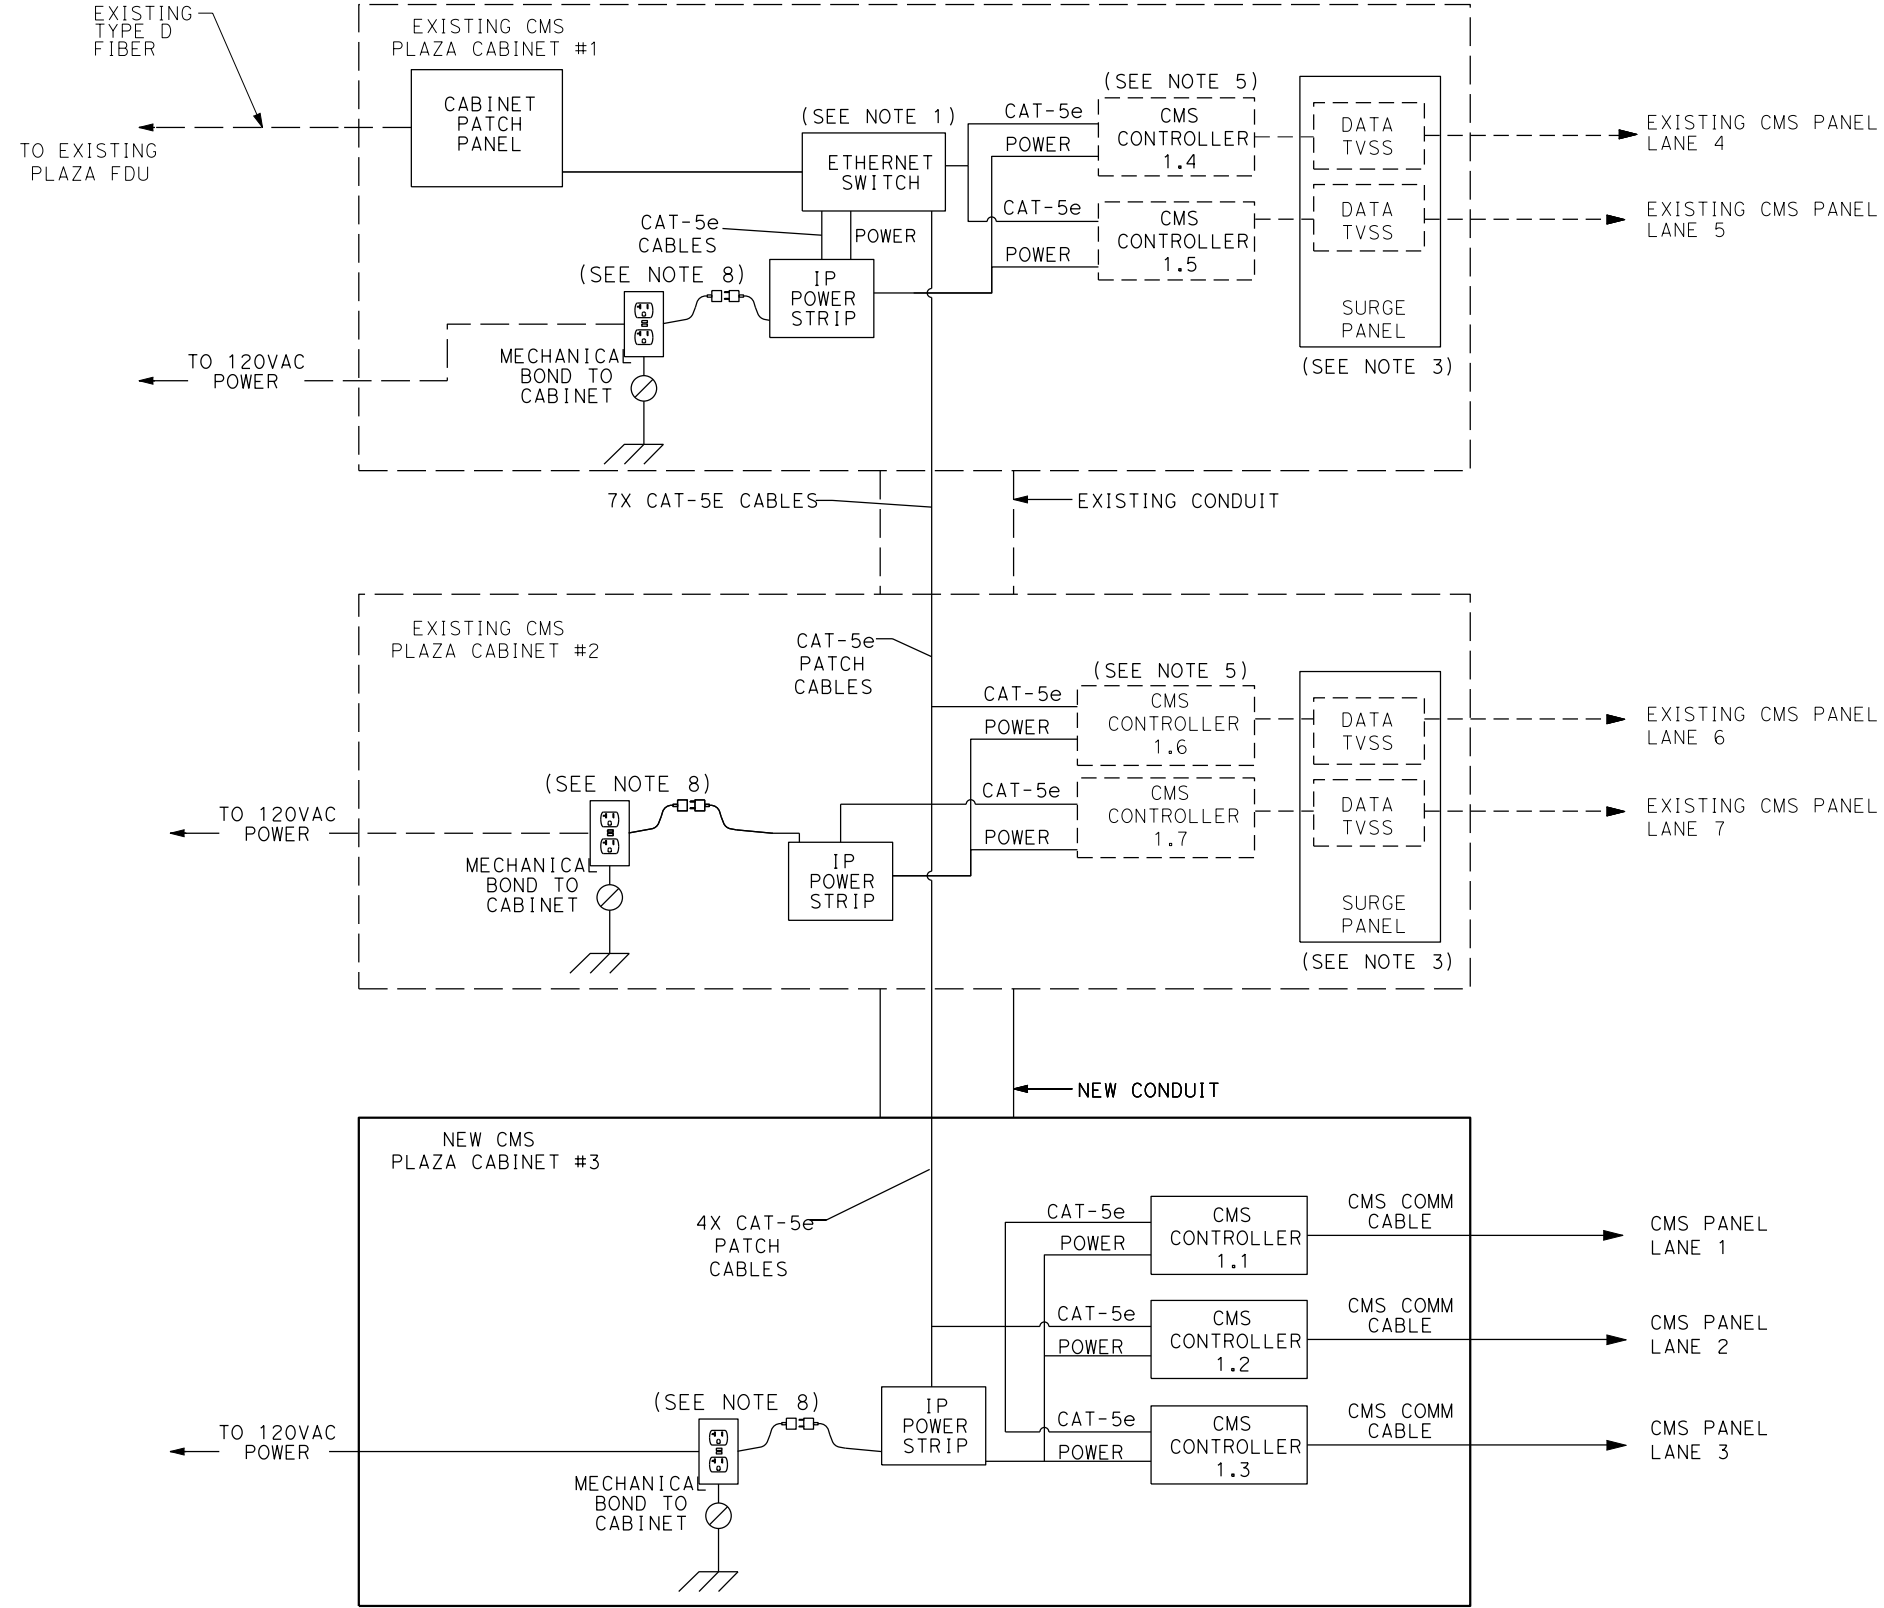CMS PLAZA CABINET  
WIRING SCHEMATIC  
FOR LANES 1-7  
(DUMBARTON BRIDGE)


NO SCALE

E-7

SHEET	OF
7	15

DIST	COUNTY	ROUTE	POST MILES TOTAL PROJECT	SHEET NO.	TOTAL SHEETS
04	Ala	84	R3.21	62	123
REGISTERED CIVIL ENGINEER			3/12/10	DATE	
PLANS APPROVAL DATE					
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BAY AREA TOLL AUTHORITY 101 EIGHTH STREET OAKLAND, CA 94607			URS CORPORATION 55 S. MARKET STREET SUITE 1500 SAN JOSE, CA 95113		

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EA TBD (BATA-0006)

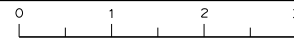BORDER LAST REVISED 2/1/2008

DATE REVISION  
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DATE PLOTTED => \$DATE  
TIME PLOTTED => \$TIME

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STATE OF CALIFORNIA - DEPARTMENT OF TRANSPORTATION



CONSULTANT FUNCTIONAL SUPERVISOR

CALCULATED-DESIGNED BY


CHECKED BY

REVISED BY

DATE REVISED

SHEET NOTES:

- 1 INSTALL NEW CIRCUIT BREAKER IN EXISTING SPACE.
- 2 THE CMS CABINET AND SIGNS SHALL BE CONNECTED TO THE BUILDING GROUNDING SYSTEM BY THE EQUIPMENT GROUND CONDUCTOR IN EACH CONDUIT.
- 3 ALL METAL PARTS OF THE ELECTRICAL SYSTEM SHALL BE BONDED TOGETHER PER CONTRACT SPECIFICATIONS.

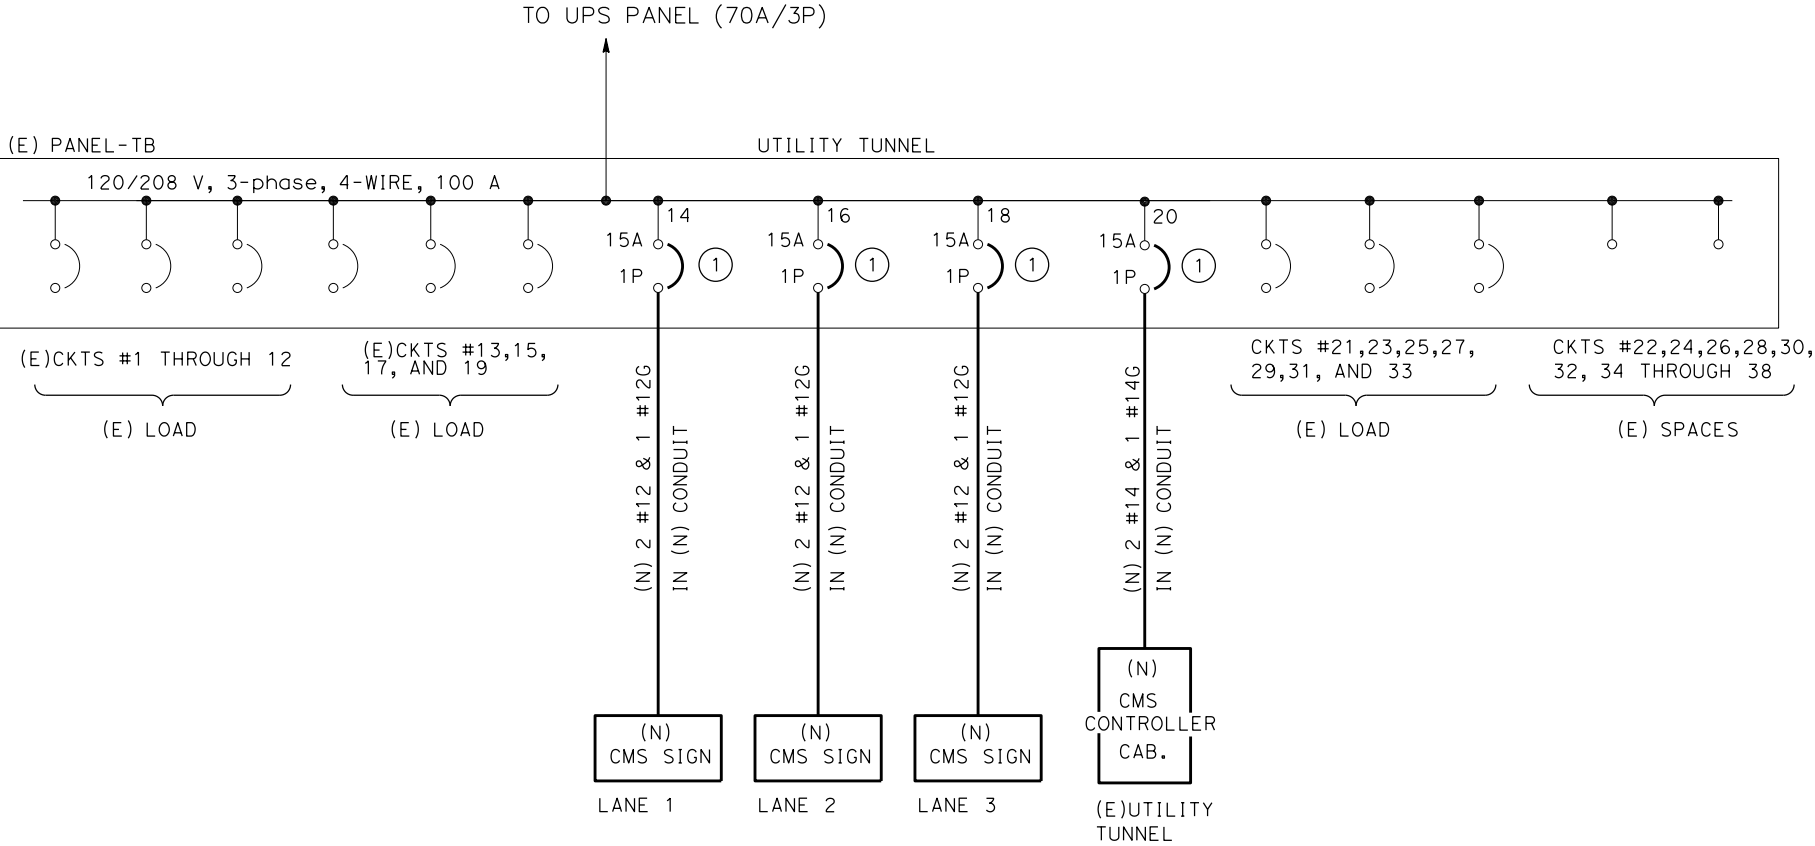

PARTIAL ONE LINE DIAGRAM  
(DUMBARTON BRIDGE)

NO SCALE

E-8

SHEET	OF
8	15

BORDER LAST REVISED 2/1/2008

RELATIVE BORDER SCALE  
IS IN INCHES



USERNAME => \$USER  
DGN FILE => \$REQUEST

CU 00000

EA TBD (BATA-0006)

Dist	COUNTY	ROUTE	POST MILES TOTAL PROJECT	SHEET No.	TOTAL SHEETS
04	Ala	84	R3.21	63	123

*Carol Light*  
REGISTERED CIVIL ENGINEER

3/12/10  
DATE

PLANS APPROVAL DATE

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BAY AREA TOLL AUTHORITY  
101 EIGHTH STREET  
OAKLAND, CA 94607

URS CORPORATION  
55 S. MARKET STREET  
SUITE 1500  
SAN JOSE, CA 95113

REGISTERED PROFESSIONAL ENGINEER  
CAROL LIGHT  
No. 10145  
Exp. 09/30/11  
ELECTRICAL  
STATE OF CALIFORNIA

DATE PLOTTED => \$DATE  
TIME PLOTTED => \$TIME





x

x

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x

x

\$REQUEST

STATE OF CALIFORNIA - DEPARTMENT OF TRANSPORTATION

Caltrans

CONSULTANT FUNCTIONAL SUPERVISOR

CALCULATED-  
DESIGNED BY

REVISOR

REVISOR

x

CHECKED BY


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DATE


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NOTES:

1. SIZE OF CONSOLE SWITCH PANEL WILL BE FIELD DETERMINED BY CONTRACTOR TO ACCOMMODATE NUMBER OF LANES.
2. SEE SHEET E-3 FOR LOCATION OF SWITCH CONSOLE PANEL.
3. SEE SHEETS E-11 AND E-12 FOR PROPOSED WIRING CONFIGURATION.
4. CONTRACTOR TO LABEL PUSH BUTTON SWITCH WITH R, G, AND A LETTERS FOR RED, GREEN, AND AMBER LANE INDICATION.



NEW TOLL BOOTH INDICATOR LIGHT SWITCH BOX

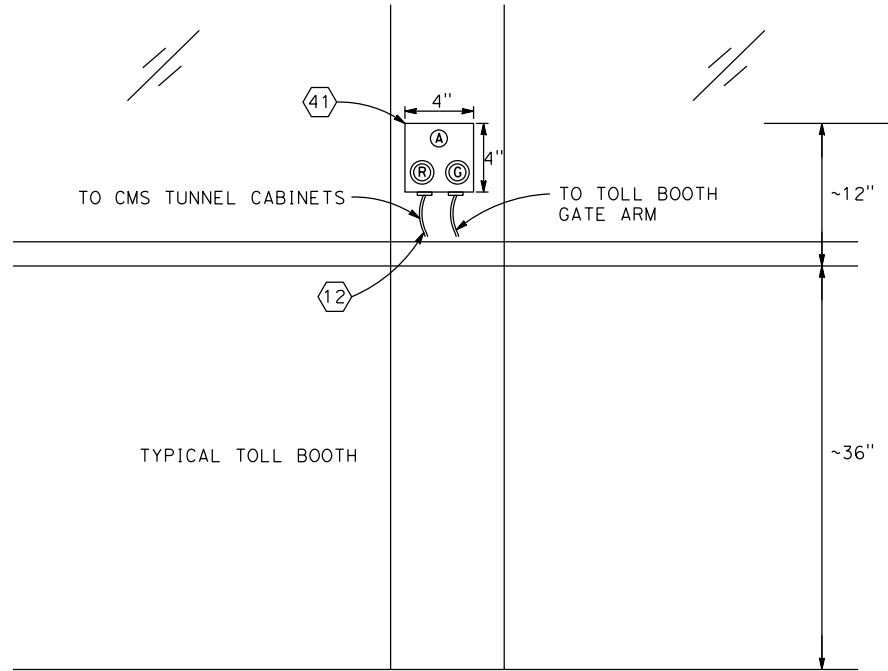

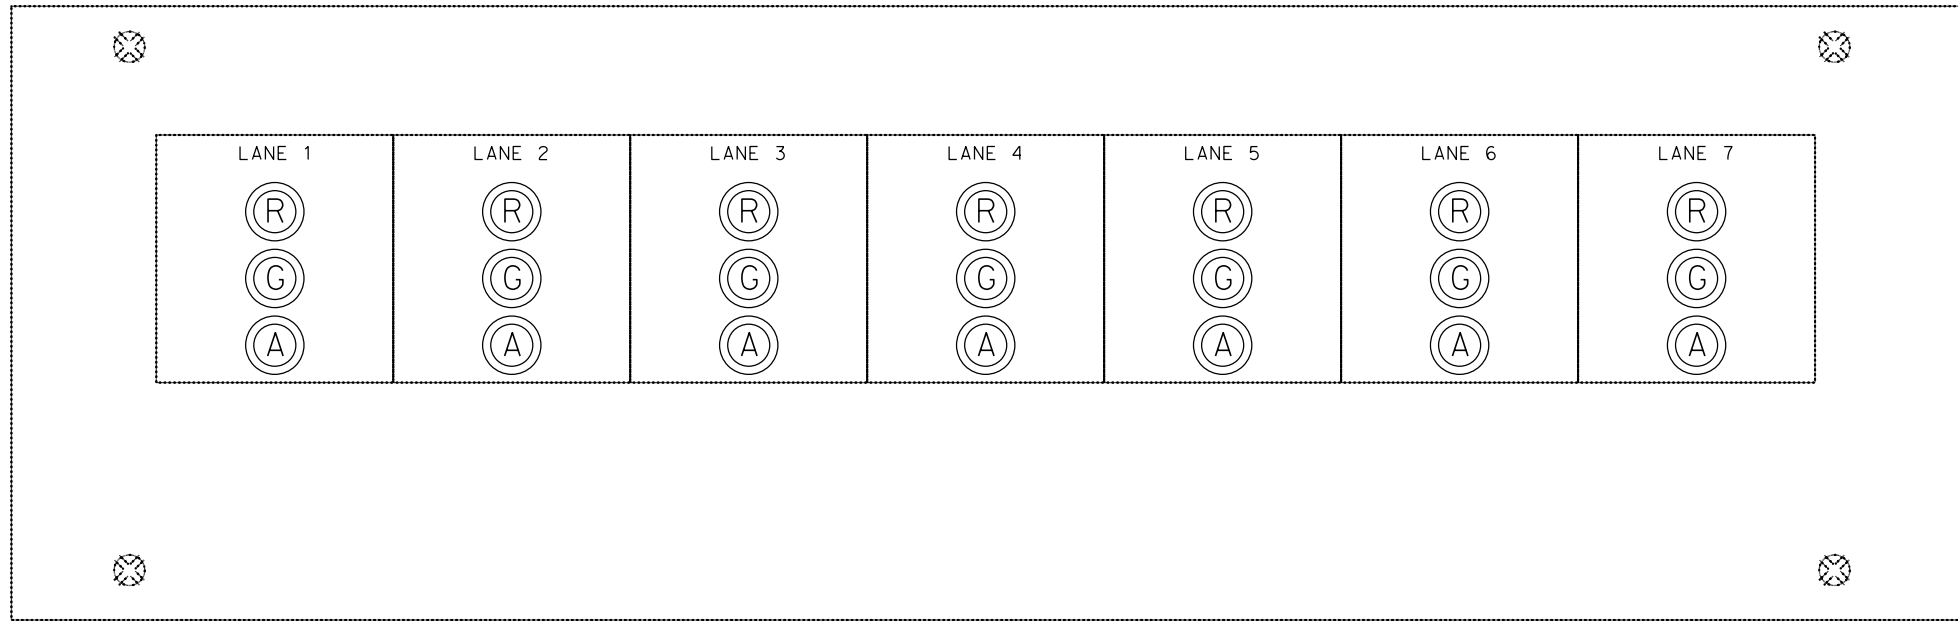NEW INDICATOR LIGHT SWITCH CONSOLE PANEL


INDICATOR LIGHT SWITCH CONSOLE PANEL  
AND TOLL BOOTH INDICATOR SWITCH BOX  
(DUMBARTON BRIDGE)

NO SCALE


E-10

SHEET	OF
10	15

DIST	COUNTY	ROUTE	POST MILES TOTAL PROJECT	SHEET NO.	TOTAL SHEETS
04	Alameda	84	R3.21	65	123
REGISTERED CIVIL ENGINEER			3/12/10	DATE	
PLANS APPROVAL DATE					
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RELATIVE BORDER SCALE  
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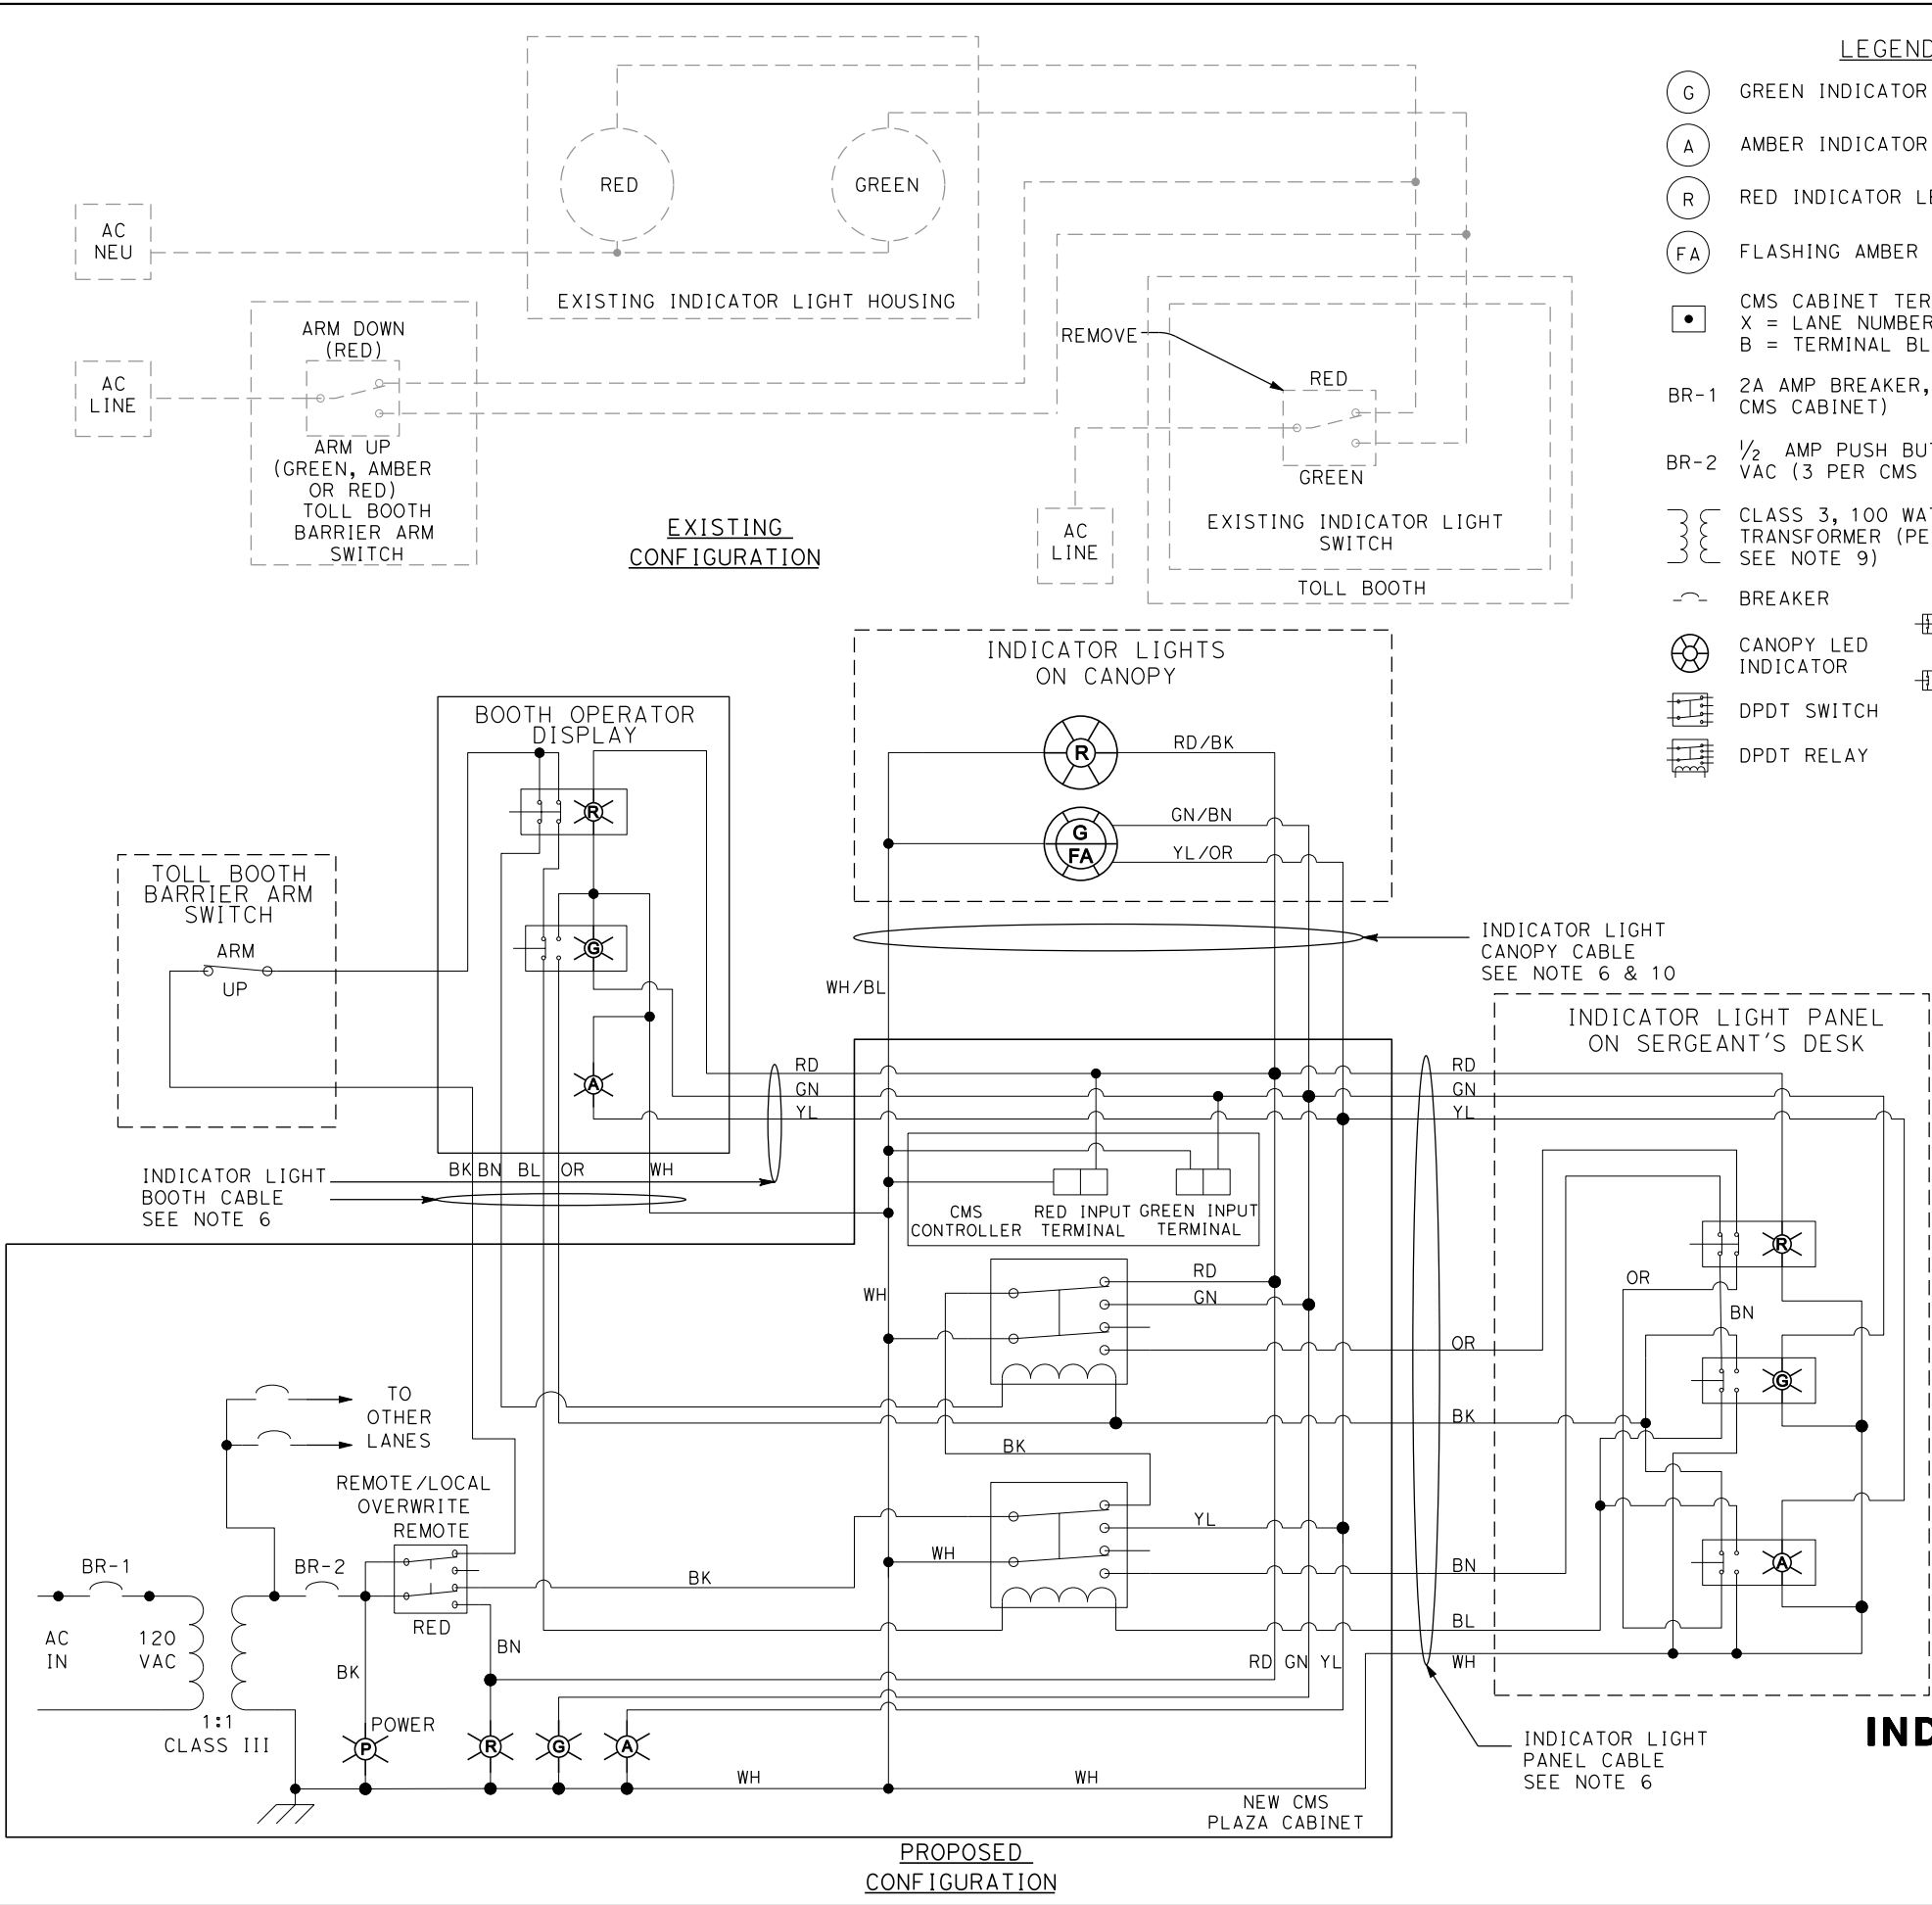

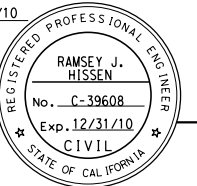
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DGN FILE => \$REQUEST

CU 00000

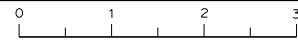EA TBD (BATA-0006)

DATE PLOTTED => \$DATE  
TIME PLOTTED => \$TIME



- LEGEND**
- (G) GREEN INDICATOR LED LIGHT, 120 VAC
  - (A) AMBER INDICATOR LED LIGHT, 120 VAC
  - (R) RED INDICATOR LED LIGHT, 120 VAC
  - (FA) FLASHING AMBER LED LIGHT, 120 VAC
  - CMS CABINET TERMINAL BLOCK X-B  
X = LANE NUMBER  
B = TERMINAL BLOCK NUMBER
  - BR-1 2A AMP BREAKER, 120 VAC (1 PER CMS CABINET)
  - BR-2 1/2 AMP PUSH BUTTON BREAKER, 120 VAC (3 PER CMS CABINET - SEE NOTE 7)
  - CLASS 3, 100 WATT 1:1, 120 VAC TRANSFORMER (PER 3 CMS CONTROLLERS SEE NOTE 9)
  - BREAKER
  - CANOPY LED INDICATOR
  - DPDT SWITCH
  - DPDT RELAY
  - NC + NC PUSH BUTTON SWITCH W/ INDICATOR
  - NC + NO PUSH BUTTON SWITCH W/ INDICATOR
  - PANEL MOUNT LIGHT INDICATOR (120 VAC)

- NOTES:**
- ELECTRICAL DIAGRAM SHOWS A SINGLE (ONE) FASTRAK LANE FOR SIMPLICITY.
  - SEE SHEET E-10 FOR INDICATOR LIGHT SWITCH CONSOLE PANEL DETAIL.
  - POWER TO TRANSFORMER FROM CMS CABINET POWER STRIP. ONE TRANSFORMER PER CMS CABINET.
  - REMOVE EXISTING SWITCH AND INSTALL NEW INDICATOR LED LIGHTS AND PUSH BUTTON SWITCHES ON WALL BOX.
  - BELDEN 5506UE OR APPROVED EQUIVALENT.
  - REPLACE EXISTING GREEN INDICATOR LIGHT ON CANOPY WITH NEW GREEN / FLASHING AMBER LED LIGHT.
  - ONE (1) 1/2 AMP PUSH BUTTON BREAKER PER CMS CONTROLLER OR THREE (3) 1/2 AMP PUSH BUTTON BREAKERS PER CMS CABINET WITH 3 CMS CONTROLLERS.
  - INTERCEPT EXISTING GATE ARM CABLE IN TOLL BOOTH.
  - ONE (1) CLASS THREE, 100W 1:1, 120 VAC TRANSFORMER PER 3 CMS CONTROLLERS.
  - USE TWO CONDUCTORS FOR NEUTRAL, TWO CONDUCTORS FOR RED, TWO CONDUCTORS FOR GREEN, AND TWO CONDUCTORS FOR FLASHING AMBER CONNECTIONS FROM CMS CABINET TO INDICATOR LIGHTS ON CANOPY.

**INDICATOR LIGHT WIRING DIAGRAM  
FOR LANES 1-3  
(DUMBARTON BRIDGE)**

NO SCALE

DIST	COUNTY	ROUTE	POST MILES TOTAL PROJECT	SHEET NO.	TOTAL SHEETS
04	Alameda	84	R3.21	66	123

REGISTERED CIVIL ENGINEER

3/12/10 DATE

PLANS APPROVAL DATE

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101 EIGHTH STREET  
OAKLAND, CA 94607

URS CORPORATION  
55 S. MARKET STREET  
SUITE 1500  
SAN JOSE, CA 95113

REGISTERED PROFESSIONAL ENGINEER

RAMSEY J. HISEN

No. C-39608

Exp. 12/31/10

CIVIL

STATE OF CALIFORNIA




#REQUEST STATE OF CALIFORNIA - DEPARTMENT OF TRANSPORTATION CONSULTANT FUNCTIONAL SUPERVISOR

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DATE REVISED

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CHECKED BY



Dist	COUNTY	ROUTE	POST MILES TOTAL PROJECT	SHEET No.	TOTAL SHEETS
04	Ala	84	R3.21	68	123
REGISTERED CIVIL ENGINEER			3/12/10 DATE	REGISTERED PROFESSIONAL ENGINEER RAMSEY J. HISSEN No. C-39608 Exp. 12/31/10 CIVIL STATE OF CALIFORNIA	
PLANS APPROVAL DATE					
THE STATE OF CALIFORNIA OR ITS OFFICERS OR AGENTS SHALL NOT BE RESPONSIBLE FOR THE ACCURACY OR COMPLETENESS OF SCANNED COPIES OF THIS PLAN SHEET.					
BAY AREA TOLL AUTHORITY 101 EIGHTH STREET OAKLAND, CA 94607			URS CORPORATION 55 S. MARKET STREET SUITE 1500 SAN JOSE, CA 95113		

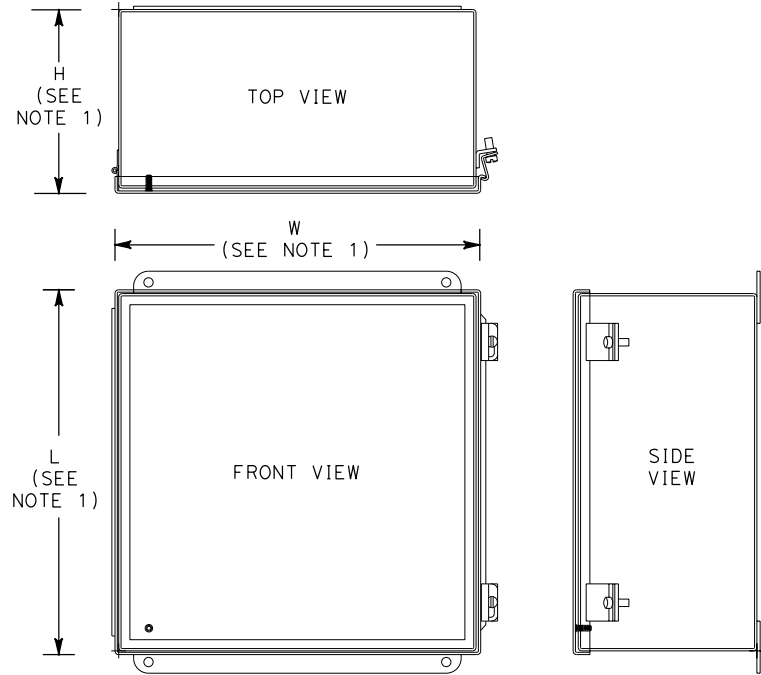

NEMA 4X JUNCTION BOX  
(SHOWN WITH HINGE)

NOTES:

1. TYPE 1 NEMA 4X JUNCTION BOX (12"L X 12"W X 6"D, TYP.) OR AS REQ'D.  
TYPE 3 NEMA 4X JUNCTION BOX (5"L X 6"W X 4"D, TYP.) OR AS REQ'D.
2. MINIMUM SIZES OF JUNCTION BOXES SHOWN. CONTRACTOR SHALL  
CONFIRM SIZES AND QUANTITIES IN FIELD AND SUBMIT SHOP  
DRAWINGS TO ENGINEER FOR APPROVAL.
3. FOR JUNCTION BOX MOUNTED ON EXISTING CONCRETE WALLS OR  
SURFACE FLOOR MOUNTED USE 3/8" EXPANSION ANCHORS, TOTAL  
OF 4 FOR EACH BOX.
4. COIL A MINIMUM OF 3' OF CABLE FOR EACH DEVICE IN THE TYPE 1  
AND TYPE 3 JUNCTION BOXES.

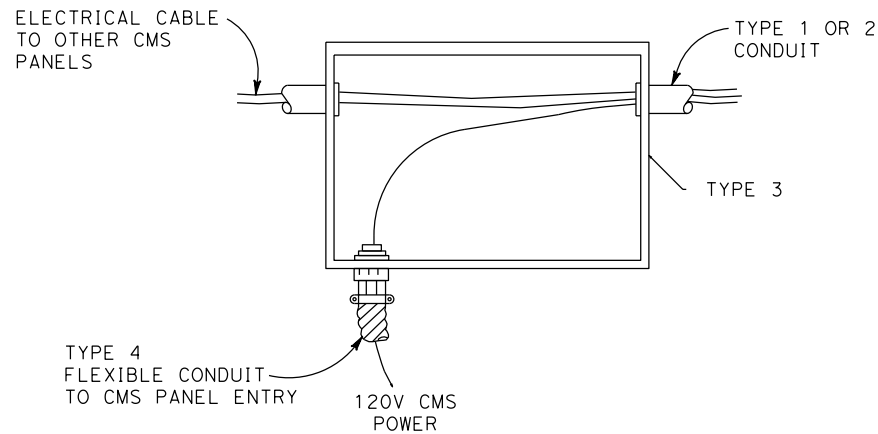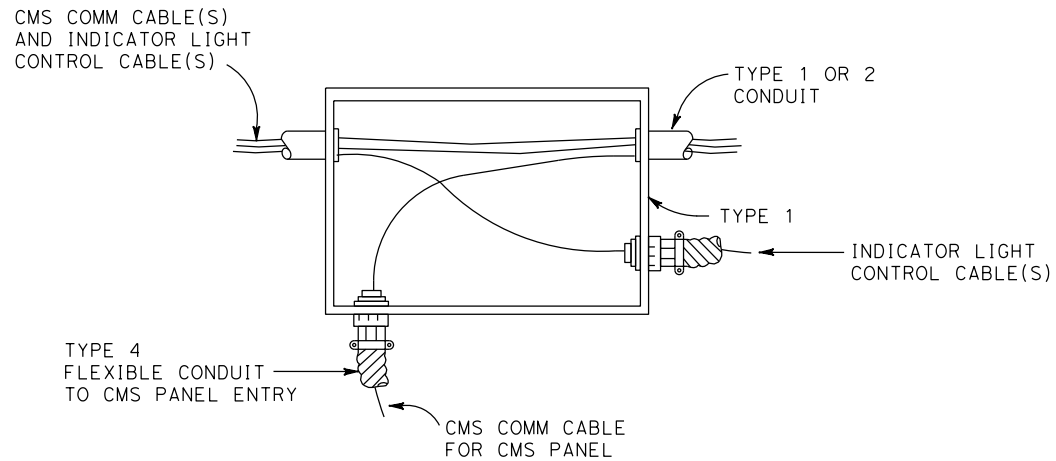

JUNCTION BOX DETAILS  
(DUMBARTON BRIDGE)

NO SCALE

E-13

SHEET	OF
13	15

RELATIVE BORDER SCALE  
IS IN INCHES

USERNAME => \$USER  
DGN FILE => \$REQUEST

CU 00000


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BORDER LAST REVISED 2/1/2008


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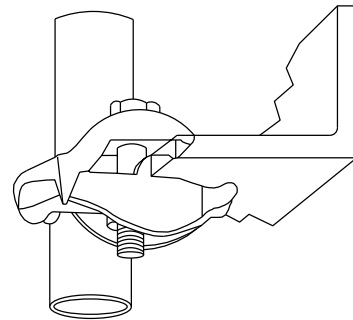
#REQUEST	STATE OF CALIFORNIA - DEPARTMENT OF TRANSPORTATION	CONSULTANT FUNCTIONAL SUPERVISOR	CALCULATED-DESIGNED BY	CHECKED BY	REVISED BY	DATE REVISED



FOR MOUNTING PIPES OR  
CONDUIT AT RIGHT ANGLES  
TO THE BEAM DETAIL

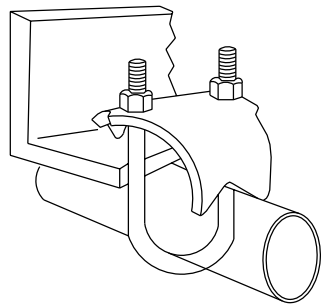


FOR MOUNTING PIPES OR CONDUIT  
PARALLEL TO THE BEAM DETAIL

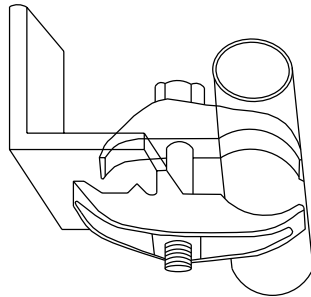


FOR MOUNTING PIPES OR  
CONDUIT VERTICALLY ACROSS  
BEAM EDGE DETAIL

DIST	COUNTY	ROUTE	POST MILES TOTAL PROJECT	SHEET NO.	TOTAL SHEETS
04	Ala	84	R3.21	69	123
REGISTERED CIVIL ENGINEER			3/12/10 DATE	<div>REGISTERED PROFESSIONAL ENGINEER RAMSEY J. HISSEN No. C-39608 Exp. 12/31/10 CIVIL STATE OF CALIFORNIA</div>	
PLANS APPROVAL DATE					
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TYPICAL EQUIPMENT SUPPORT CHANNEL,  
FITTINGS AND FASTENERS

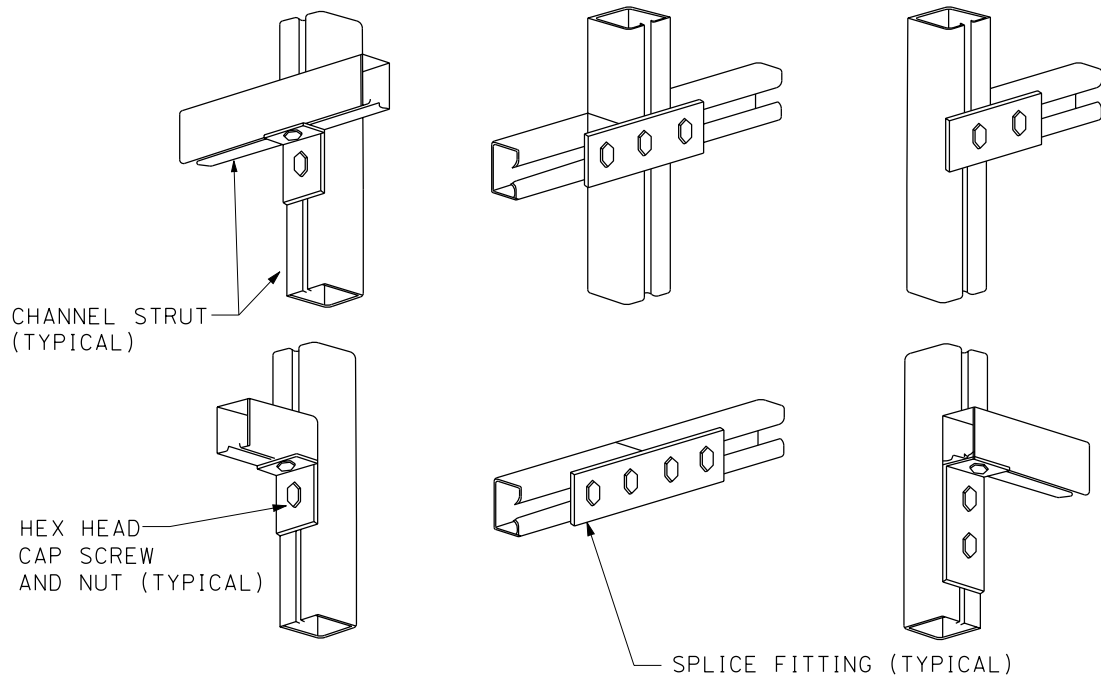

MOUNTING ON STRUT DETAILS
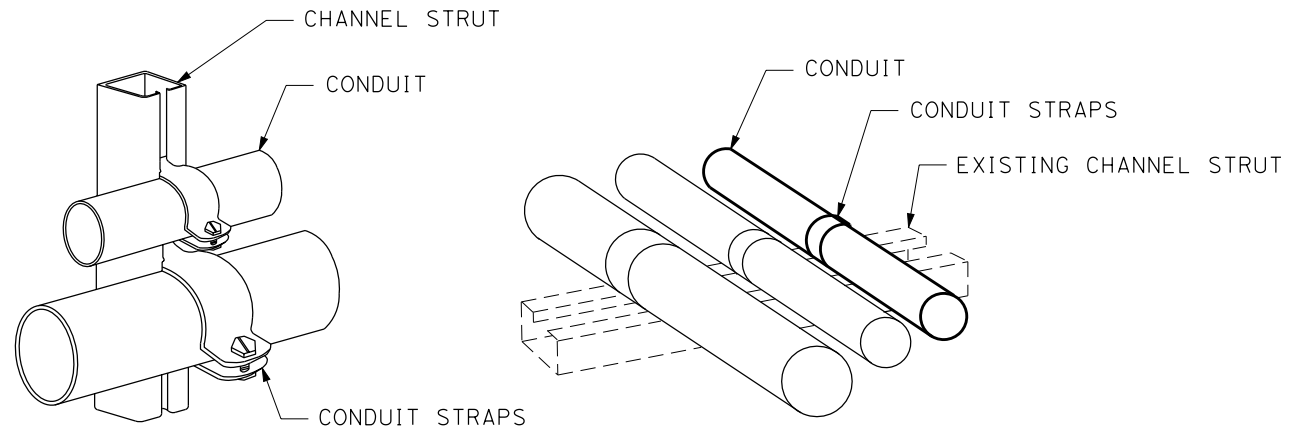
## CONDUIT MOUNTING AND ATTACHMENT DETAILS (DUMBARTON BRIDGE)

NO SCALE

E-14

SHEET	OF
14	15

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x

x

x

x

\$REQUEST

STATE OF CALIFORNIA - DEPARTMENT OF TRANSPORTATION

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DESIGNED BY

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REVISOR


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REVISOR


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ITEM	COMPONENT
①	ONE (1) NEW PANEL MOUNT DPDT TOGGLE SWITCH
②	NEW PANEL MOUNT RED, GREEN, AMBER LED INDICATOR LIGHTS (120VAC)
③	TERMINAL BLOCKS FOR INDICATOR LIGHT CANOPY CABLE AND POWER
④	ONE (1) NEW PANEL MOUNT 1/2 AMP PUSH BUTTON BREAKER (120 VAC)
⑤	INSTALL NEW PULL OUT DRAWER FOR WIRING OF NEW INDICATOR LIGHT RELAYS.
⑥	TWO (2) NEW DPDT RELAYS
⑦	DRILLED HOLES AT BOTTOM OF DRAWER FOR INDICATOR LIGHT CABLE
⑧	NEW PANEL MOUNT BLUE LED INDICATOR LIGHT (120VAC) FOR POWER INDICATION
⑨	TERMINAL BLOCKS FOR INDICATOR LIGHT BOOTH CABLE
⑩	TERMINAL BLOCKS FOR INDICATOR LIGHT PANEL CABLE

TOP VIEW



FRONT VIEW

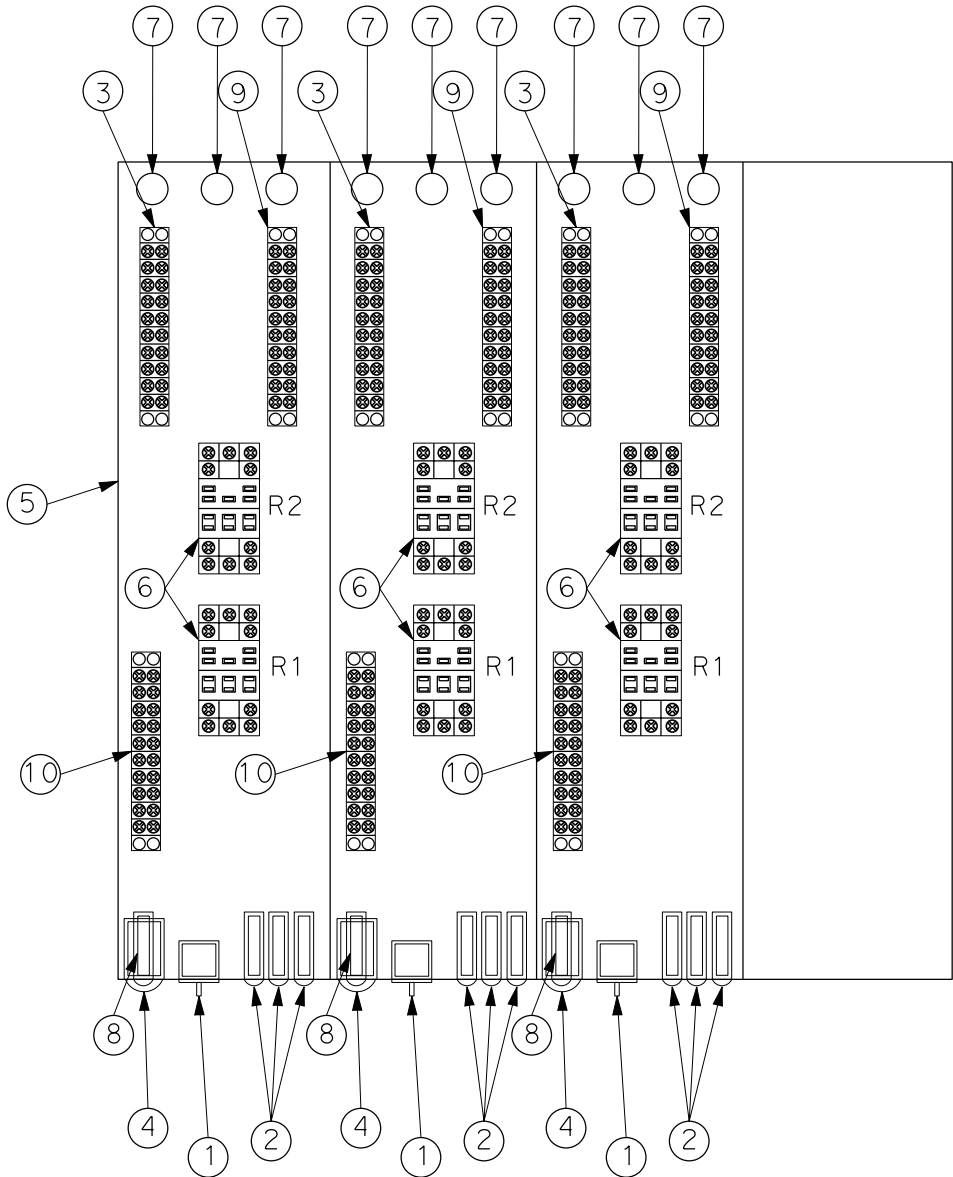

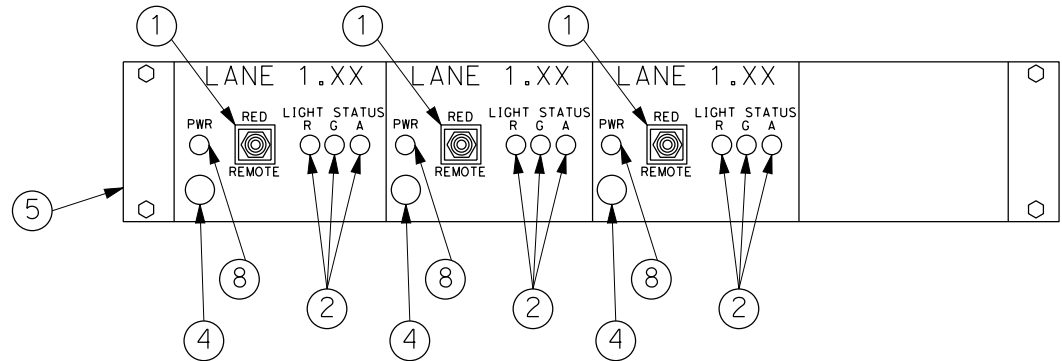DIST	COUNTY	ROUTE	POST MILES TOTAL PROJECT	SHEET NO.	TOTAL SHEETS
04	Alameda	84	R3.21	70	123
REGISTERED CIVIL ENGINEER			3/12/10 DATE	REGISTERED PROFESSIONAL ENGINEER RAMSEY J. HESSEN No. C-39608 Exp. 12/31/10 CIVIL STATE OF CALIFORNIA	
PLANS APPROVAL DATE					
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BAY AREA TOLL AUTHORITY 101 EIGHTH STREET OAKLAND, CA 94607			URS CORPORATION 55 S. MARKET STREET SUITE 1500 SAN JOSE, CA 95113		

NOTES:

1. ALL EQUIPMENT SHALL BE SECURED. NO EQUIPMENT WILL BE LAYING IN BOTTOM OF CABINET. INSTALLATION SHALL BE NEAT, DRESSED AND ACCORDING TO THE PLANS.
2. CONTRACTOR SHALL SUBMIT MATERIAL SUBMITTALS FOR ALL CABINET COMPONENTS TO THE ENGINEER FOR REVIEW AND APPROVAL PRIOR TO PROCUREMENT AND INSTALLATION.
3. INDICATOR LIGHT CABLES TO BE WIRED ACCORDING TO THE INDICATOR LIGHT WIRING DIAGRAMS AS SHOWN ON SHEETS E-11 TO E-12.
4. INDICATOR LIGHT DRAWER LAYOUT SHOWN FOR TYPICAL CMS CABINET.
5. ROUTE ALL CABLES THROUGH DRILLED HOLES AT BOTTOM OF DRAWER. INCLUDE PLASTIC GROMMETS IN HOLE.
6. TERMINATE ALL CABLES ON NEW TERMINATION BLOCKS.
7. FASTEN ALL CABLES TO DRAWER TO PREVENT STRAINING ON TERMINATION BLOCKS.
8. EACH CABINET DRAWER SHALL BE DESIGNED TO ACCOMMODATE UP TO FOUR (4) INDICATOR CONTROL LANES.
9. CONTRACTOR TO LEAVE AT LEAST ONE RACK UNIT OF SPACE BETWEEN DRAWER AND BOTTOM OF CABINET.

INDICATOR LIGHT  
CABINET DRAWER LAYOUT  
(DUMBARTON BRIDGE)

NO SCALE

E-15

SHEET	OF
15	15

DIST	COUNTY	ROUTE	POST MILES TOTAL PROJECT	SHEET NO	TOTAL SHEETS
04	CC	580	6.13	71	123

*John*  
REGISTERED CIVIL ENGINEER      DATE 3/12/10



PLANS APPROVAL DATE \_\_\_\_\_

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
BAY AREA TOLL AUTHORITY  
101 EIGHT STREET  
OAKLAND, CALIFORNIA 94607

MGE ENGINEERING, INC.  
7415 GREENHAVEN DRIVE, SUITE 100  
SACRAMENTO, CALIFORNIA 95831

REGISTERED PROFESSIONAL ENGINEER  
GROUPING XU  
NO. C 63977  
Exp. 09/30/10  
CIVIL  
STATE OF CALIFORNIA

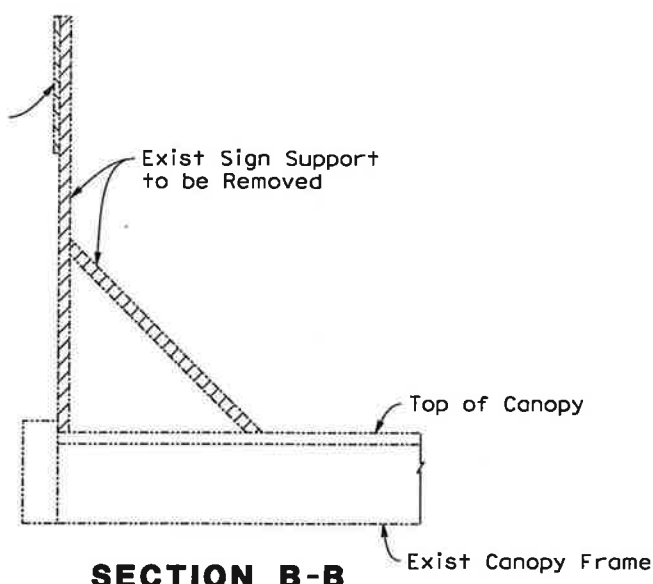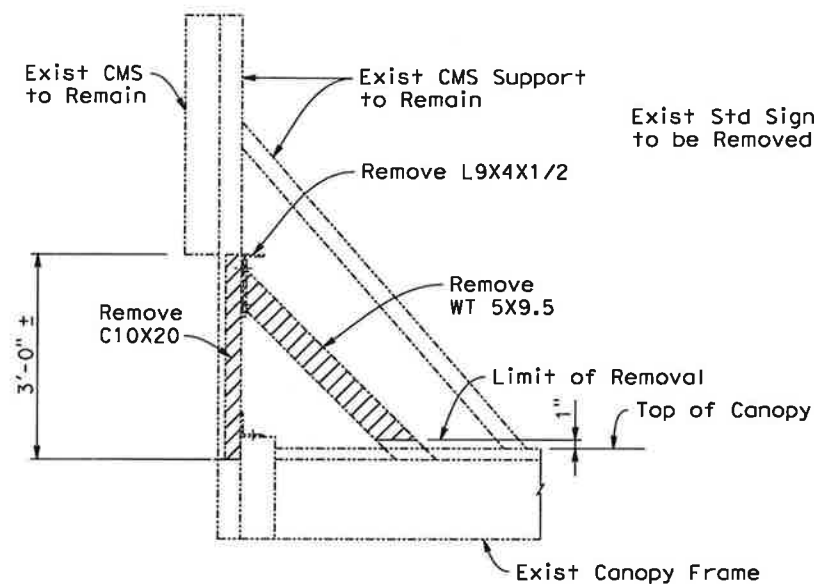


### LEGEND

----- Indicates Exist Structure  
 ————— Indicates New Structure  
 Indicates Removal of Exist Brackets and Signs

**Note:**

Part of roof materials contain asbestos and due precaution and protective measures shall be taken by Contractor when removing portion of roof materials. Refer to special provisions for details.

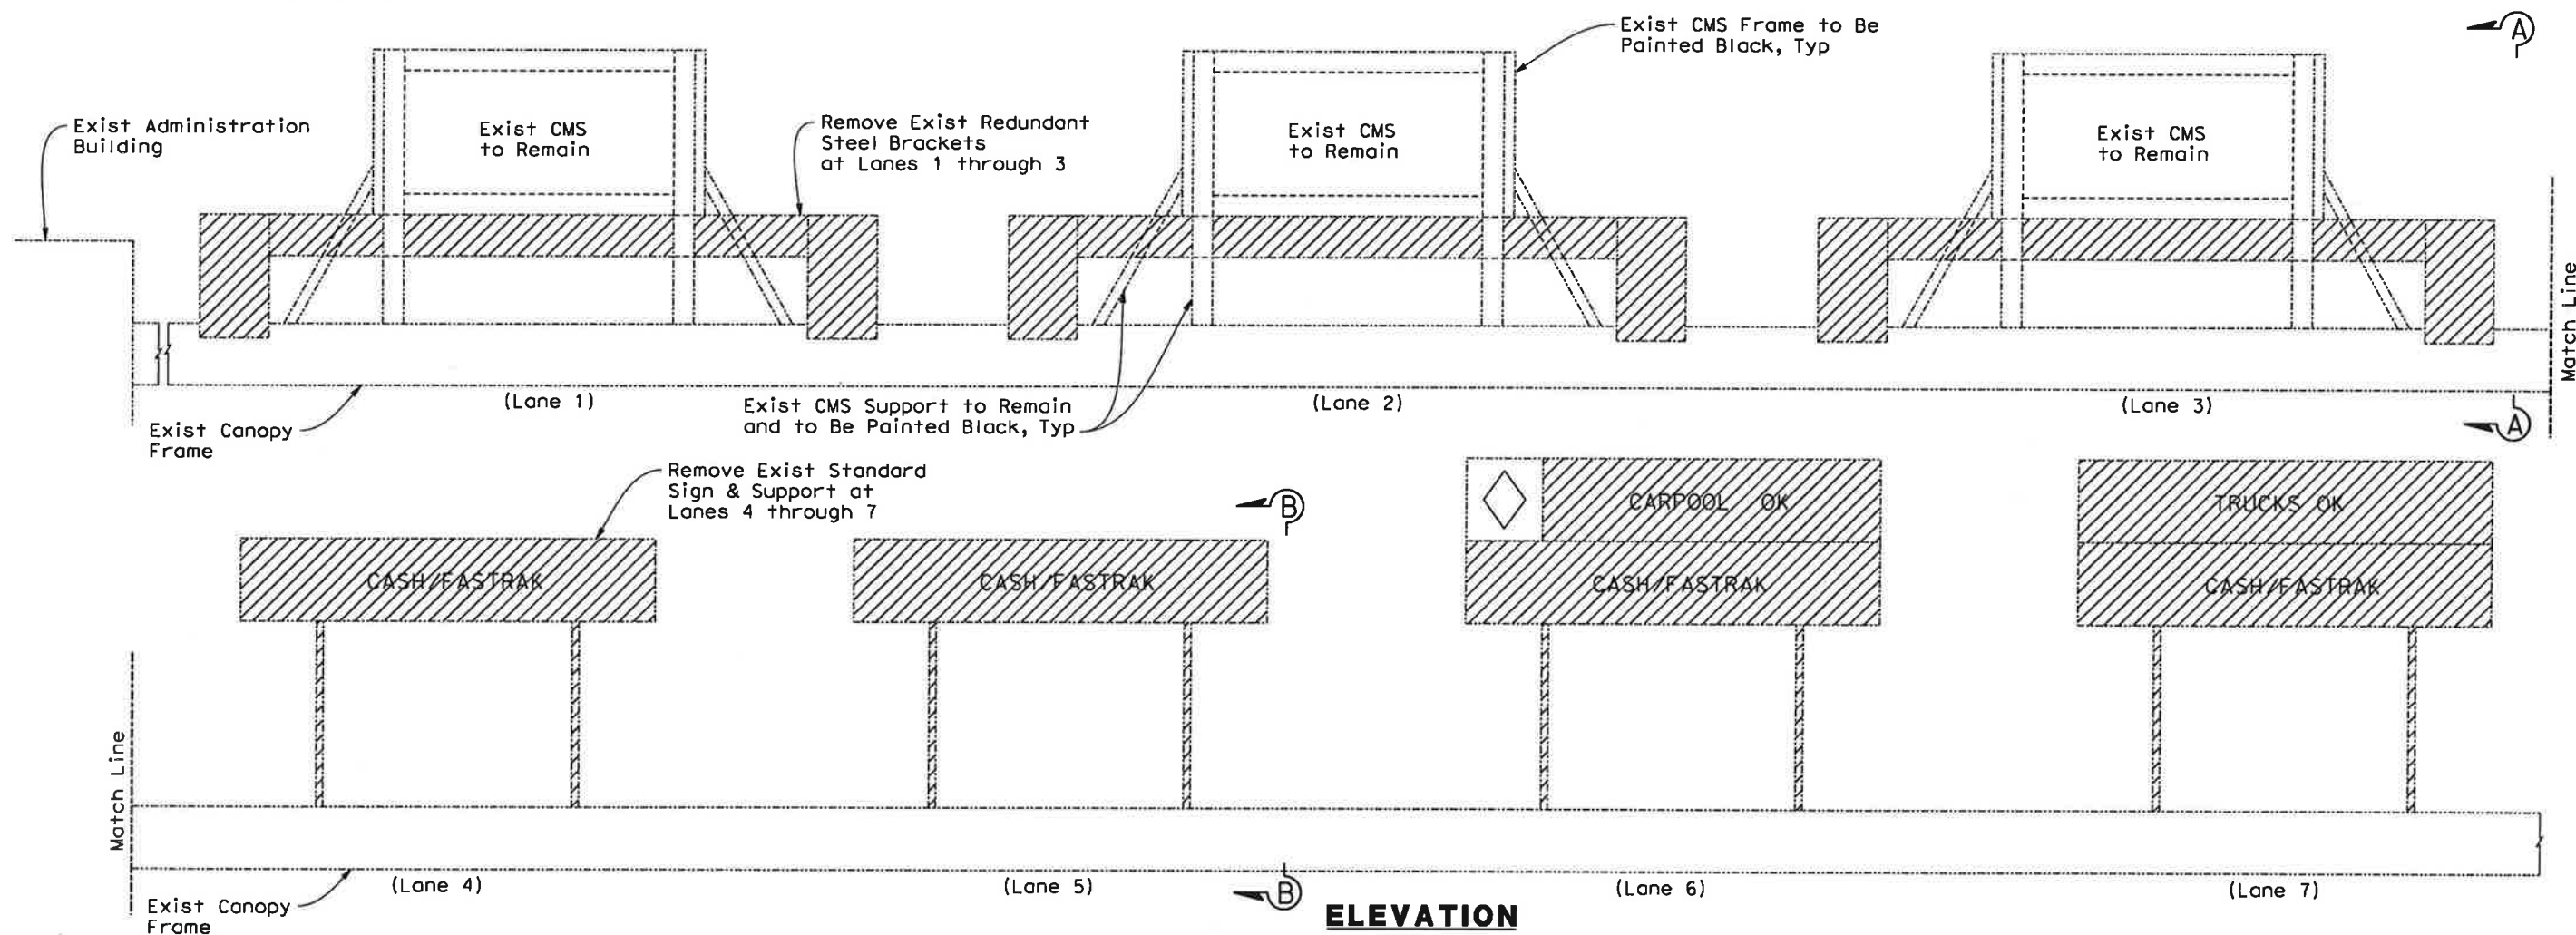

DESIGN OVERSIGHT	DESIGN	BY G. Xu	CHECKED	PREPARED FOR THE STATE OF CALIFORNIA DEPARTMENT OF TRANSPORTATION	Guoping Xu PROJECT ENGINEER	BRIDGE NO.	RICHMOND-SAN RAFAEL BRIDGE PLAZA										SHEET S-1					
	DETAILS	BY X. Sun	CHECKED			POST MILE	DEMOLITION OF EXISTING SIGN AND BRACKETS															
	SIGN OFF DATE	QUANTITIES	BY G. Xu			CHECKED	6.13															
DESIGN DETAIL SHEET (ENGLISH) (REV. 2/25/05)			ORIGINAL SCALE IN INCHES FOR REDUCED PLANS			CU EA			DISREGARD PRINTS BEARING EARLIER REVISION DATES → 03/12/10										REVISION DATES (PRELIMINARY STAGE ONLY)		SHEET	OF
																					1	3

DIST	COUNTY	ROUTE	POST MILES TOTAL PROJECT	SHEET NO	TOTAL SHEETS
04	CC	580	6.13	72	123

REGISTERED CIVIL ENGINEER

3/12/10

DATE

GUOPING XU

No. C 63977

EXP. 09/30/10


CIVIL

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101 EIGHT STREET  
OAKLAND, CALIFORNIA 94607


MGE ENGINEERING, INC.  
7415 GREENHAVEN DRIVE, SUITE 100  
SACRAMENTO, CALIFORNIA 95831



**TYPICAL CMS SUPPORT ELEVATION**

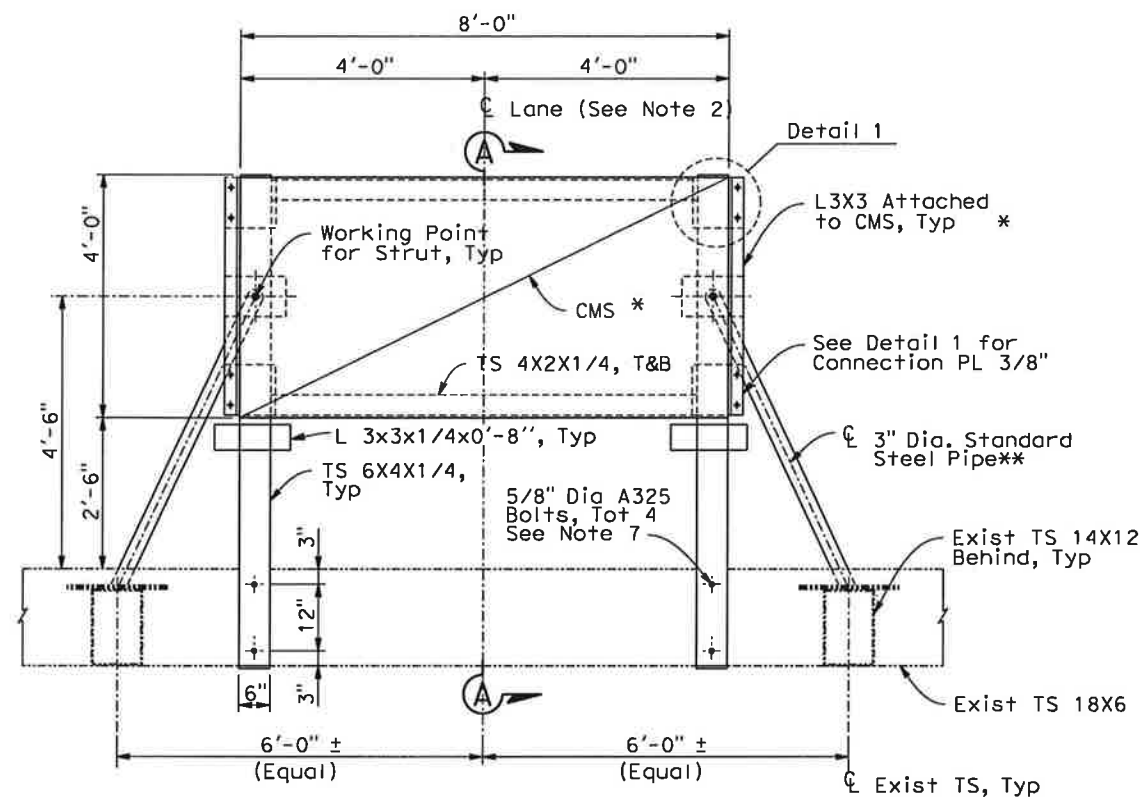SCALE: 3/4" = 1'-0"

\* (By CMS Manufacturer)  
\*\* (Materials furnished by the owner)

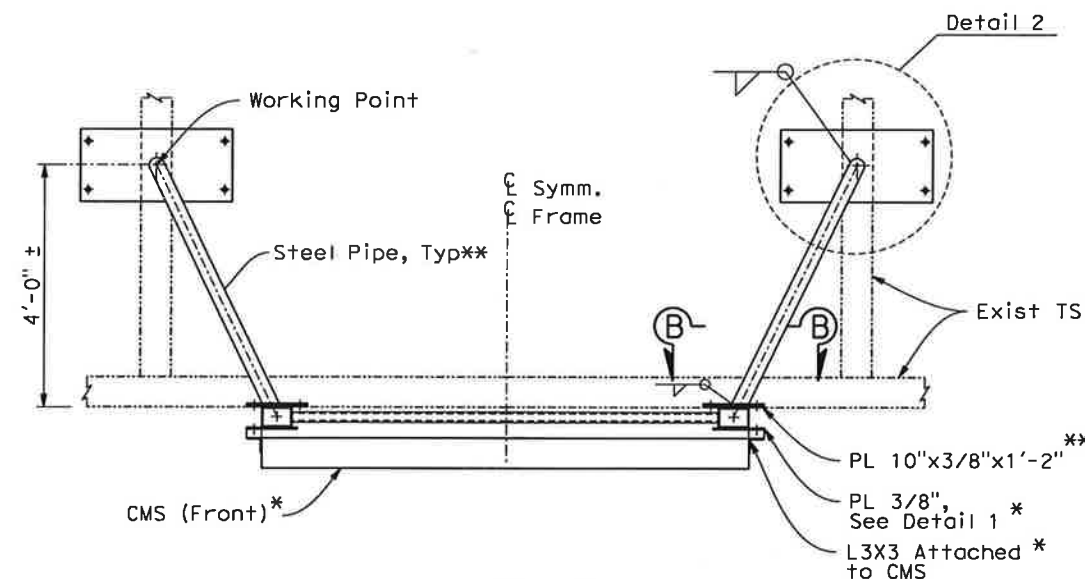

**PLAN**


SCALE: 3/4" = 1'-0"

(Roofing not Shown for Clarity, See Note 3)  
(Items noted (\*) are by others)

\* (By CMS Manufacturer)  
\*\* (Materials furnished by the owner)

**Notes:**

1. The Contractor shall verify controlling field dimension before ordering or fabricating any materials.
2. All support frame & hardware including CMS attachment angles shall be galvanized.
3. Partial removal of roofing will be necessary for access. Repair shall be carried out after installation of support frame.
4. All bolt connections shall be Dia 1/2" A325 unless noted otherwise.
5. For Details 1 & 2 and Sections A & B See "CMS support Details" Sheet.
6. Part of roof materials contain asbestos and due precaution and protective measures shall be taken by Contractor when removing portion of roof materials. Refer to special provisions for details.
7. The bolts through existing TS member shall be snug tight only and have locking system.
8. All bolts, washers and lock nuts shall be of stainless steel or galvanized.

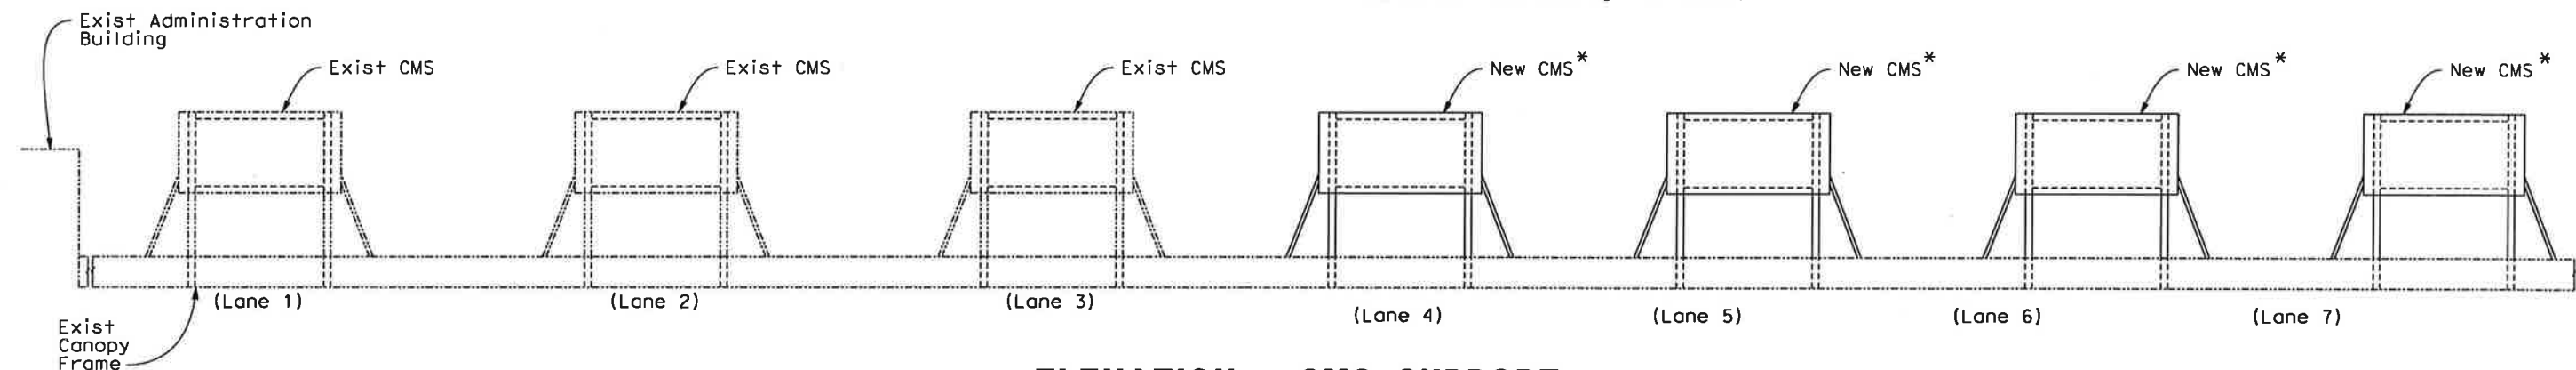

**ELEVATION - CMS SUPPORT**

NO SCALE

(\* By CMS Manufacturer)

Note:  
The Contractor shall verify all controlling field dimensions before ordering or fabricating any material.


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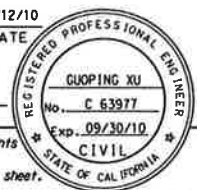
- Indicates Exist Structure  
————— Indicates New Structure

DESIGN OVERSIGHT	DESIGN BY G. Xu	CHECKED	PREPARED FOR THE STATE OF CALIFORNIA DEPARTMENT OF TRANSPORTATION	BRIDGE NO.	RICHMOND-SAN RAFAEL BRIDGE TOLL PLAZA		SHEET
SIGN OFF DATE	DETAILS BY X. Sun	CHECKED	Guoping Xu PROJECT ENGINEER	POST MILE	CMS SUPPORT FRAME		S-2
DESIGN DETAIL SHEET (ENGLISH) (REV. 2/25/05)	QUANTITIES BY G. Xu	CHECKED	CU EA	6.13	REVISION DATES (PRELIMINARY STAGE ONLY)		SHEET OF
ORIGINAL SCALE IN INCHES FOR REDUCED PLANS			0 1 2 3	DISREGARD PRINTS BEARING EARLIER REVISION DATES		03/12/10	2 3
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DIST	COUNTY	ROUTE	POST MILES TOTAL PROJECT	SHEET No	TOTAL SHEETS
04	CC	580	6.13	73	123

  
REGISTERED CIVIL ENGINEER  
DATE 3/12/10




PLANS APPROVAL DATE \_\_\_\_\_


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**BAY AREA TOLL AUTHORITY**  
101 EIGHT STREET  
OAKLAND, CALIFORNIA 94607

**MGE ENGINEERING, INC.**  
7415 GREENHAVEN DRIVE, SUITE 100  
SACRAMENTO, CALIFORNIA 95831

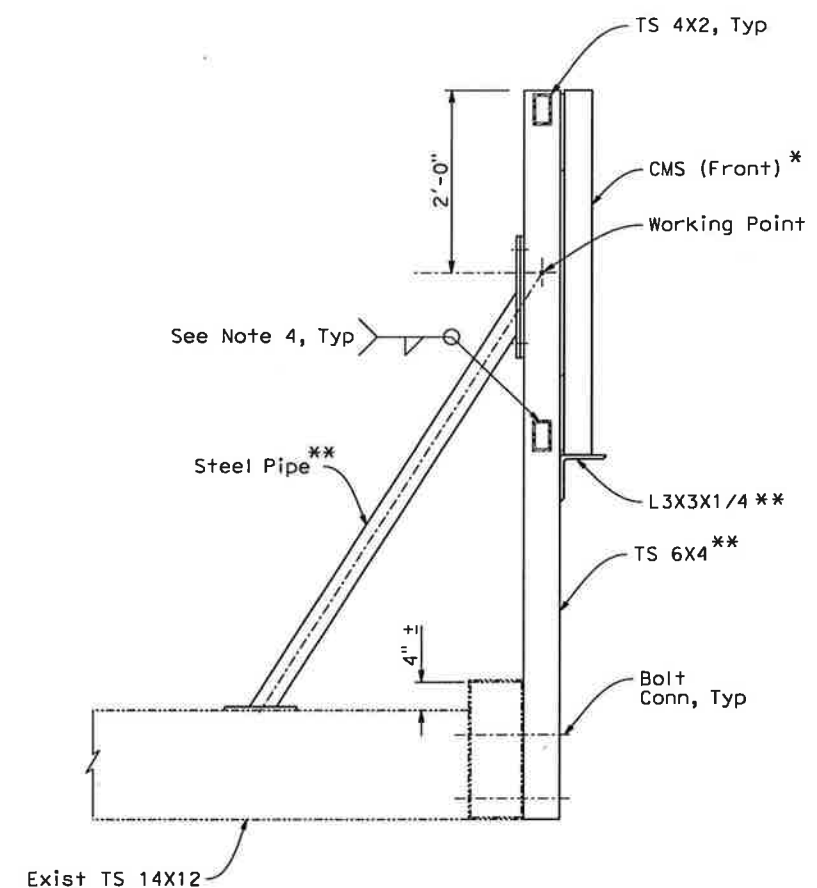


**SECTION A-A**  
SCALE: 1" = 1'-0"

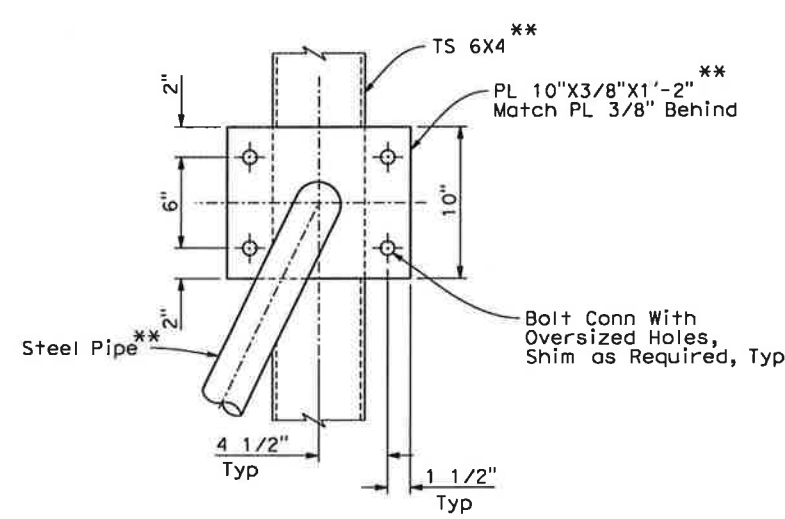


**SECTION B-B**  
SCALE: 1/2" = 1'-0"


Note:  
The Contractor shall verify all controlling field dimensions before ordering or fabricating any material.

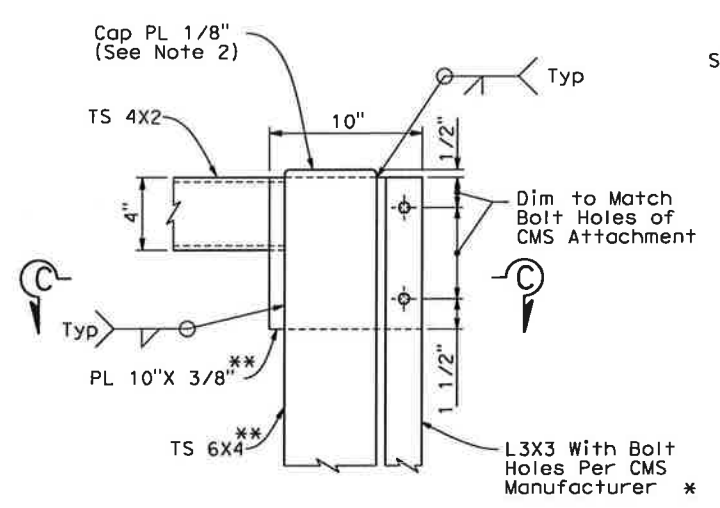


**DETAIL 1**  
SCALE: 1/2" = 1'-0"

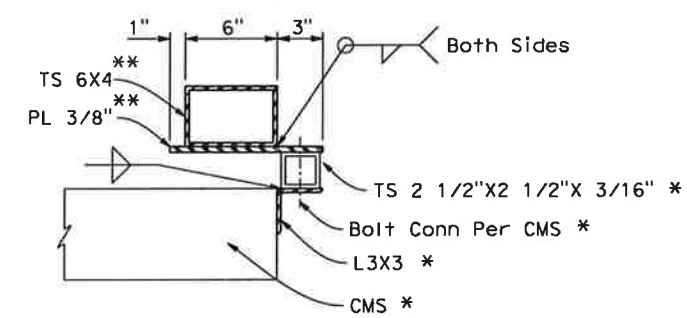

**SECTION C-C**  
SCALE: 1/2" = 1'-0"

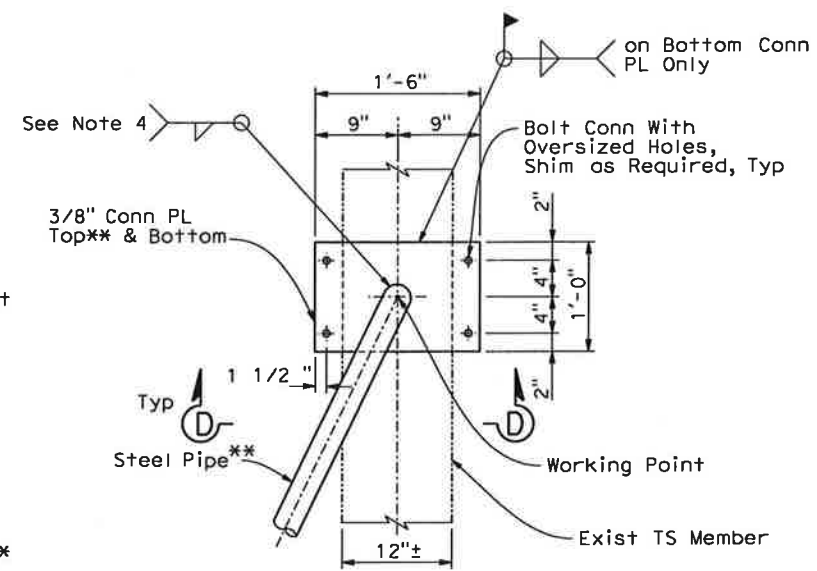

**DETAIL 2**  
SCALE: 1" = 1'-0"

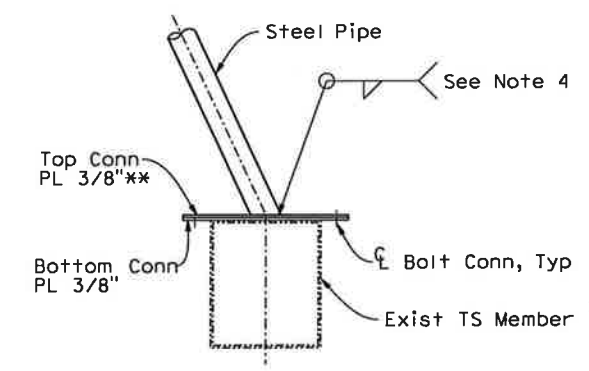

**SECTION D-D**  
SCALE: 1" = 1'-0"

- Notes:
1. The Contractor shall verify controlling field dimension before ordering or fabricating any materials.
  2. TS 6X4 shall have same cap plate at both top and bottom.
  3. Items noted (\*) are by CMS manufacturer. Materials noted (\*\*) are to be furnished by the Owner.
  4. The Contractor has the option of field welding the plates to the steel pipe.

DESIGN OVERSIGHT	DESIGN BY G. Xu	CHECKED	PREPARED FOR THE <b>STATE OF CALIFORNIA</b> DEPARTMENT OF TRANSPORTATION	BRIDGE NO. PROJECT ENGINEER	<b>RICHMOND SAN RAFAEL BRIDGE TOLL PLAZA</b>	SHEET <b>S-3</b>
SIGN OFF DATE	DETAILS BY X. Sun	CHECKED	QUANTITIES BY G. Xu	POST MILE 6.13	<b>CMS SUPPORT DETAILS</b>	
DESIGN DETAIL SHEET (ENGLISH) (REV. 2/25/05)	ORIGINAL SCALE IN INCHES FOR REDUCED PLANS			CU EA	DISREGARD PRINTS BEARING EARLIER REVISION DATES	SHEET OF 3 3
FILE => ... \Structural\ S-03.dgn				REVISION DATES (PRELIMINARY STAGE ONLY)		



STATE OF CALIFORNIA - DEPARTMENT OF TRANSPORTATION	CONSULTANT FUNCTIONAL SUPERVISOR	CALCULATED-DESIGNED BY	REVISED BY		
<b>Caltrans®</b>		CHECKED BY	DATE	REVISED	


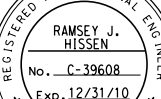
PROJECT NOTES:

1. INSTALL NEW CAT-5e CABLE IN EXISTING CONDUIT.
2. INSTALL NEW CAT-5e CABLE.
3. INSTALL NEW TYPE 1 (3/4") CONDUIT WITH 2 #12 AND 1 #14G (120 V, CMS CABINET).  
ROUTE CONDUIT BELOW (E) CABLE TRAY AND PROVIDE CONDUIT SUPPORT.
4. INSTALL ONE 15A, 1P, 120V CIRCUIT BREAKER FOR NEW CMS CABINET IN (E)SPACE #40.
5. INSTALL NEW FOUR(4)15A-IP CIRCUIT BREAKERS (120 V, CMS SIGN) IN  
(E) SPACES 8,10,11 AND 12).
6. INSTALL TYPE 1 (1 1/2") CONDUIT WITH 8 #12 AND 4 #12G (120 V, CMS SIGNS).
7. INSTALL TYPE 4 (1 1/2") CONDUIT WITH 8 #12 AND 4 #12G (120 V, CMS SIGNS).  
ROUTE CONDUIT IN (E) CABLE TRAY AND (E) CEILING TO (E) EMERGENCY PANEL.
8. ROUTE CONDUIT WITH 8 #12 AND 4 #12G TO (E) CANOPY (CORE DRILL IS REQUIRED).  
SEAL AROUND CONDUIT PENETRATION WITH FAST-SETTING EPOXY RESIN THROUGH THE DEPTH OF HOLE.
9. INSTALL TYPE 1 (1 1/2") CONDUIT WITH 8 #12 AND 4 #12G (120 V, CMS SIGNS) AND  
ROUTE ABOVE CEILING TILE.
10. ALL WALL, CEILING AND FLOOR PENETRATIONS SHALL BE CORE-DRILLED AS DIRECTED  
AND APPROVED BY CALTRANS SUFFICIENTLY LARGE TO ACCOMMODATE CONDUIT PLUS FLUSH  
MOUNTED END BELL. ALL CORE-DRILLS SHALL BE MADE WATER-TIGHT, SEALED AROUND  
CONDUIT PER CALTRANS REQUIREMENTS WITH FAST-SETTING EPOXY RESIN THROUGHOUT  
THE DEPTH OF HOLE.
11. INSTALL NEW INDICATOR LIGHT CANOPY CABLE.
12. INSTALL NEW INDICATOR LIGHT BOOTH CABLE.
13. INSTALL NEW INDICATOR LIGHT CONSOLE CABLE.
14. INSTALL NEW CMS COMM CABLE.
15. (E) 1 1/4" C - 6 #12 & 4 #12G (120V, (E) CMS SIGNS)
16. INSTALL NEW EQUIPMENT RACK MOUNTABLE SHELF.
17. INSTALL NEW TYPE 4 (1 1/2" C) CONDUIT.
18. CONTRACTOR TO RE-SEAL CONDUIT PENETRATION UP TO CANOPY.
19. (E) FDU TO REMAIN.
20. REMOVE AND DISPOSE OF EXISTING INDICATOR LIGHT CONTROL CABLE.
21. REMOVE AND DISPOSE OF EXISTING SPARE GREEN, BLACK, & WHITE CABLES.
22. INSTALL NEW 8 #12 & 8 #12G (120V, CMS SIGNS).
23. ROUTE NEW CABLES THROUGH EXISTING CONDUIT.
24. MODIFY EXISTING GREEN INDICATOR LIGHT AND REPLACE WITH GREEN/FLASHING AMBER  
LED INDICATOR BULB. REPLACE EXISTING RED INDICATOR LIGHT WITH RED LED INDICATOR  
BULB. IF EXISTING RED INDICATOR LIGHT IS LED, FURNISH NEW RED LED INDICATOR BULB  
TO BATA AS A SPARE.
25. INSTALL NEW TYPE 2 (1 1/2" C) CONDUIT.

- 26 REMOVE AND DISPOSE OF AS DIRECTED BY THE ENGINEER.
- 27 ROUTE NEW CMS COMM CABLE THROUGH EXISTING JUNCTION BOX.
- 28 INSTALL NEW TYPE 3 EQUIPMENT RACK FOR LANES 4-7. SEE SHEET E-9 AND SPECIFICATIONS FOR SIZE AND TYPE.
- 29 INSTALL INDICATOR LIGHT SWITCH CONSOLE PANEL.
- 30 REMOVE EXISTING INDICATOR LIGHT SWITCH PANEL IN TOLL BOOTH.
- 31 INSTALL NEW CMS CONTROLLERS. ROUTE CAT-5E PATCH CABLES FROM EACH CMS CONTROLLER TO NEW ETHERNET SWITCH IN EXISTING CMS CABINET.
- 32 INSTALL NEW TYPE 1 (2" C) CONDUIT.
- 33 INSTALL NEW TYPE 2 (2" C) CONDUIT.
- 34 INSTALL TYPE 1 JUNCTION BOX AS SPECIFIED IN CONTRACT DOCUMENTS.
- 35 INSTALL NEW TYPE 1 (1½" C) CONDUIT.
- 36 INSTALL NEW 4X4X4 JUNCTION BOX
- 37 INSTALL NEW RACK MOUNTABLE IP ADDRESSABLE POWER STRIP TO BE CONNECTED TO ETHERNET SWITCH.
- 38 INSTALL NEW TYPE 4 (2" C) CONDUIT
- 39 INSTALL AND TERMINATE INDICATOR LIGHT CABLES TO NEW TERMINAL BLOCKS AND WIRE TO SWITCH PANEL AS SHOWN IN PLANS AND APPROVED BY THE ENGINEER.
- 40 INSTALL L TYPE FITTING.
- 41 INSTALL NEW TOLL BOOTH LED PUSH BUTTON INDICATOR BOX.
- 42 INSTALL TYPE 2 (1½" C) CONDUIT WITH 8 #12 & 4 #12G (120V, CMS POWER).
- 43 INSTALL NEW TYPE 4 (1" C) CONDUIT.
- 44 INSTALL TYPE 3 JUNCTION BOX AS SPECIFIED IN CONTRACT DOCUMENTS.
- 45 INSTALL NEW CMS PANEL AS SPECIFIED IN CONTRACT DOCUMENTS.
- 46 INSTALL NEW 15A-1P CIRCUIT BREAKER (120V, CMS CONTROLLER) IN SPACE #42 TO MATCH (E).
- 47 PROVIDE NEW REVISED (TYPED WRITTEN) PANEL SCHEDULE.
- 48 INTERCEPT (E) CONDUIT (120V, CMS CONTROLLER) AND EXTEND TO (E) PANEL-PB. PROVIDE NEW 2 #14 & 1 #14G BETWEEN CONTROLLER AND PANEL-PB.
- 49 DISCONNECT AND SCRAP (E) BRANCH CIRCUIT FEEDER #14 (120V, CMS CONTROLLER).
- 50 INSTALL NEW TYPE 1 (¾" C) CONDUIT WITH 2 #14 & 1 #14G.
- 51 (E) 2 #14 & 1 #14G TO EMERGENCY PANEL.
- 52 REPLACE EXISTING RED INDICATOR LIGHT WITH NEW RED LED INDICATOR BULB. IF EXISTING RED INDICATOR LIGHT IS LED, FURNISH NEW RED LED INDICATOR BULB TO BATA AS A SPARE.

Dist	COUNTY	ROUTE	POST MILES TOTAL PROJECT	SHEET TOTAL SHEETS
04	CC	580	6.13	75 123

 REGISTERED CIVIL ENGINEER	3/12/10 DATE	
PLANS APPROVAL DATE _____		

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
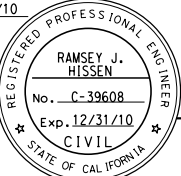
**PROJECT NOTES**  
**(RICHMOND - SAN RAFAEL)**  
**E-2**

SHEET	OF	LAST REVISION
2	17	



Dist	COUNTY	ROUTE	POST MILES TOTAL PROJECT	SHEET TOTAL SHEETS
04	CC	580	6.13	76 123



 REGISTERED CIVIL ENGINEER	3/12/10 DATE	
PLANS APPROVAL DATE		
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SHEET NOTES:

- ① ANY EXISTING FURNITURE REQUIRED TO TO BE RE-ARRANGED FOR PLACEMENT OF INDICATOR LIGHT SWITCH CONSOLE PANEL SHALL BE COORDINATED WITH TOLL SERGEANT.
- ② INDICATOR LIGHT SWITCH CONSOLE PANEL TO BE MOUNTED VERTICALLY TO EXISTING COLUMN.
- ③ CONTRACTOR TO ROUTE ALL CABLES TO INDICATOR LIGHT SWITCH CONSOLE PANEL. SECURE CONDUIT TO WALL WITH FITTINGS AND FASTENERS.




MAIN FLOOR - PARTIAL FLOOR PLAN VIEW

**TOLL PLAZA OPERATIONS BUILDING  
PARTIAL MAIN FLOOR PLAN  
CONDUIT ROUTING  
(RICHMOND - SAN RAFAEL)**

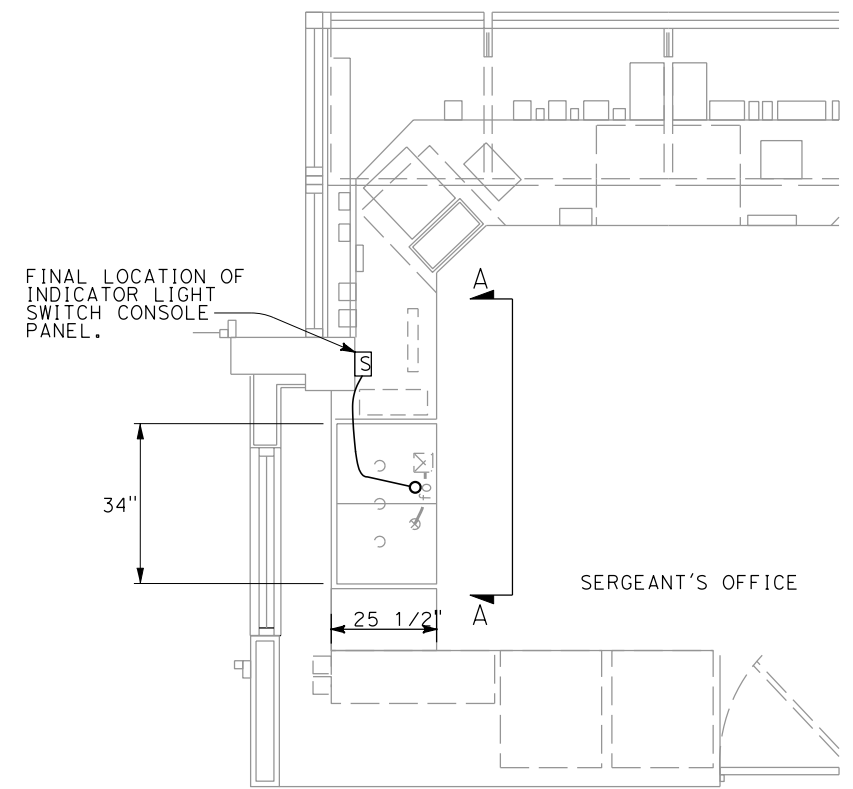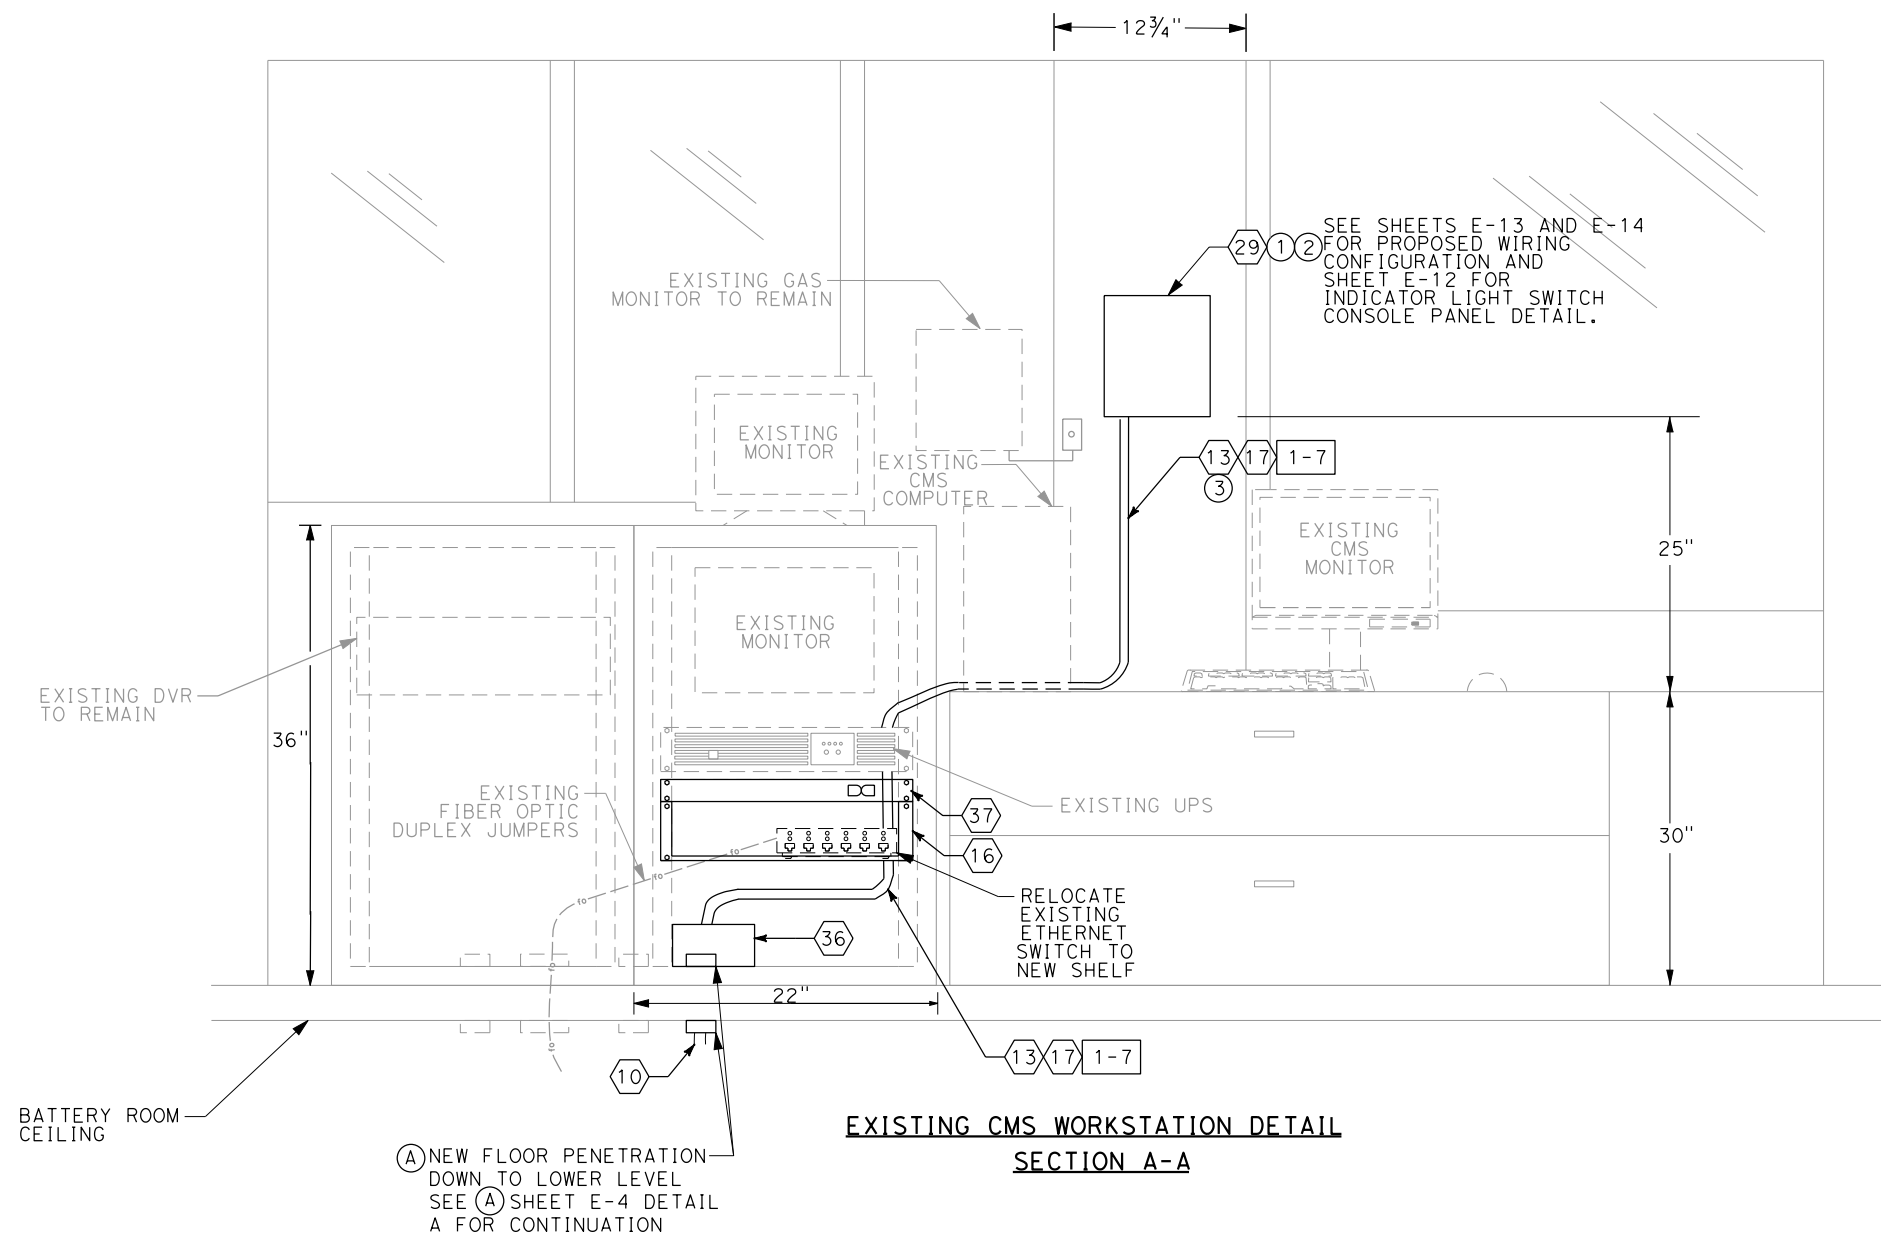NO SCALE

E - 3

SHEET	OF
3	17

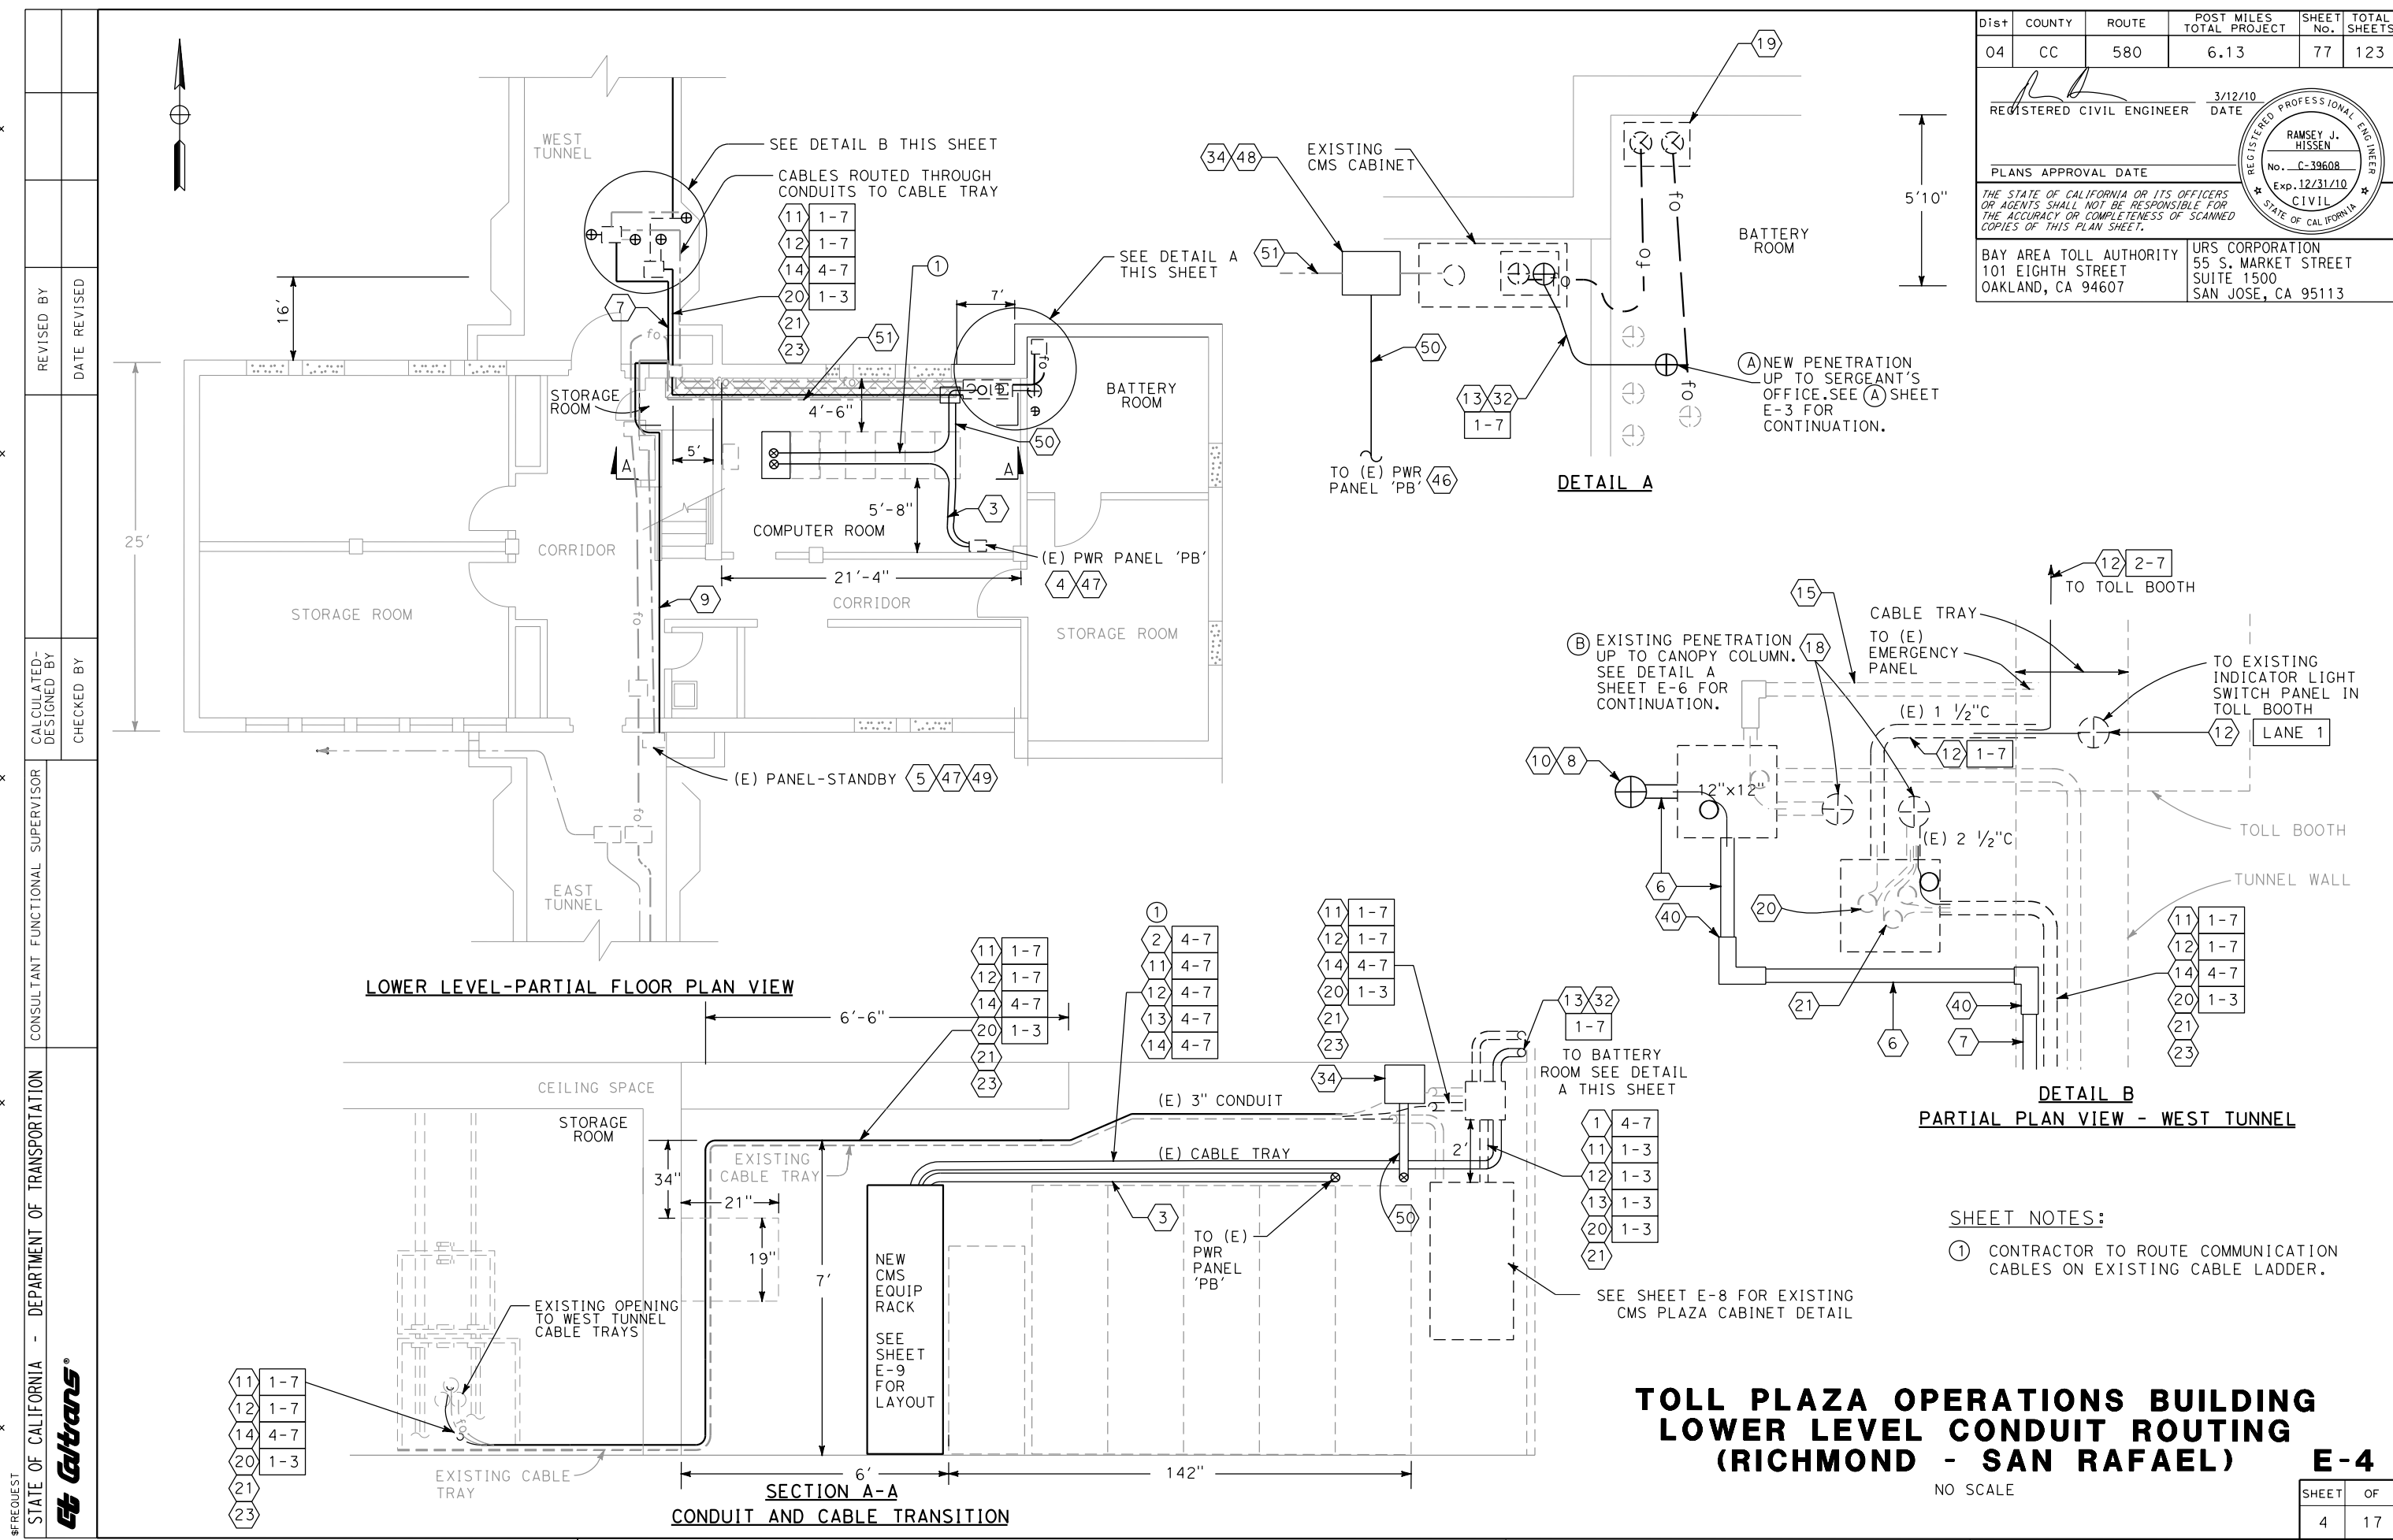

DIST	COUNTY	ROUTE	POST MILES TOTAL PROJECT	SHEET NO.	TOTAL SHEETS
04	CC	580	6.13	77	123

REGISTERED CIVIL ENGINEER  
DATE 3/12/10

PLANS APPROVAL DATE

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URS CORPORATION  
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SUITE 1500  
SAN JOSE, CA 95113

REGISTERED PROFESSIONAL ENGINEER  
No. C-39608  
Exp. 12/31/10  
CIVIL  
STATE OF CALIFORNIA

**SHEET NOTES:**

① CONTRACTOR TO ROUTE COMMUNICATION CABLES ON EXISTING CABLE LADDER.


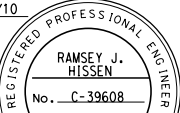
**TOLL PLAZA OPERATIONS BUILDING  
LOWER LEVEL CONDUIT ROUTING  
(RICHMOND - SAN RAFAEL)**


**E-4**

NO SCALE

SHEET	OF
4	17



Dist	COUNTY	ROUTE	POST MILES TOTAL PROJECT	SHEET No.	TOTAL SHEETS
04	CC	580	6.13	79	123
 REGISTERED CIVIL ENGINEER			3/12/10 DATE		
PLANS APPROVAL DATE _____					
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- ## NOTES
- ① CONTRACTOR TO ROUTE NEW INDICATOR LIGHT CANOPY CABLE DOWN TO COMPUTER ROOM. SEE SHEETS E-13 AND E-14 FOR PROPOSED WIRING CONFIGURATION.
  - ② CONTRACTOR TO RE-SEAL CONDUIT PENETRATION DOWN TO TUNNEL.
  - ③ CONTRACTOR TO PROVIDE CONDUIT SUPPORT.
  - ④ FINAL LOCATION OF CONDUIT AND JUNCTION BOX ROUTING AND ATTACHMENT DETAILS SHALL BE COORDINATED BY THE CONTRACTOR WITH THE ENGINEER PRIOR TO INSTALLATION.
  - ⑤ EXISTING GREEN, BLACK, & WHITE CABLES TO BE REMOVED.
  - ⑥ ROUTE CONDUIT UP THE SIDE OF THE COLUMN ALONG WITH EXISTING CONDUIT.
  - ⑦ INTERCEPT EXISTING CONDUIT, CUT FLUSH AND INSTALL NEW JUNCTION BOX AND TERMINATE CONDUIT IN JUNCTION BOX.
  - ⑧ INSTALL TYPE 4 (1") CONDUIT WITH 2 #12 & 1 #12G (120V, CMS POWER)
  - ⑨ INSTALL TYPE 1 JUNCTION BOX, SEE SHEET E-15 FOR DETAILS.
  - ⑩ INSTALL TYPE 2 (1½" C) CONDUIT WITH 6 #12 & 3 #12G (120V, CMS POWER)
  - ⑪ INSTALL TYPE 2 (1½" C) CONDUIT WITH 4 #12 & 2 #12G (120V, CMS POWER)

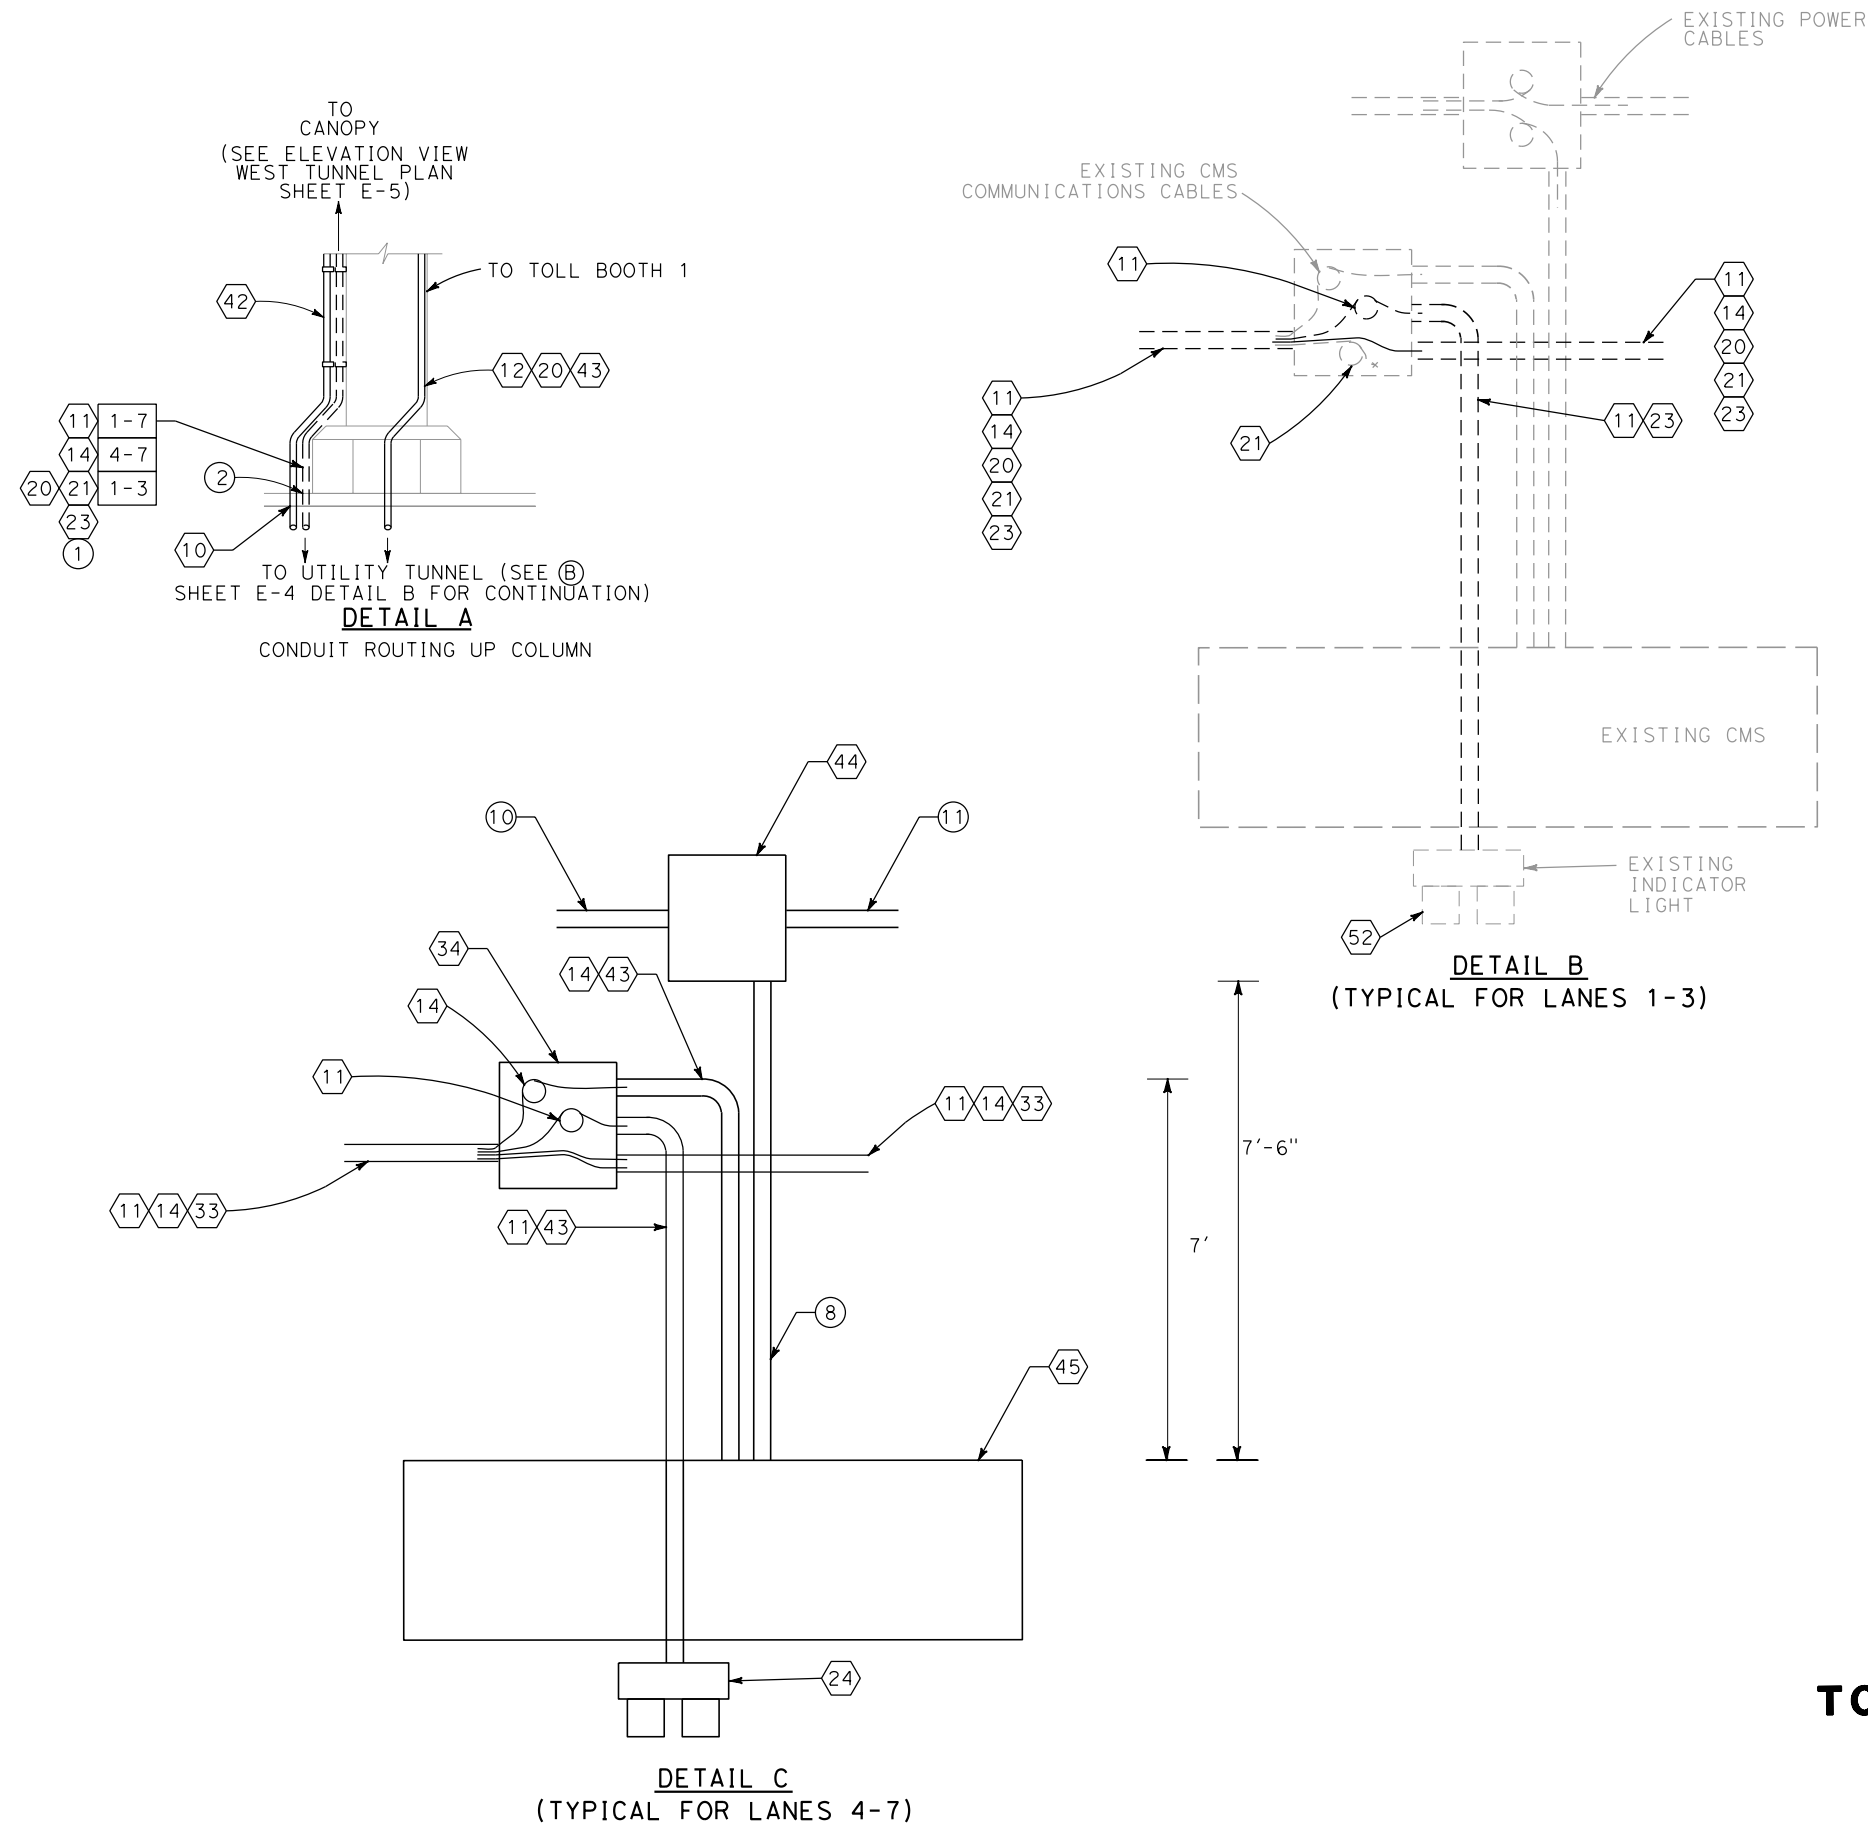x

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x

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x

\$REQUEST

STATE OF CALIFORNIA - DEPARTMENT OF TRANSPORTATION




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REVISED BY

DATE REVISED



- NOTES:
1. EXISTING GARRETTCOM ETHERNET SWITCH LOCATED IN EXISTING CMS CABINET (LANES 1-3) SHALL BE RETURNED TO BATA AND REPLACED WITH NEW RACK MOUNTABLE SWITCH WITH MINIMUM 14-10/100 BASE-TX AND 2-100BASE-FX PORTS. FIBER PORTS TO MATCH EXISTING.
  2. EXISTING CMS CONTROLLERS LOCATED IN EXISTING CMS CABINET (LANES 1-3) SHALL BE REPLACED WITH NEW CMS CONTROLLERS TO BE PROVIDED WITH INTERNAL SURGE PROTECTION PER MANUFACTURER'S SPECS.
  3. EXISTING CMS TVSS TO BE REMOVED. OLD TVSS SHALL BE RETURNED TO BATA.
  4. REPLACE EXISTING POWER STRIP WITH NEW RACK MOUNTABLE IP ADDRESSABLE POWER STRIP.
  5. DO NOT CONNECT POWER STRIP TO GFI. CONNECT TO CABINET POWER SOURCE DIRECTLY BY MEANS OF A SEPARATE NEMA 5-15 SOCKET.

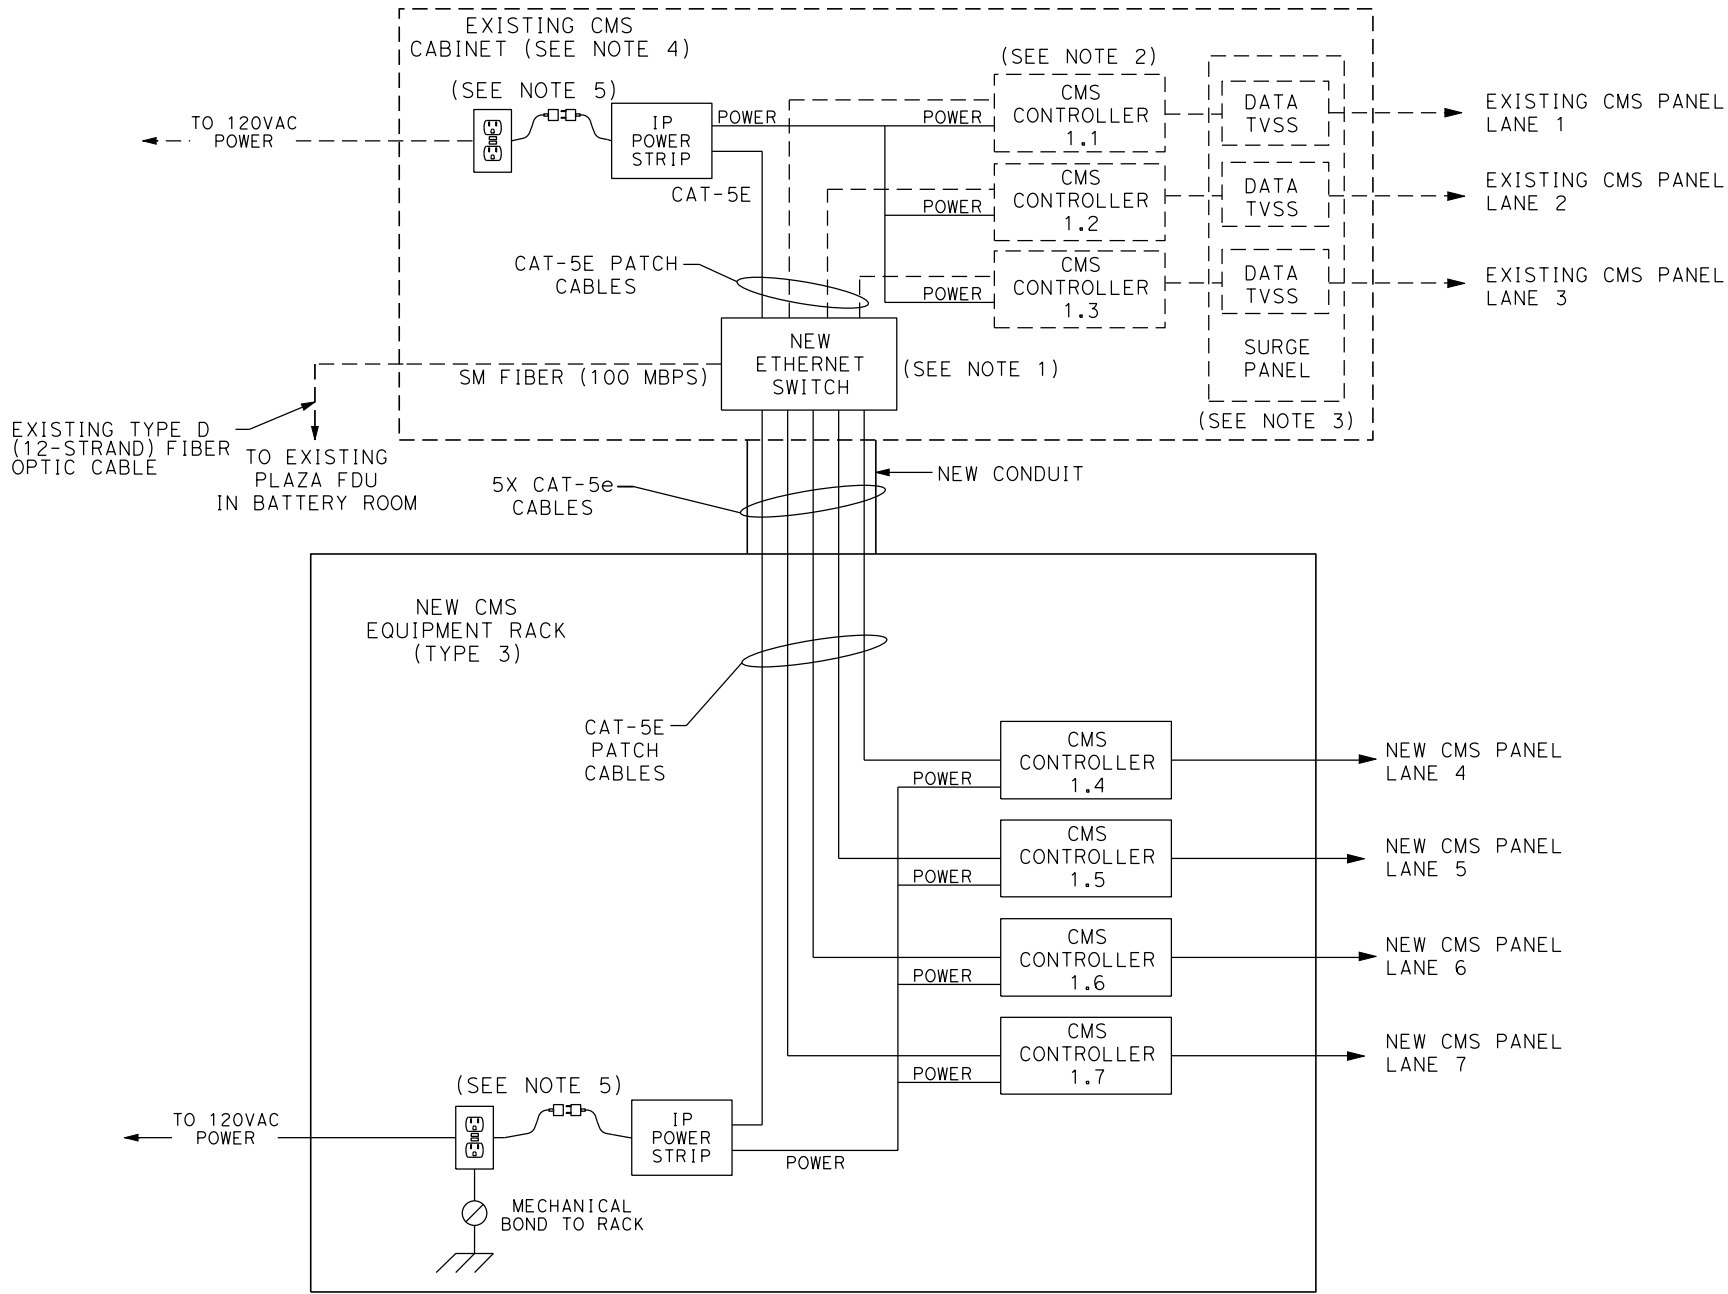CMS SYSTEM SCHEMATIC  
(RICHMOND-SAN RAFAEL)

NO SCALE

E-7

SHEET	OF
7	17

Dist	COUNTY	ROUTE	POST MILES TOTAL PROJECT	SHEET No.	TOTAL SHEETS
04	CC	580	6.13	80	123

REGISTERED CIVIL ENGINEER

3/12/10  
DATE

PLANS APPROVAL DATE

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101 EIGHTH STREET  
OAKLAND, CA 94607

URS CORPORATION  
55 S. MARKET STREET  
SUITE 1500  
SAN JOSE, CA 95113

REGISTERED PROFESSIONAL ENGINEER

RAMSEY J. HISSON


No. C-39608

Exp. 12/31/10

CIVIL

STATE OF CALIFORNIA



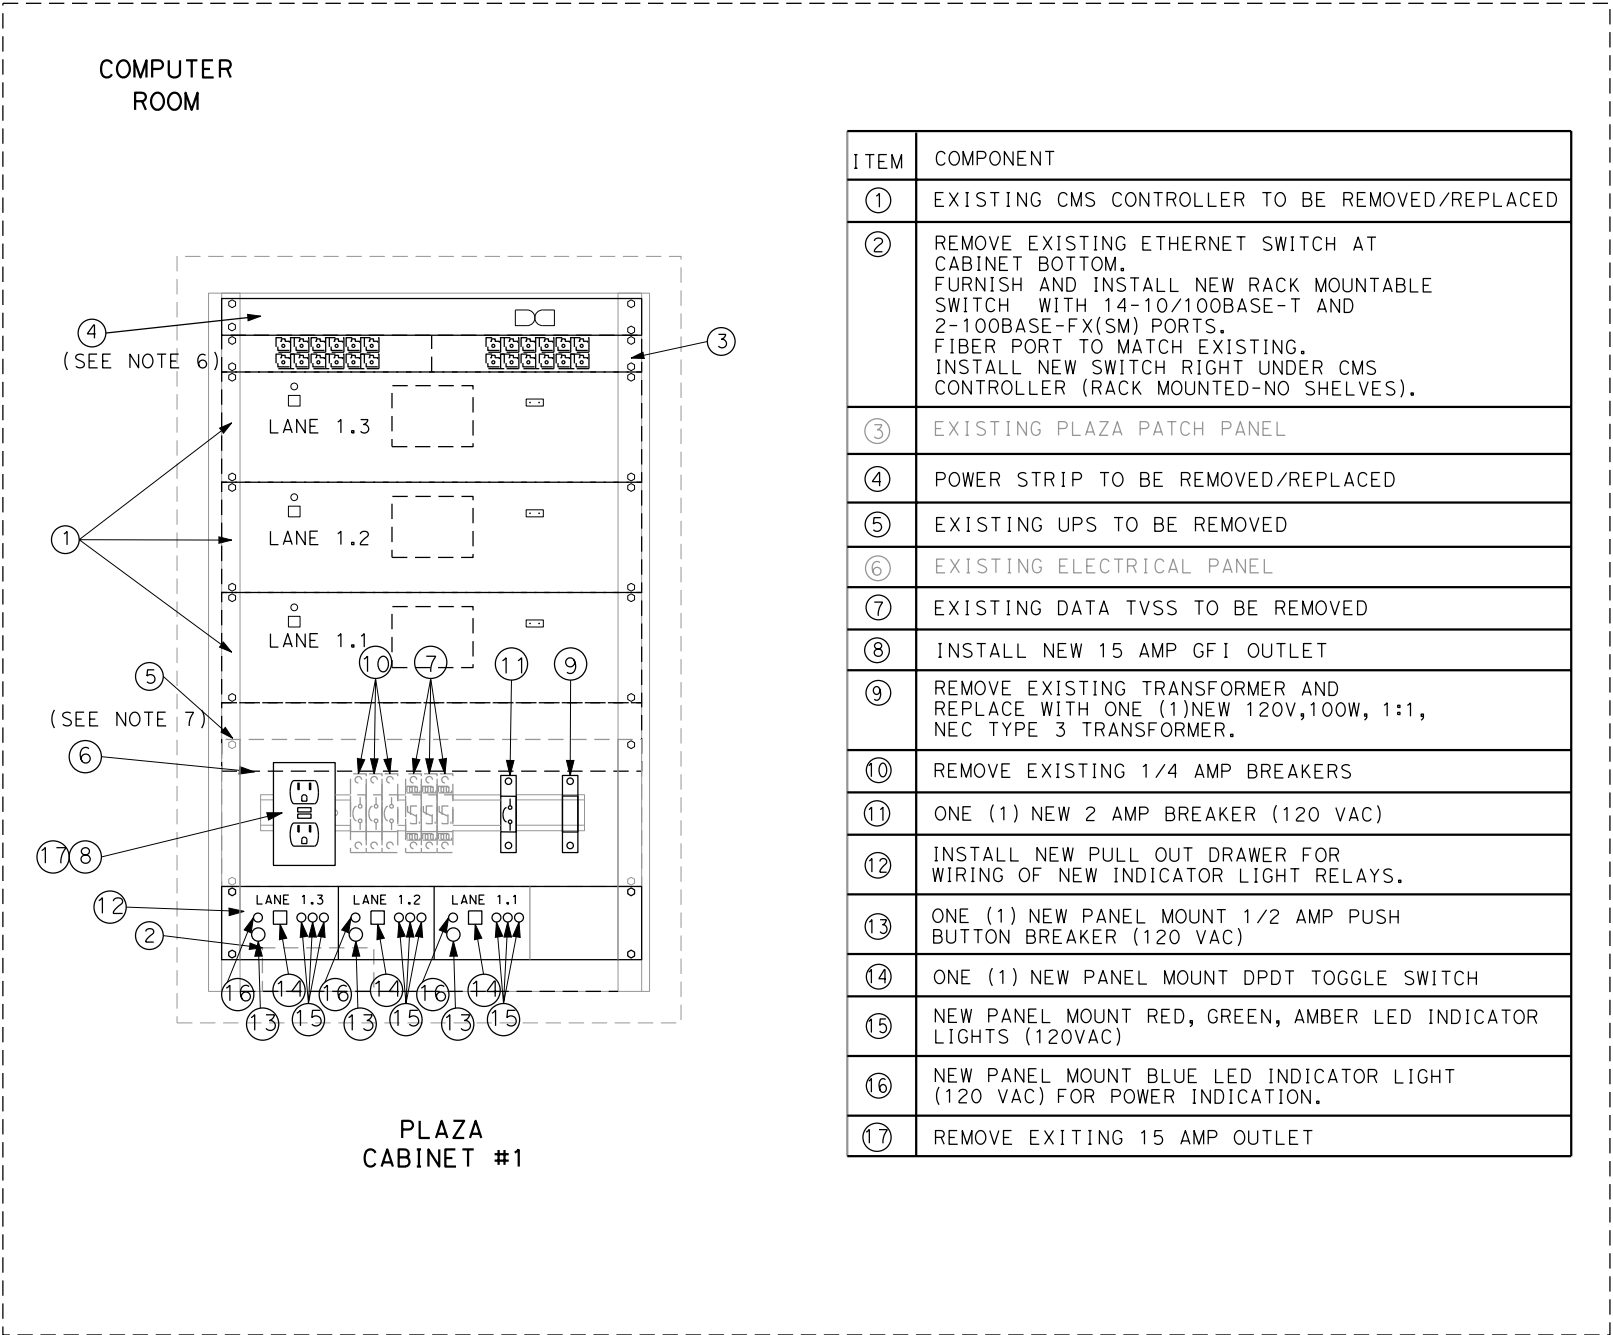

DETAIL A  
EXISTING TOLL PLAZA CABINET ELEVATION

ITEM	COMPONENT
①	EXISTING CMS CONTROLLER TO BE REMOVED/REPLACED
②	REMOVE EXISTING ETHERNET SWITCH AT CABINET BOTTOM. FURNISH AND INSTALL NEW RACK MOUNTABLE SWITCH WITH 14-10/100BASE-T AND 2-100BASE-FX(SM) PORTS. FIBER PORT TO MATCH EXISTING. INSTALL NEW SWITCH RIGHT UNDER CMS CONTROLLER (RACK MOUNTED-NO SHELVES).
③	EXISTING PLAZA PATCH PANEL
④	POWER STRIP TO BE REMOVED/REPLACED
⑤	EXISTING UPS TO BE REMOVED
⑥	EXISTING ELECTRICAL PANEL
⑦	EXISTING DATA TVSS TO BE REMOVED
⑧	INSTALL NEW 15 AMP GFI OUTLET
⑨	REMOVE EXISTING TRANSFORMER AND REPLACE WITH ONE (1)NEW 120V,100W, 1:1, NEC TYPE 3 TRANSFORMER.
⑩	REMOVE EXISTING 1/4 AMP BREAKERS
⑪	ONE (1) NEW 2 AMP BREAKER (120 VAC)
⑫	INSTALL NEW PULL OUT DRAWER FOR WIRING OF NEW INDICATOR LIGHT RELAYS.
⑬	ONE (1) NEW PANEL MOUNT 1/2 AMP PUSH BUTTON BREAKER (120 VAC)
⑭	ONE (1) NEW PANEL MOUNT DPDT TOGGLE SWITCH
⑮	NEW PANEL MOUNT RED, GREEN, AMBER LED INDICATOR LIGHTS (120VAC)
⑯	NEW PANEL MOUNT BLUE LED INDICATOR LIGHT (120 VAC) FOR POWER INDICATION.
⑰	REMOVE EXITING 15 AMP OUTLET

DIST	COUNTY	ROUTE	POST MILES TOTAL PROJECT	SHEET NO.	TOTAL SHEETS
04	CC	580	6.13	81	123

REGISTERED CIVIL ENGINEER

3/12/10

DATE

PLANS APPROVAL DATE

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BAY AREA TOLL AUTHORITY

101 EIGHTH STREET

OAKLAND, CA 94607

URS CORPORATION

55 S. MARKET STREET

SUITE 1500

SAN JOSE, CA 95113

REGISTERED PROFESSIONAL ENGINEER

RAMSEY J. HISSEN

No. C-39608

Exp. 12/31/10

CIVIL

STATE OF CALIFORNIA

- NOTES:
- EQUIPMENT TO MEET CALTRANS TEES REQUIREMENTS.
  - ALL REMOVED EQUIPMENT AND MATERIALS SHALL BE COORDINATED WITH BATA.
  - CONTRACTOR TO REMOVE EXISTING TYPE 3 TRANSFORMER FROM PLAZA CABINETS.
  - CONTRACTOR TO REMOVE EXISTING 1/4 AMP BREAKERS.
  - EXISTING CMS TVSS TO BE REMOVED AND SALVAGE. CONTROLLER TO BE PROVIDED WITH INTERNAL SURGE PROTECTION PER MANUFACTURER'S SPECS.
  - EXISTING POWER STRIP TO BE REPLACED WITH NEW IP ADDRESSABLE RACK MOUNTABLE POWER STRIP. CONTRACTOR TO CONNECT ETHERNET CABLE TO NEW SWITCH.
  - EXISTING UPS TO BE REMOVED AND RETURNED TO BATA CONTRACTOR TO CONNECT CMS CONTROLLERS TO PANEL 'PB' UPS POWER.
  - ALL CABLING IN CMS CABINETS SHALL BE INSTALLED AND NEATLY DRESSED AND SECURED IN CABINETS. SPARE COILED CABLING SHALL BE PROVIDED IN JUNCTION BOXES.
  - CONTRACTOR TO INSTALL, CONNECT, AND INTEGRATE ALL EQUIPMENT IN CMS CABINETS (I.E., TRANSFORMERS, BREAKERS, ETC.).
  - EXISTING CMS CONTROLLER TO BE REPLACED WITH NEW CONTROLLER. NEW CMS CONTROLLER TO BE PROVIDED BY BATA.
  - CONTRACTOR TO LEAVE ONE (1) RACK UNIT OF SPACE AT BOTTOM OF CABINET.
  - DO NOT CONNECT POWER STRIP TO GFI. CONNECT TO CABINET POWER SOURCE DIRECTLY BY MEANS OF A SEPARATE NEMA 5-15 SOCKET.

CMS PLAZA CABINET ELEVATION VIEW  
FOR LANES 1-3  
(RICHMOND-SAN RAFAEL) E-8  
NO SCALE

SHEET	OF
8	17

x

x

x

x

x

\$REQUEST

STATE OF CALIFORNIA - DEPARTMENT OF TRANSPORTATION

Caltrans

CONSULTANT FUNCTIONAL SUPERVISOR

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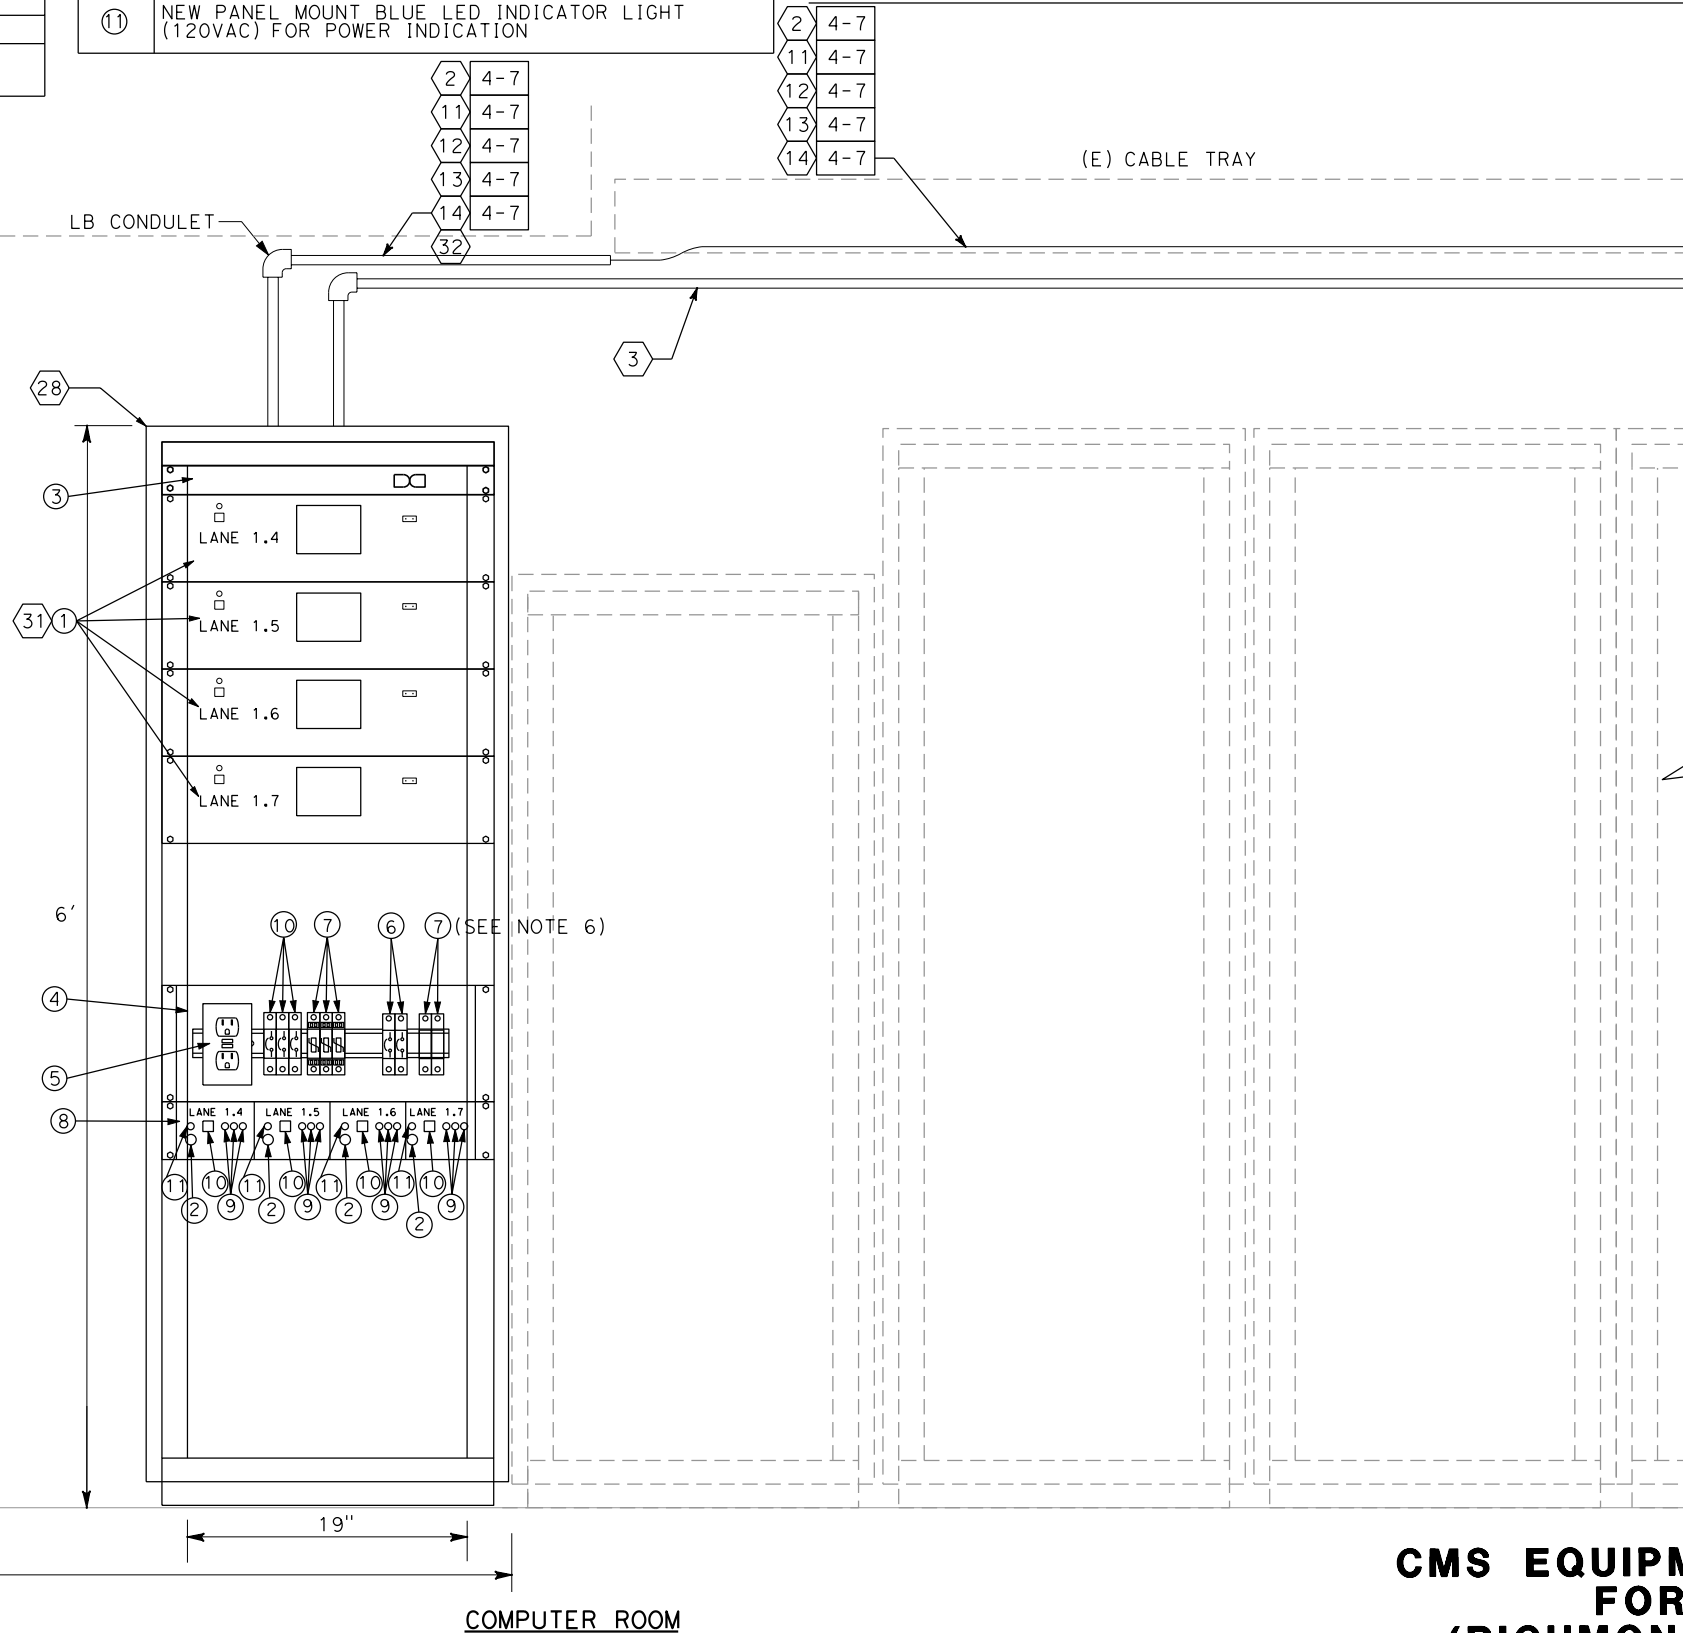
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DATE REVISED

ITEM	COMPONENT
①	NEW CMS CONTROLLER
②	ONE (1) NEW PANEL MOUNT 1/2 AMP PUSH BUTTON BREAKER (120 VAC)
③	NEW IP ADDRESSABLE POWER STRIP
④	NEW ELECTRICAL PANEL
⑤	NEW 15 AMP GFI OUTLET
⑥	TWO (2) NEW 2 AMP BREAKER (120 VAC)
⑦	TWO (2) NEW CLASS 3, 100 WATT 1:1, 120 VAC TRANSFORMERS

NOTE: CABINET AND EQUIPMENT TO MEET CALTRANS TEES REQUIREMENTS

ITEM	COMPONENT
⑧	INSTALL NEW PULL OUT DRAWER FOR WIRING OF NEW INDICATOR LIGHT RELAYS. SEE SHEET E-17 FOR CABINET DRAWER LAYOUT.
⑨	NEW PANEL MOUNT RED, GREEN, AMBER LED INDICATOR LIGHTS (120VAC)
⑩	ONE (1) NEW PANEL MOUNT DPDT TOGGLE SWITCH
⑪	NEW PANEL MOUNT BLUE LED INDICATOR LIGHT (120VAC) FOR POWER INDICATION



Dist	COUNTY	ROUTE	POST MILES TOTAL PROJECT	SHEET NO.	TOTAL SHEETS
04	CC	580	6.13	82	123

REGISTERED CIVIL ENGINEER

3/12/10  
DATE

RAMSEY J. HESSEN  
No. C-39608  
Exp. 12/31/10  
CIVIL  
STATE OF CALIFORNIA

PLANS APPROVAL DATE

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BAY AREA TOLL AUTHORITY  
101 EIGHTH STREET  
OAKLAND, CA 94607

URS CORPORATION  
55 S. MARKET STREET  
SUITE 1500  
SAN JOSE, CA 95113

SHEET NOTES:


1. ANY EXISTING FURNITURE REQUIRED TO BE RE-ARRANGED FOR PLACEMENT OF CMS EQUIPMENT RACK SHALL BE COORDINATED WITH LIEUTENANT.
2. SECURE CONDUIT TO EXISTING CABLE TRAY USING CONDUIT CLAMPS OR CHANNEL STRUTS. SEE SHEET E-15 FOR TYP CONDUIT MOUNTING.
3. ALL CABLING IN CMS CABINETS SHALL BE INSTALLED AND NEATLY DRESSED AND SECURED IN CABINETS. SPARE COILED CABLING SHALL BE PROVIDED IN JUNCTION BOXES.
4. CONTRACTOR TO INSTALL, CONNECT, AND INTEGRATE ALL EQUIPMENT IN CMS CABINETS (I.E., TRANSFORMERS, BREAKERS, ETC.).
5. NEW IP ADDRESSABLE POWER STRIP TO BE RACK MOUNTABLE.
6. CONTRACTOR TO CONNECT TWO (2) LANES TO ONE TRANSFORMER AND TWO (2) LANES TO THE OTHER TRANSFORMER.
7. DO NOT CONNECT POWER STRIP TO GFI. CONNECT TO CABINET POWER SOURCE DIRECTLY BY MEANS OF A SEPARATE NEMA 5-15 SOCKET.

CMS EQUIPMENT RACK LAYOUT  
FOR LANES 4-7  
(RICHMOND - SAN RAFAEL) E-9

NO SCALE

BORDER LAST REVISED 2/1/2008

RELATIVE BORDER SCALE  
IS IN INCHES

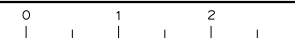

USERNAME => \$USER  
DGN FILE => \$REQUEST

CU 00000

EA TBD (BATA-0006)

SHEET	OF
9	17

LAST REVISION  
00-00-00  
DATE PLOTTED => \$DATE  
TIME PLOTTED => \$TIME

NOTES:

- 1 INSTALL NEW CIRCUIT BREAKER IN EXISTING SPACE.
- 2 THE CMS CABINET AND SIGNS SHALL BE CONNECTED TO THE BUILDING GROUNDING SYSTEM BY THE EQUIPMENT GROUND CONDUCTOR IN EACH CONDUIT.
- 3 ALL METAL PARTS OF THE SYSTEM SHALL BE BONDED TOGETHER PER CONTRACT SPECIFICATIONS.

Dist	COUNTY	ROUTE	POST MILES TOTAL PROJECT	SHEET NO.	TOTAL SHEETS
04	CC	580	6.13	83	123

*Carol Light*  
REGISTERED CIVIL ENGINEER

3/12/10  
DATE

PLANS APPROVAL DATE

REGISTERED PROFESSIONAL ENGINEER

CAROL LIGHT

No. 10145


Exp. 09/30/11

ELECTRICAL

STATE OF CALIFORNIA

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101 EIGHTH STREET  
OAKLAND, CA 94607

URS CORPORATION  
55 S. MARKET STREET  
SUITE 1500  
SAN JOSE, CA 95113

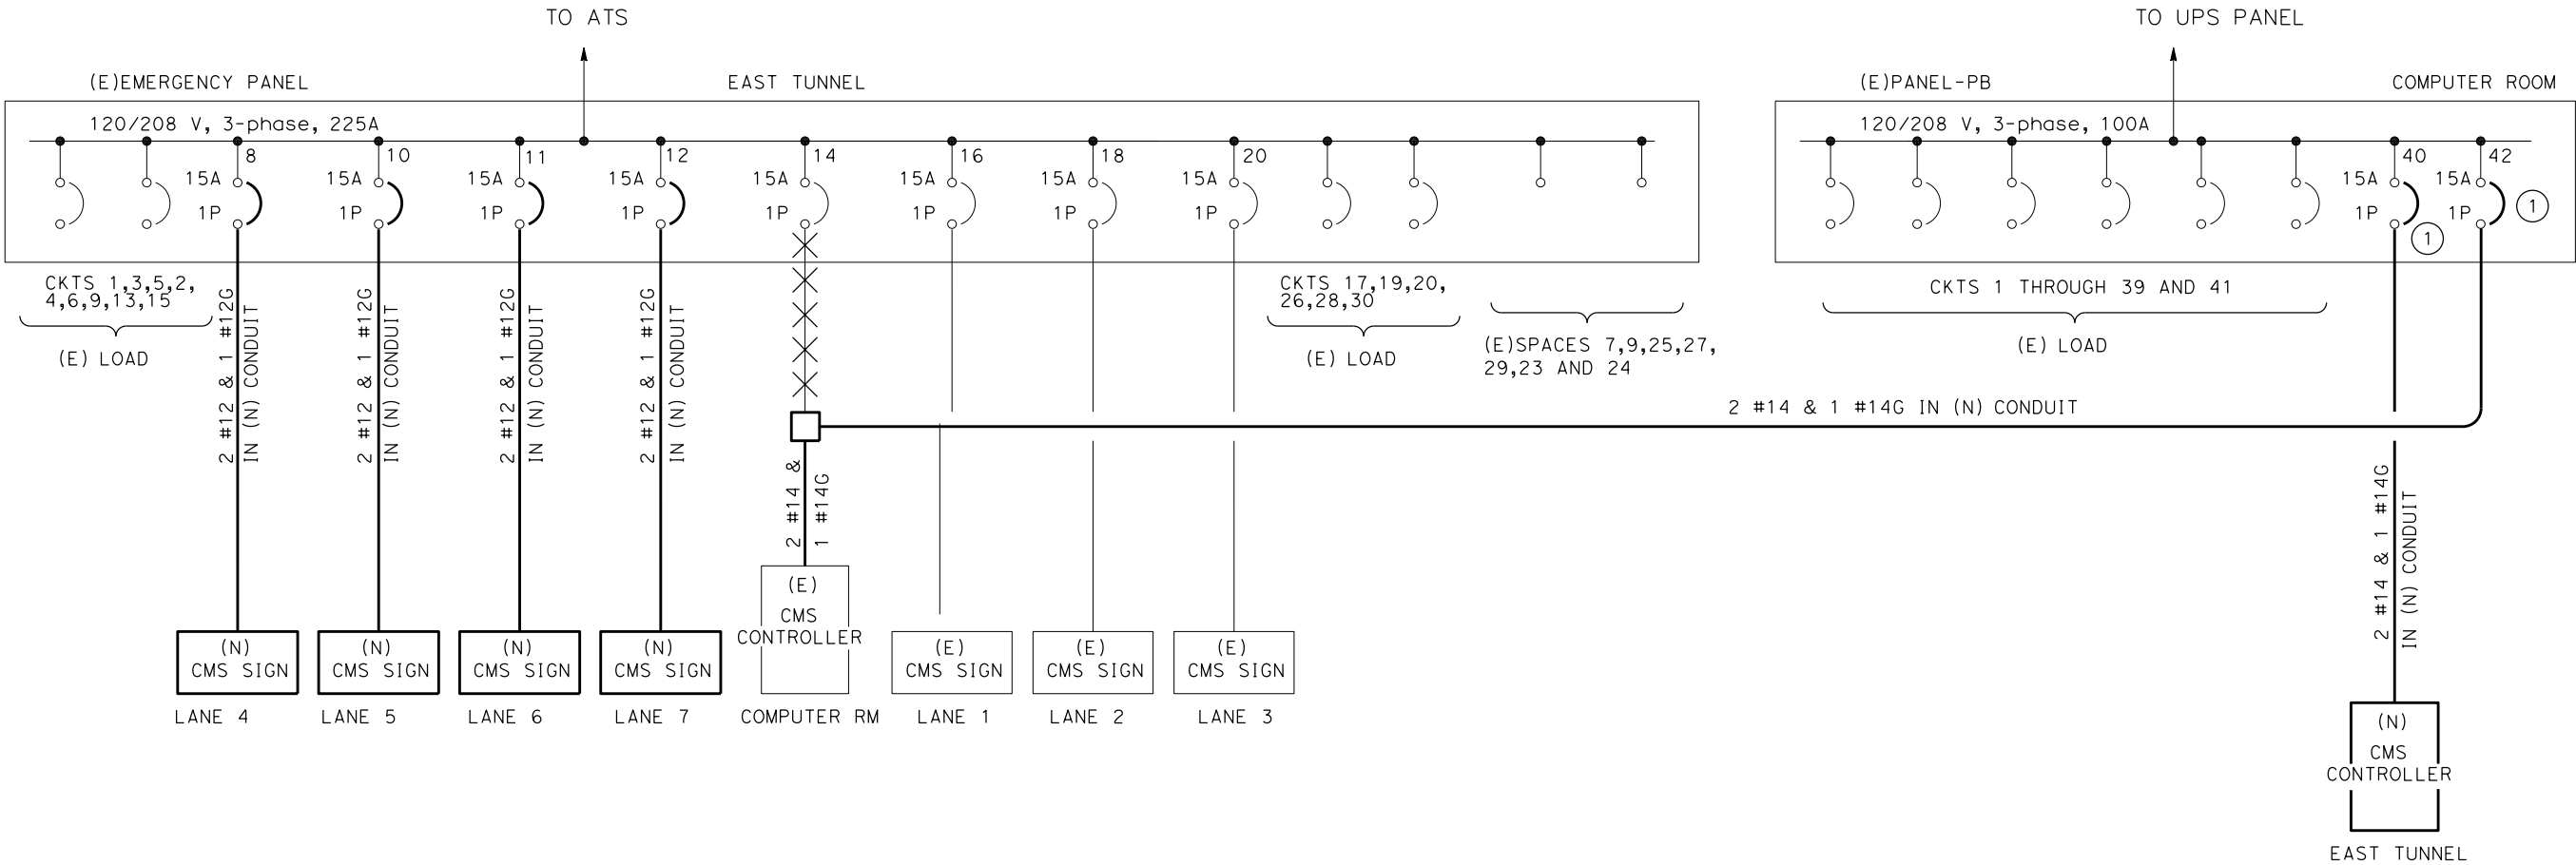

PARTIAL ONE LINE DIAGRAM  
(RICHMOND - SAN RAFAEL)  
NO SCALE


E-10

SHEET	OF
10	17


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





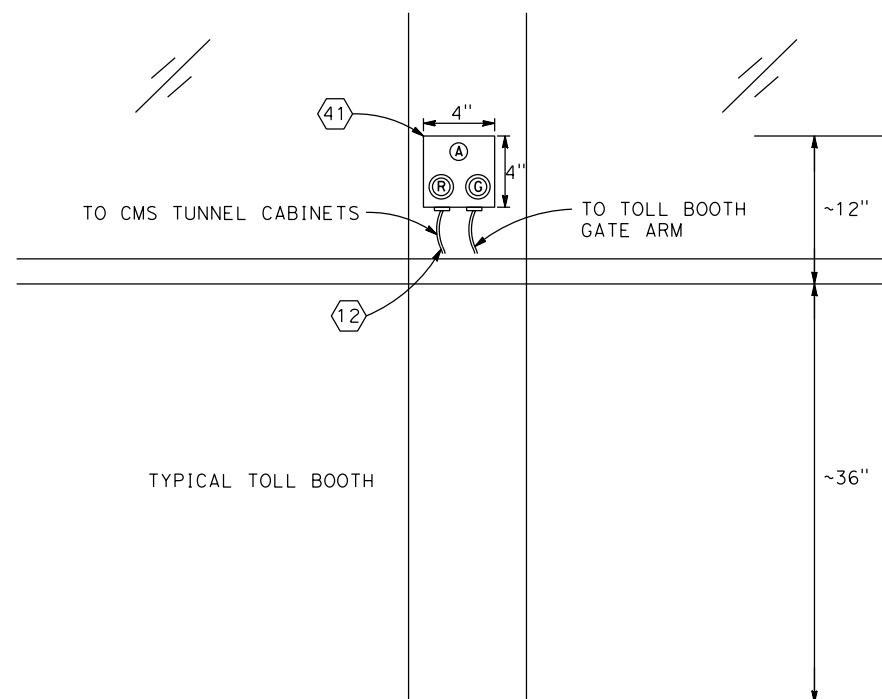

NEW TOLL BOOTH INDICATOR LIGHT SWITCH BOX

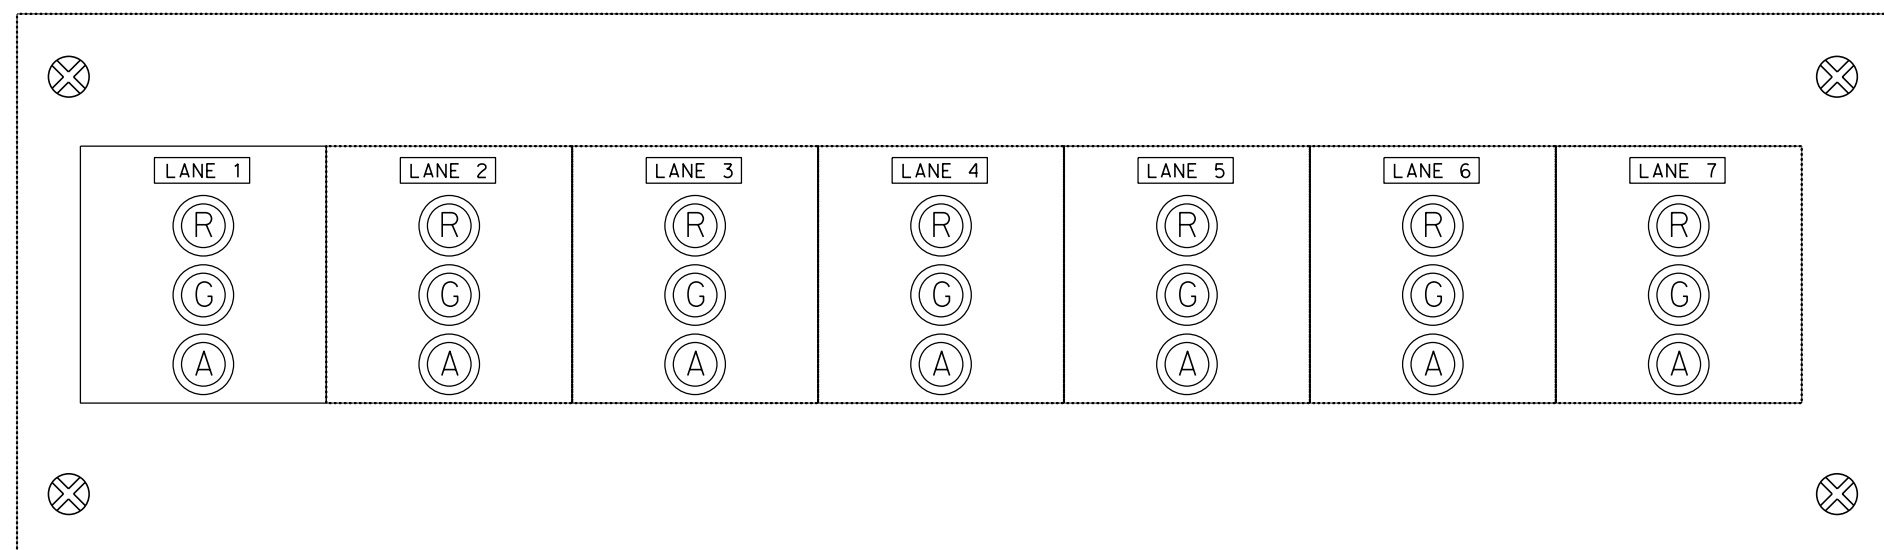

### LEGEND


- |   |   |
|---|---|
|  | PANEL MOUNT MOMENTARY RED LED<br>ILLUMINATED PUSH BUTTON SWITCH   |
|  | PANEL MOUNT MOMENTARY GREEN LED<br>ILLUMINATED PUSH BUTTON SWITCH |
|  | PANEL MOUNT MOMENTARY AMBER LED<br>ILLUMINATED PUSH BUTTON SWITCH |
|  | AMBER INDICATOR LED LIGHT   |

NOTES:

1. SIZE OF CONSOLE SWITCH PANEL WILL BE FIELD DETERMINED BY CONTRACTOR TO ACCOMMODATE NUMBER OF LANES.
2. SEE SHEET E-3 FOR LOCATION OF SWITCH CONSOLE PANEL.
3. SEE SHEETS E-13 TO E-14 FOR PROPOSED WIRING CONFIGURATION.
4. CONTRACTOR TO LABEL PUSH BUTTON SWITCH WITH R, G, AND A LETTERS FOR RED, GREEN, AND AMBER LANE INDICATION.

Dist	COUNTY	ROUTE	POST MILES TOTAL PROJECT	SHEET No.	TOTAL SHEET
04	CC	580	6.13	85	123


  

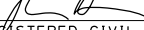

REGISTERED CIVIL ENGINEER

3/12/10

DATE

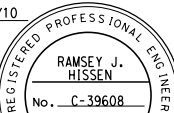

PLANS APPROVAL DATE \_\_\_\_\_

*THE STATE OF CALIFORNIA OR ITS OFFICERS  
OR AGENTS SHALL NOT BE RESPONSIBLE FOR  
THE ACCURACY OR COMPLETENESS OF SCANNED  
COPIES OF THIS PLAN SHEET.*

BAY AREA TOLL AUTHORITY 101 EIGHTH STREET OAKLAND, CA 94607	URS CORPORATION 55 S. MARKET STREET SUITE 1500 SAN JOSE, CA 95113
---	--


**INDICATOR LIGHT SWITCH CONSOLE PANEL  
AND TOLL BOOTH INDICATOR SWITCH BOX  
(RICHMOND-SAN RAFAEL)**

NO SCALE

SHEET	OF
12	17

STATE OF CALIFORNIA - DEPARTMENT OF TRANSPORTATION  
\$REQUEST  
\$REVISION  
00-00-00  
DATE PLOTTED => \$DATE  
TIME PLOTTED => \$TIME

REVISION	BY	DATE	REVISION	BY	DATE
1	DESIGNED BY		2	CHECKED BY	
3	CALCULATED-DESIGNED BY		4	CHECKED BY	
5	CONSULTANT FUNCTIONAL SUPERVISOR		6	CHECKED BY	
7	CONSULTANT FUNCTIONAL SUPERVISOR		8	CHECKED BY	
9	CONSULTANT FUNCTIONAL SUPERVISOR		10	CHECKED BY	
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DIST	COUNTY	ROUTE	POST MILES TOTAL PROJECT	SHEET NO.	TOTAL SHEETS
04	CC	580	6.13	86	123

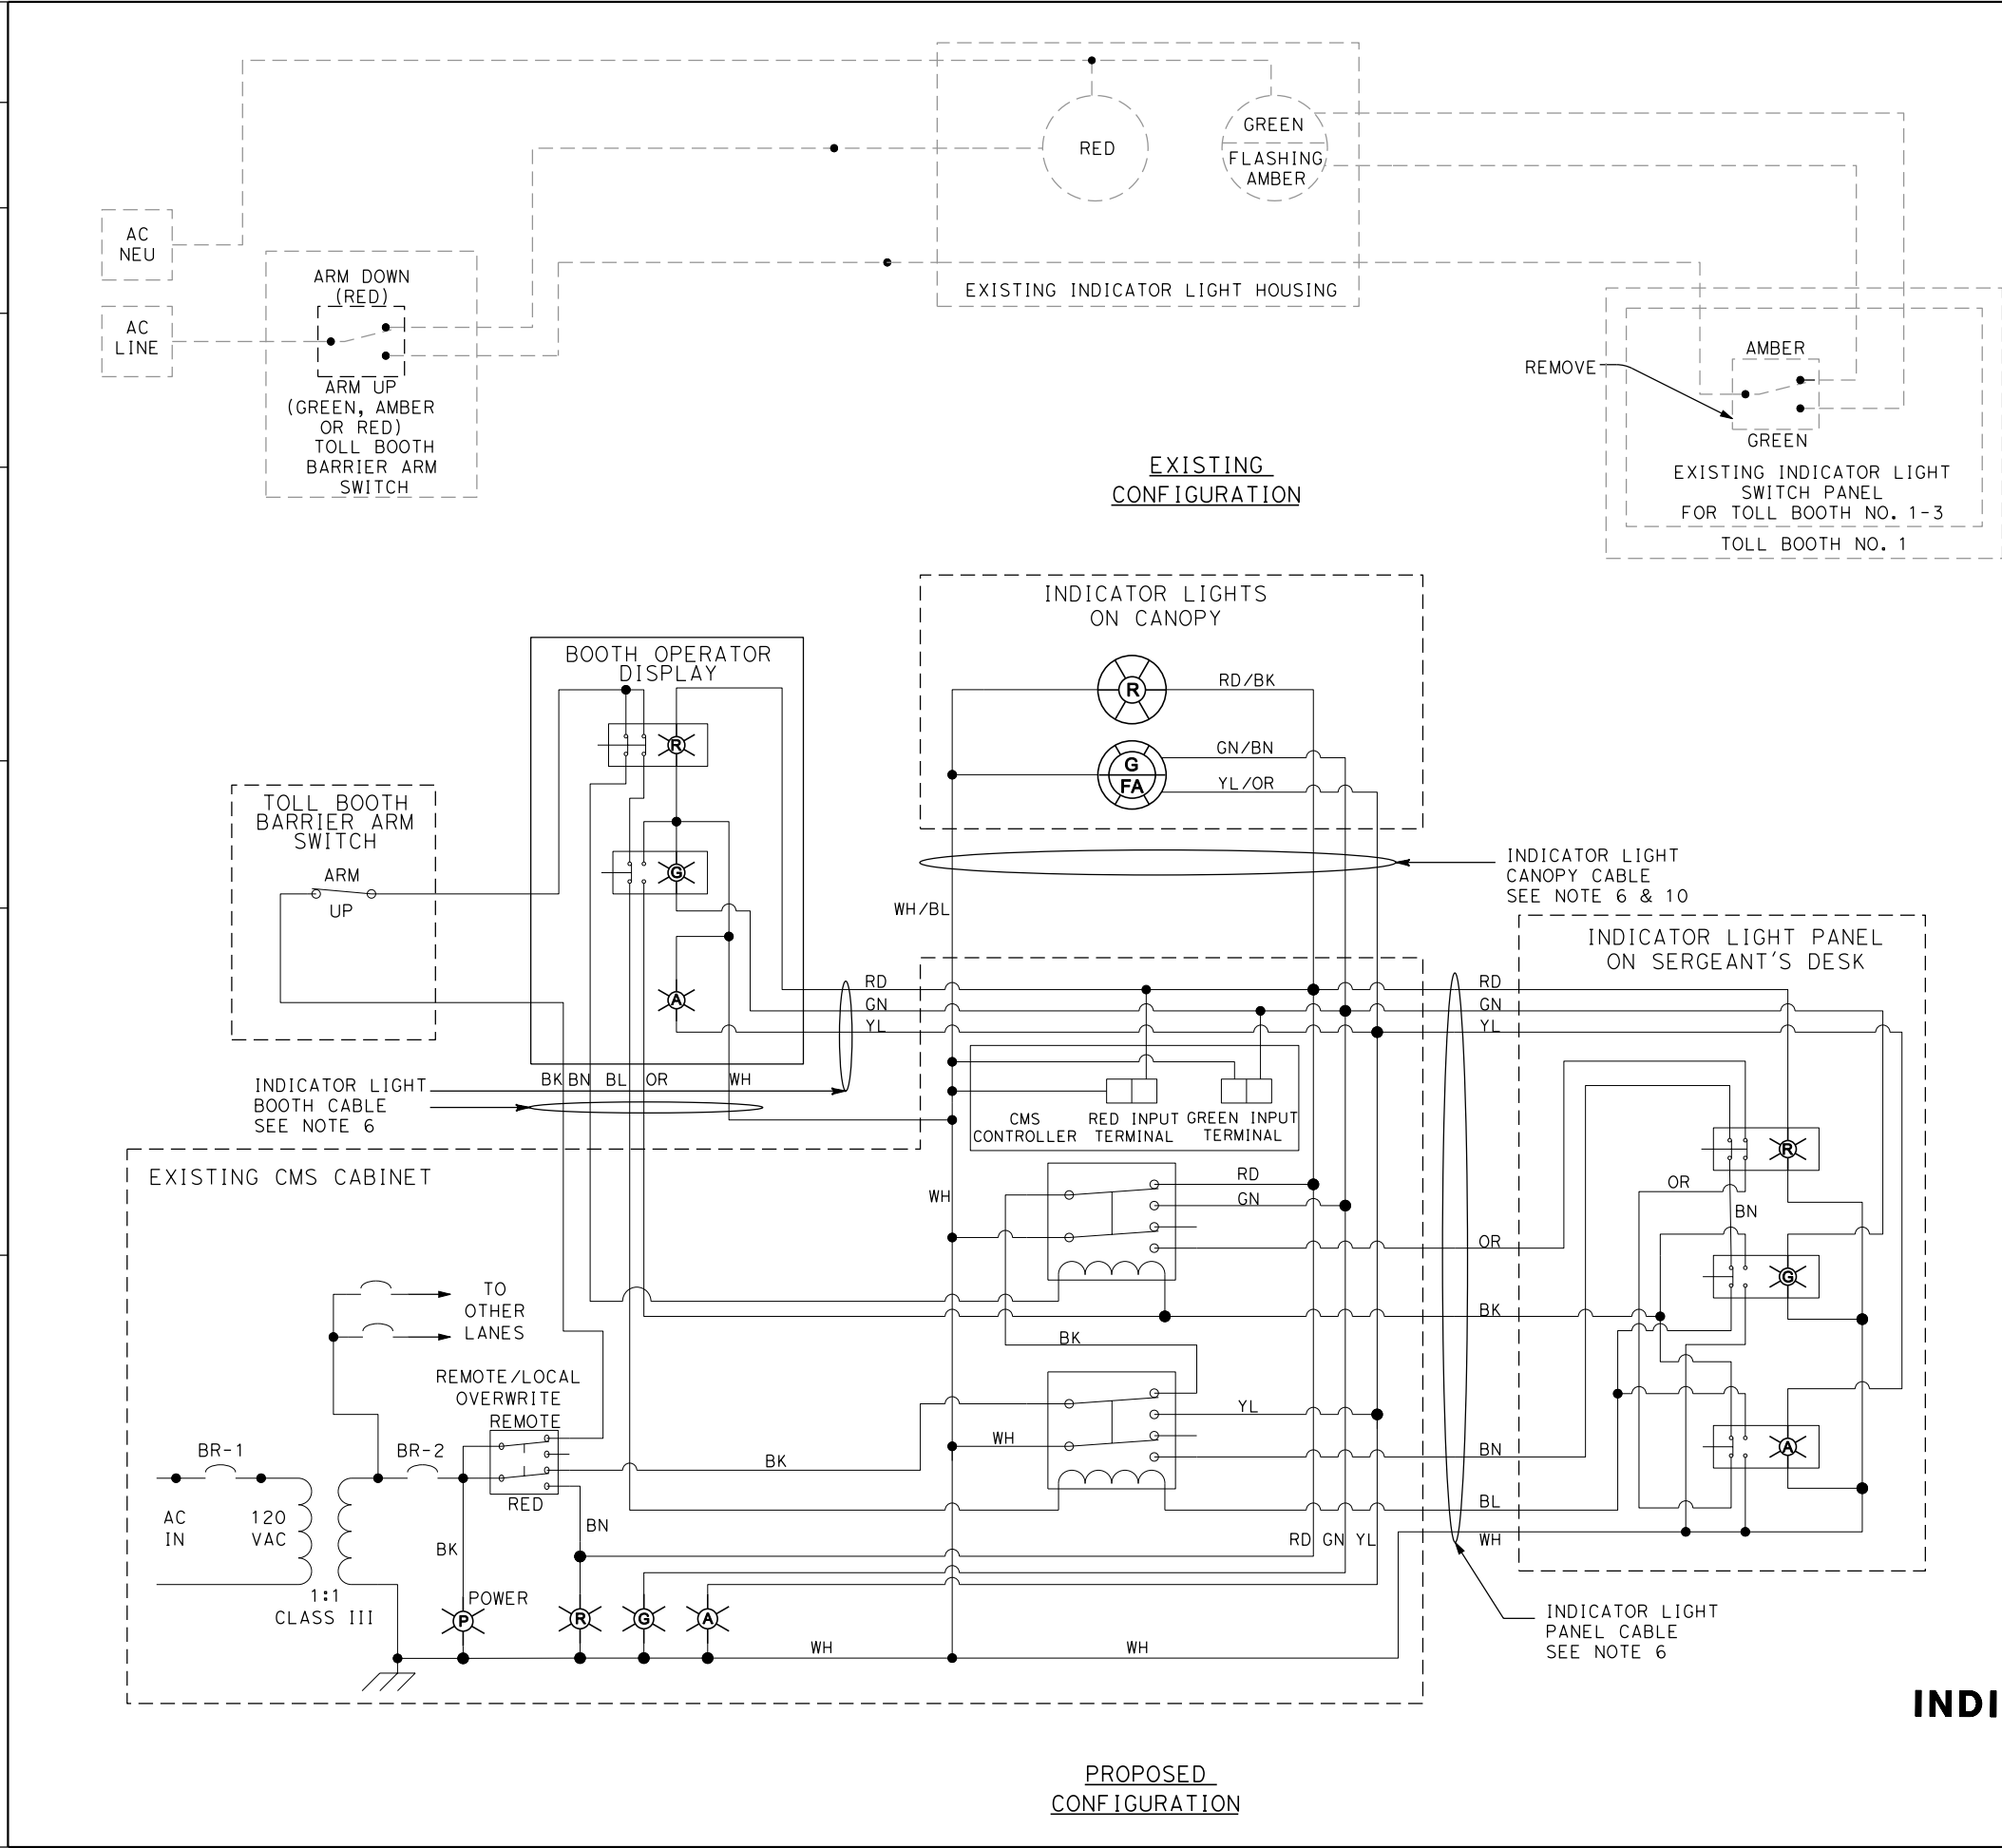REGISTERED CIVIL ENGINEER

3/12/10 DATE

PLANS APPROVAL DATE

THE STATE OF CALIFORNIA OR ITS OFFICERS OR AGENTS SHALL NOT BE RESPONSIBLE FOR THE ACCURACY OR COMPLETENESS OF SCANNED COPIES OF THIS PLAN SHEET.

BAY AREA TOLL AUTHORITY  
101 EIGHTH STREET  
OAKLAND, CA 94607

URS CORPORATION  
55 S. MARKET STREET  
SUITE 1500  
SAN JOSE, CA 95113

LEGEND

G GREEN INDICATOR LED LIGHT, 120 VAC

A AMBER INDICATOR LED LIGHT, 120 VAC

R RED INDICATOR LED LIGHT, 120 VAC

FA FLASHING AMBER LED LIGHT, 120 VAC

CMS CABINET TERMINAL BLOCK X-B  
X = LANE NUMBER  
B = TERMINAL BLOCK NUMBER

BR-1 2A AMP BREAKER, 120 VAC (1 PER CMS CABINET)

BR-2 1/2 AMP PUSH BUTTON BREAKER, 120 VAC (3 PER CMS CABINET - SEE NOTE 8)

CLASS 3, 100 WATT 1:1, 120 VAC TRANSFORMER (PER 3 CMS CONTROLLERS SEE NOTE 9)

BREAKER

CANOPY LED INDICATOR

DPDT SWITCH

DPDT RELAY

NC + NC PUSH BUTTON SWITCH W/ INDICATOR

NC + NO PUSH BUTTON SWITCH W/ INDICATOR

PANEL MOUNT LIGHT INDICATOR (120 VAC)

NOTES:

1. ELECTRICAL DIAGRAM SHOWS A SINGLE (ONE) FASTRAK LANE FOR SIMPLICITY.

2. SEE SHEET E-12 FOR INDICATOR LIGHT SWITCH CONSOLE DETAIL.

3. INTERCEPT EXISTING GATE ARM CABLE IN TOLL BOOTH.

4. POWER TO TRANSFORMER FROM CMS CABINET POWER STRIP.

5. REMOVE EXISTING SWITCH AND INSTALL NEW INDICATOR LED LIGHTS AND PUSH BUTTON SWITCHES ON WALL BOX.

6. BELDEN 5506UE CABLE OR APPROVED EQUIVALENT.

7. REPLACE EXISTING GREEN INDICATOR LIGHT ON CANOPY WITH NEW GREEN / FLASHING AMBER LED LIGHT.

8. ONE (1) 1/2 AMP PUSH BUTTON BREAKER PER CMS CONTROLLER OR THREE (3) 1/2 AMP PUSH BUTTON BREAKERS PER CMS CABINET WITH 3 CMS CONTROLLERS.

9. ONE (1) CLASS THREE, 100W 1:1, 120 VAC TRANSFORMER PER 3 CMS CONTROLLERS.

10. USE TWO CONDUCTORS FOR NEUTRAL, TWO CONDUCTORS FOR RED, TWO CONDUCTORS FOR GREEN, AND TWO CONDUCTORS FOR FLASHING AMBER CONNECTIONS FROM CMS CABINET TO INDICATOR LIGHTS ON CANOPY.

INDICATOR LIGHT WIRING DIAGRAM  
FOR LANES 1-3  
(RICHMOND - SAN RAFAEL) E-13

NO SCALE

SHEET	OF
13	17

BORDER LAST REVISED 2/1/2008


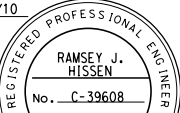
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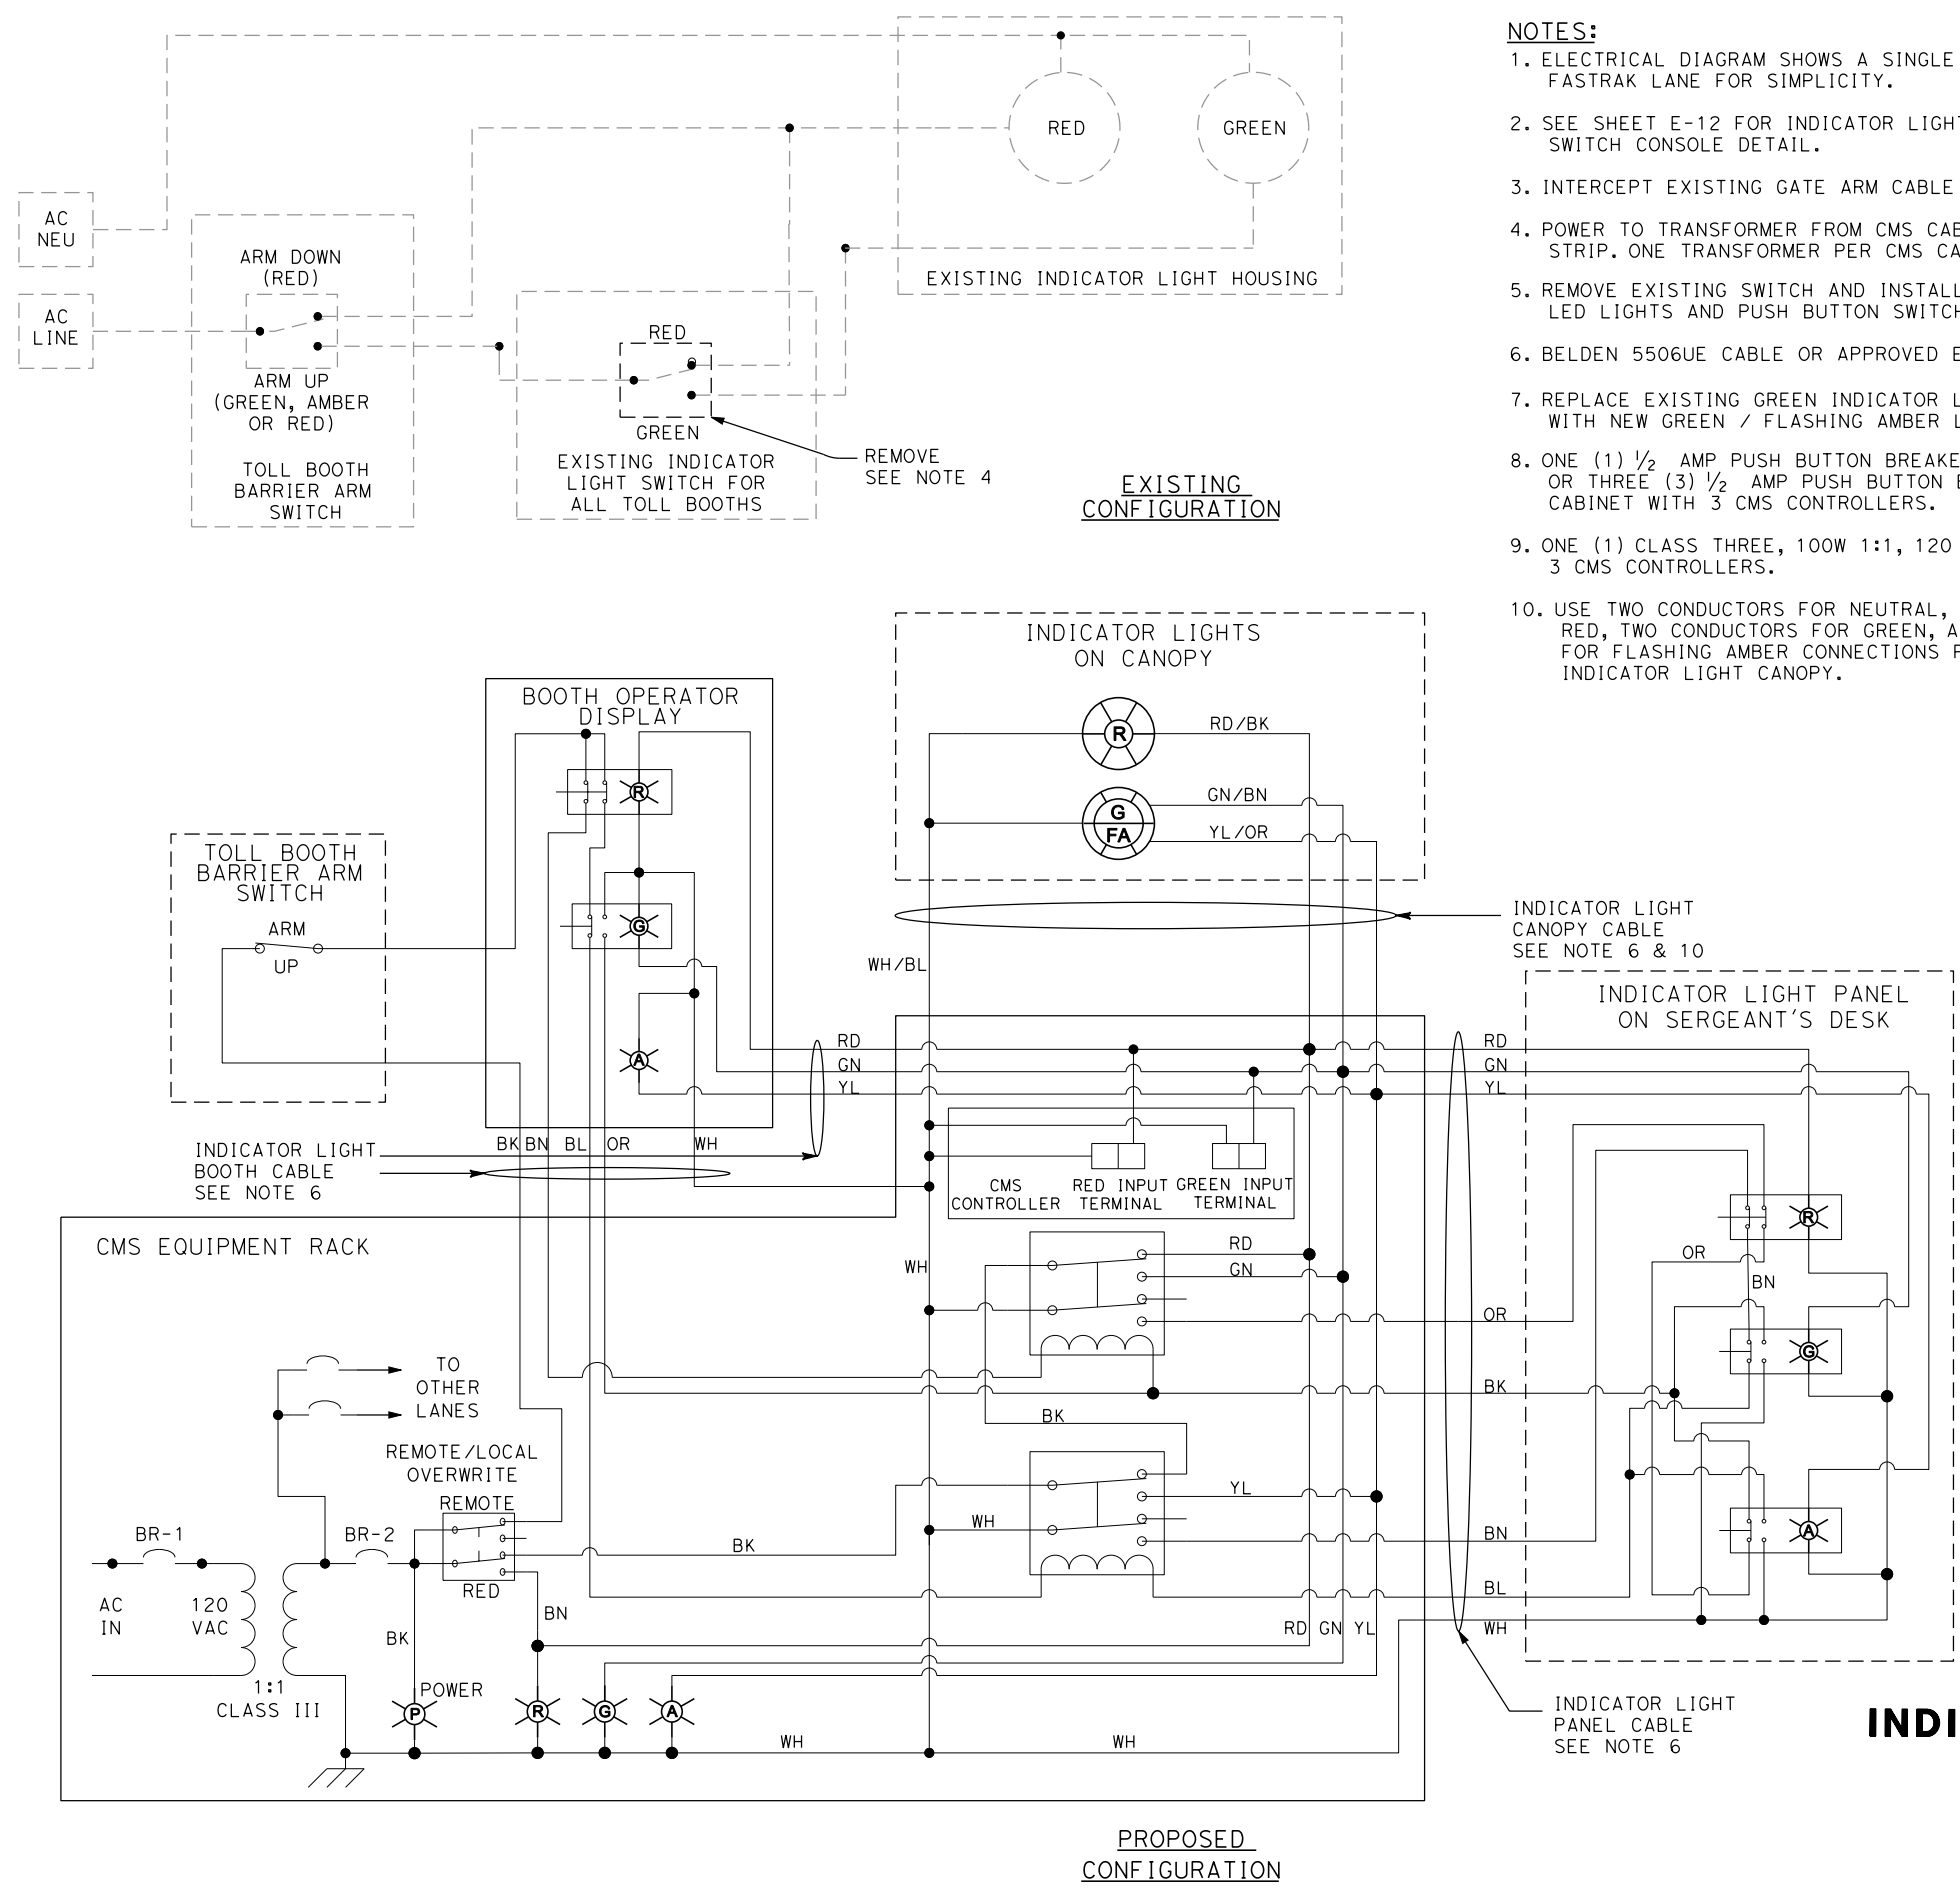
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




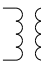







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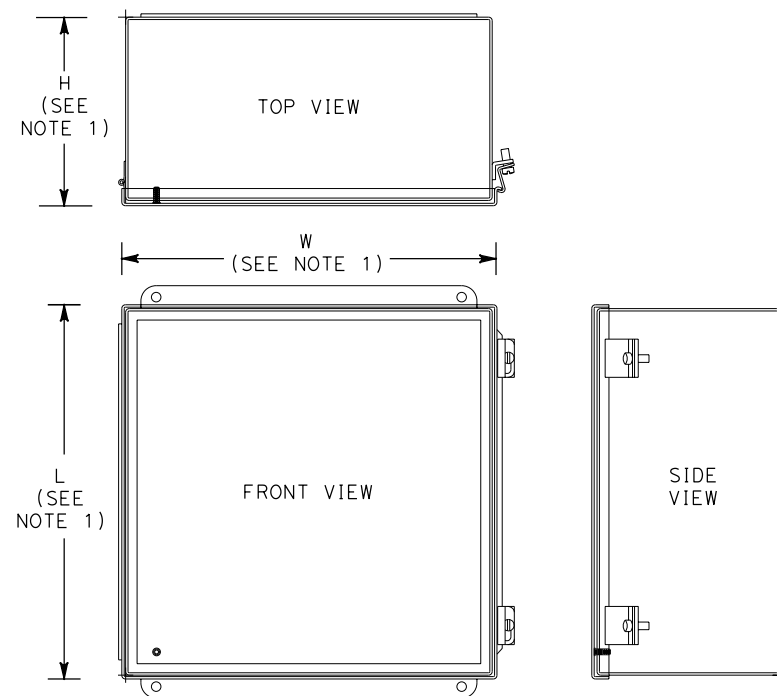
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PLANS APPROVAL DATE _____					
<i>THE STATE OF CALIFORNIA OR ITS OFFICERS OR AGENTS SHALL NOT BE RESPONSIBLE FOR THE ACCURACY OR COMPLETENESS OF SCANNED COPIES OF THIS PLAN SHEET.</i>					
BAY AREA TOLL AUTHORITY 101 EIGHTEEN STREET OAKLAND, CA 94607			URS CORPORATION 55 S. MARKET STREET SUITE 1500 SAN JOSE, CA 95113		

- NOTES:**
1. ELECTRICAL DIAGRAM SHOWS A SINGLE (ONE) FASTRAK LANE FOR SIMPLICITY.
  2. SEE SHEET E-12 FOR INDICATOR LIGHT SWITCH CONSOLE DETAIL.
  3. INTERCEPT EXISTING GATE ARM CABLE IN TOLL BOOTH.
  4. POWER TO TRANSFORMER FROM CMS CABINET POWER STRIP. ONE TRANSFORMER PER CMS CABINET.
  5. REMOVE EXISTING SWITCH AND INSTALL NEW INDICATOR LED LIGHTS AND PUSH BUTTON SWITCHES ON WALL BOX.
  6. BELDEN 5506UE CABLE OR APPROVED EQUIVALENT.
  7. REPLACE EXISTING GREEN INDICATOR LIGHT ON CANOPY WITH NEW GREEN / FLASHING AMBER LED LIGHT.
  8. ONE (1) 1/2 AMP PUSH BUTTON BREAKER PER CMS CONTROLLER OR THREE (3) 1/2 AMP PUSH BUTTON BREAKERS PER CMS CABINET WITH 3 CMS CONTROLLERS.
  9. ONE (1) CLASS THREE, 100W 1:1, 120 VAC TRANSFORMER PER 3 CMS CONTROLLERS.
  10. USE TWO CONDUCTORS FOR NEUTRAL, TWO CONDUCTORS FOR RED, TWO CONDUCTORS FOR GREEN, AND TWO CONDUCTORS FOR FLASHING AMBER CONNECTIONS FROM CMS CABINET TO INDICATOR LIGHT CANOPY.



LEGEND



-  GREEN INDICATOR LED LIGHT, 120 VAC  
 AMBER INDICATOR LED LIGHT, 120 VAC  
 RED INDICATOR LED LIGHT, 120 VAC  
 FLASHING AMBER LED LIGHT, 120 VAC  
 CMS CABINET TERMINAL BLOCK X-B  
X = LANE NUMBER  
B = TERMINAL BLOCK NUMBER  
BR-1 2A AMP BREAKER, 120 VAC (1 PER CMS CABINET)  
BR-2 1/2 AMP PUSH BUTTON BREAKER, 120 VAC (3 PER CMS CABINET - SEE NOTE 8)  
 CLASS 3, 100 WATT 1:1, 120 VAC TRANSFORMER (PER 3 CMS CONTROLLERS SEE NOTE 9)  
 BREAKER  
 CANOPY LED INDICATOR  
 DPDT SWITCH  
 DPDT RELAY  
 NC + NC PUSH BUTTON SWITCH W/ INDICATOR  
 NC + NO PUSH BUTTON SWITCH W/ INDICATOR  
 PANEL MOUNT LIGHT INDICATOR (120 VAC)

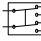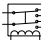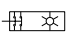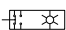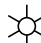

NEMA 4X JUNCTION BOX  
(SHOWN WITH HINGE)

NOTES:

1. TYPE 1 NEMA 4X JUNCTION BOX (12"L X 12"W X 6"D, TYP.) OR AS REQ'D.  
TYPE 3 NEMA 4X JUNCTION BOX (5"L X 6"W X 4"D, TYP.) OR AS REQ'D.
2. MINIMUM SIZES OF JUNCTION BOXES SHOWN. CONTRACTOR SHALL  
CONFIRM SIZES AND QUANTITIES IN FIELD AND SUBMIT SHOP  
DRAWINGS TO ENGINEER FOR APPROVAL.
3. FOR JUNCTION BOX MOUNTED ON EXISTING CONCRETE WALLS OR  
SURFACE FLOOR MOUNTED USE  $\frac{3}{8}$ " EXPANSION ANCHORS, TOTAL  
OF 4 FOR EACH BOX.
4. COIL A MINIMUM OF 3' OF CABLE FOR EACH DEVICE IN THE TYPE 1  
AND TYPE 3 JUNCTION BOXES.
5. SEE SHEETS E-13 AND E-14 FOR INDICATOR LIGHT WIRING DIAGRAMS.

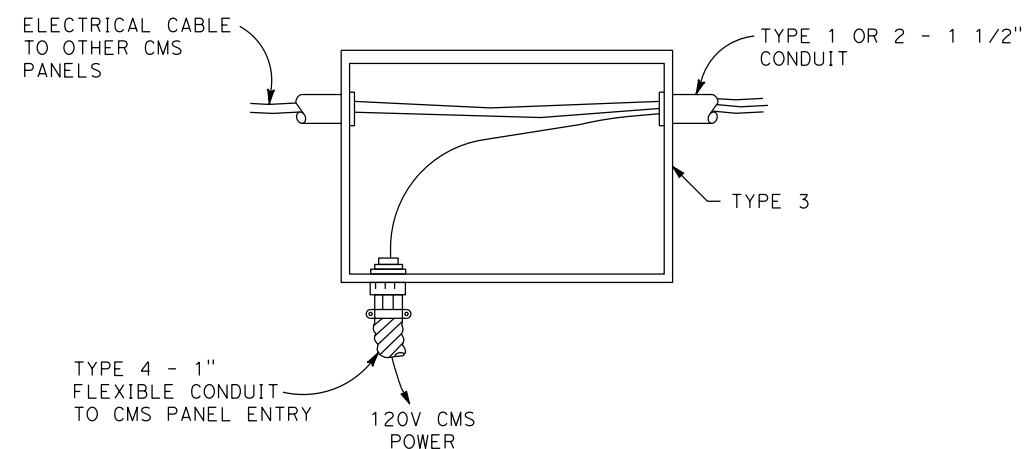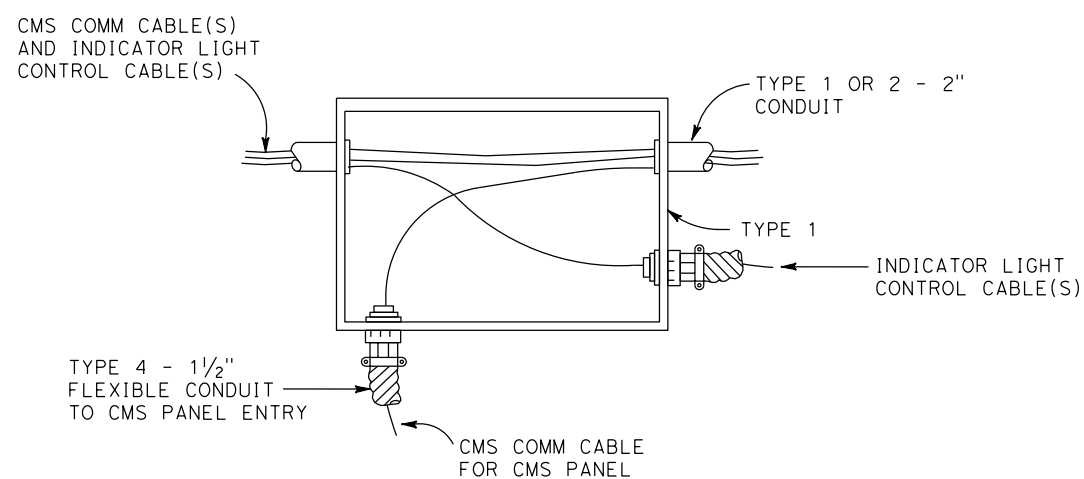

## JUNCTION BOX DETAILS (RICHMOND - SAN RAFAEL)

NO SCALE





x

x

x

x

x

\$REQUEST

STATE OF CALIFORNIA - DEPARTMENT OF TRANSPORTATION

Caltrans

CALCULATED-  
DESIGNED BY


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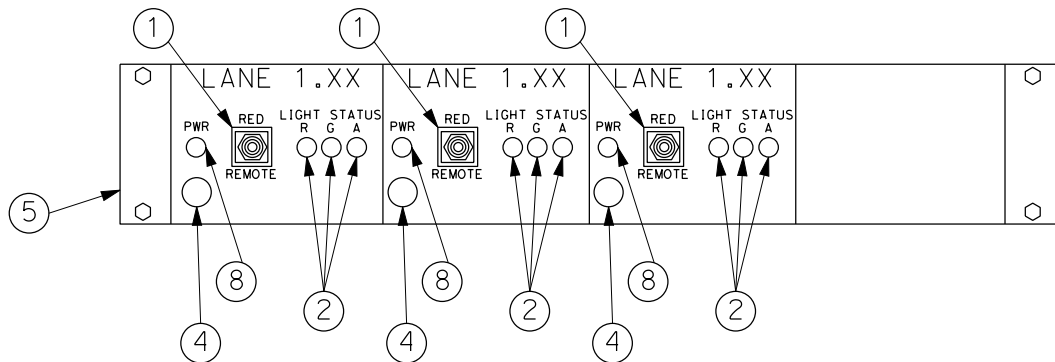
DATE REVISED

ITEM	COMPONENT
①	ONE (1) NEW PANEL MOUNT DPDT TOGGLE SWITCH
②	NEW PANEL MOUNT RED, GREEN, AMBER LED INDICATOR LIGHTS (120VAC)
③	TERMINAL BLOCKS FOR INDICATOR LIGHT CANOPY CABLE AND POWER
④	ONE (1) NEW PANEL MOUNT 1/2 AMP PUSH BUTTON BREAKER (120 VAC)
⑤	INSTALL NEW PULL OUT DRAWER FOR WIRING OF NEW INDICATOR LIGHT RELAYS.
⑥	TWO (2) NEW DPDT RELAYS
⑦	DRILLED HOLES AT BOTTOM OF DRAWER FOR INDICATOR LIGHT CABLE
⑧	NEW PANEL MOUNT BLUE LED INDICATOR LIGHT (120VAC) FOR POWER INDICATION
⑨	TERMINAL BLOCKS FOR INDICATOR LIGHT BOOTH CABLE
⑩	TERMINAL BLOCKS FOR INDICATOR LIGHT PANEL CABLE

TOP VIEW



FRONT VIEW

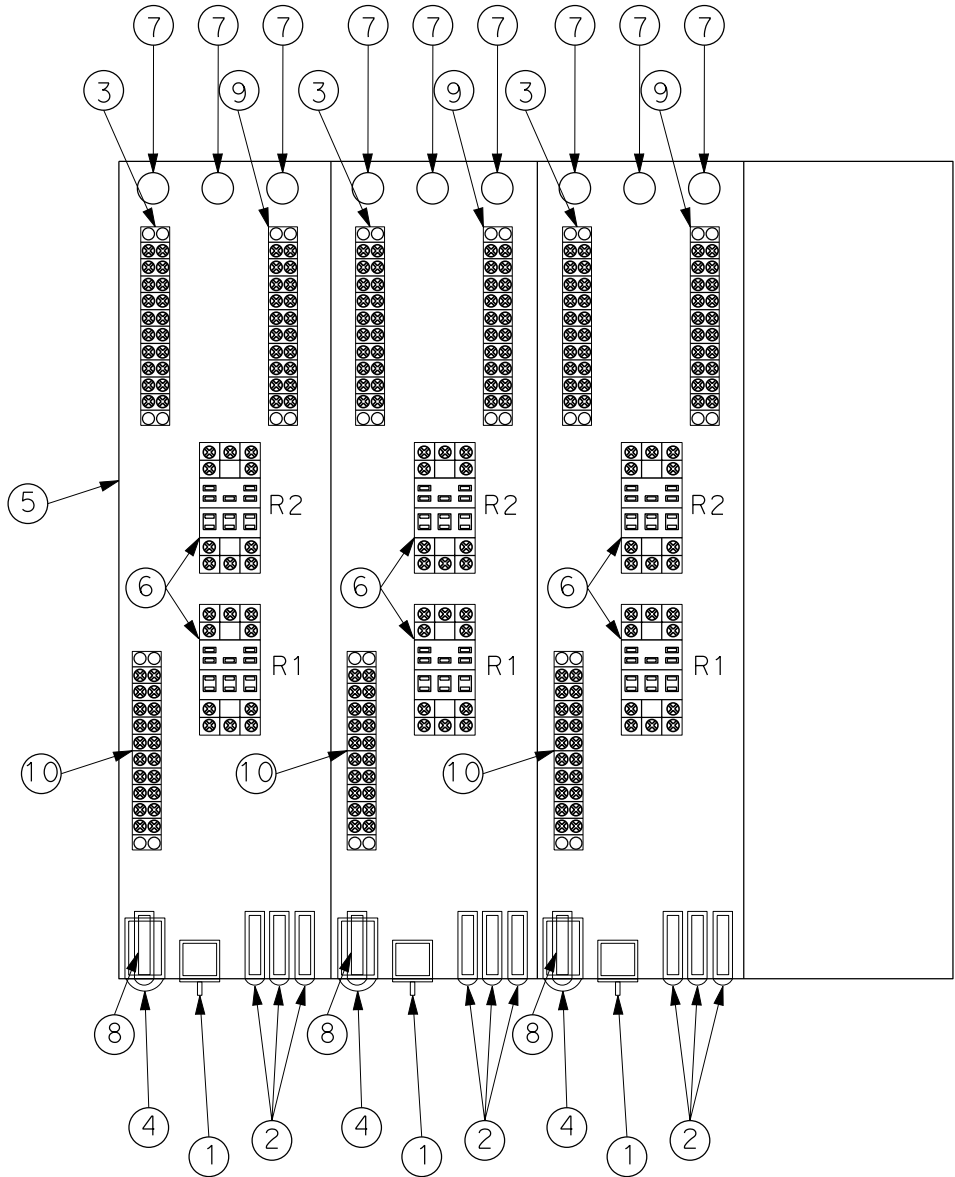

Dist	COUNTY	ROUTE	POST MILES TOTAL PROJECT	SHEET No.	TOTAL SHEETS
04	CC	580	6.13	90	123
REGISTERED CIVIL ENGINEER			3/12/10 DATE	REGISTERED PROFESSIONAL ENGINEER RAMSEY J. HISSON No. C-39608 Exp. 12/31/10 CIVIL STATE OF CALIFORNIA	
PLANS APPROVAL DATE					
THE STATE OF CALIFORNIA OR ITS OFFICERS OR AGENTS SHALL NOT BE RESPONSIBLE FOR THE ACCURACY OR COMPLETENESS OF SCANNED COPIES OF THIS PLAN SHEET.					
BAY AREA TOLL AUTHORITY 101 EIGHTH STREET OAKLAND, CA 94607			URS CORPORATION 55 S. MARKET STREET SUITE 1500 SAN JOSE, CA 95113		

NOTES:

1. ALL EQUIPMENT SHALL BE SECURED. NO EQUIPMENT WILL BE LAYING IN BOTTOM OF CABINET. INSTALLATION SHALL BE NEAT, DRESSED AND ACCORDING TO THE PLANS.
2. CONTRACTOR SHALL SUBMIT MATERIAL SUBMITTALS FOR ALL CABINET COMPONENTS TO THE ENGINEER FOR REVIEW AND APPROVAL PRIOR TO PROCUREMENT AND INSTALLATION.
3. INDICATOR LIGHT CABLES TO BE WIRED ACCORDING TO THE INDICATOR LIGHT WIRING DIAGRAMS AS SHOWN ON SHEETS E-13 TO E-14.
4. INDICATOR LIGHT DRAWER LAYOUT SHOWN FOR TYPICAL CMS CABINET.
5. ROUTE ALL CABLES THROUGH DRILLED HOLES AT BOTTOM OF DRAWER. INCLUDE PLASTIC GROMMETS IN HOLE.
6. TERMINATE ALL CABLES ON NEW TERMINATION BLOCKS.
7. FASTEN ALL CABLES TO DRAWER TO PREVENT STRAINING ON TERMINATION BLOCKS.
8. EACH CABINET DRAWER SHALL BE DESIGNED TO ACCOMMODATE UP TO FOUR (4) INDICATOR CONTROL LANES.
9. CONTRACTOR TO LEAVE AT LEAST ONE RACK UNIT OF SPACE BETWEEN DRAWER AND BOTTOM OF CABINET.

INDICATOR LIGHT  
CABINET DRAWER LAYOUT  
(RICHMOND - SAN RAFAEL)

NO SCALE

E-17

SHEET	OF
17	17

RELATIVE BORDER SCALE  
IS IN INCHES

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USERNAME => \$USER  
DGN FILE => \$REQUEST

CU 00000

EA TBD (BATA-0006)

DATE PLOTTED => \$DATE  
TIME PLOTTED => \$TIME  
LAST REVISION  
00-00-00

DIST	COUNTY	ROUTE	POST MILES TOTAL PROJECT	SHEET No	TOTAL SHEETS
04	Alameda	80	1.99	91	123
REGISTERED CIVIL ENGINEER			DATE	3/12/10	
PLANS APPROVAL DATE			3/12/10		
The State of California or its officers or agents shall not be responsible for the accuracy or completeness of electronic copies of this plan sheet.					
BAY AREA TOLL AUTHORITY 101 EIGHTH STREET OAKLAND, CALIFORNIA 94607					
MGE ENGINEERING, INC. 7415 GREENHAVEN DRIVE, SUITE 100 SACRAMENTO, CALIFORNIA 95831					

REGISTERED PROFESSIONAL ENGINEER


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No. C 63977

Exp. 09/30/10


CIVIL

STATE OF CALIFORNIA

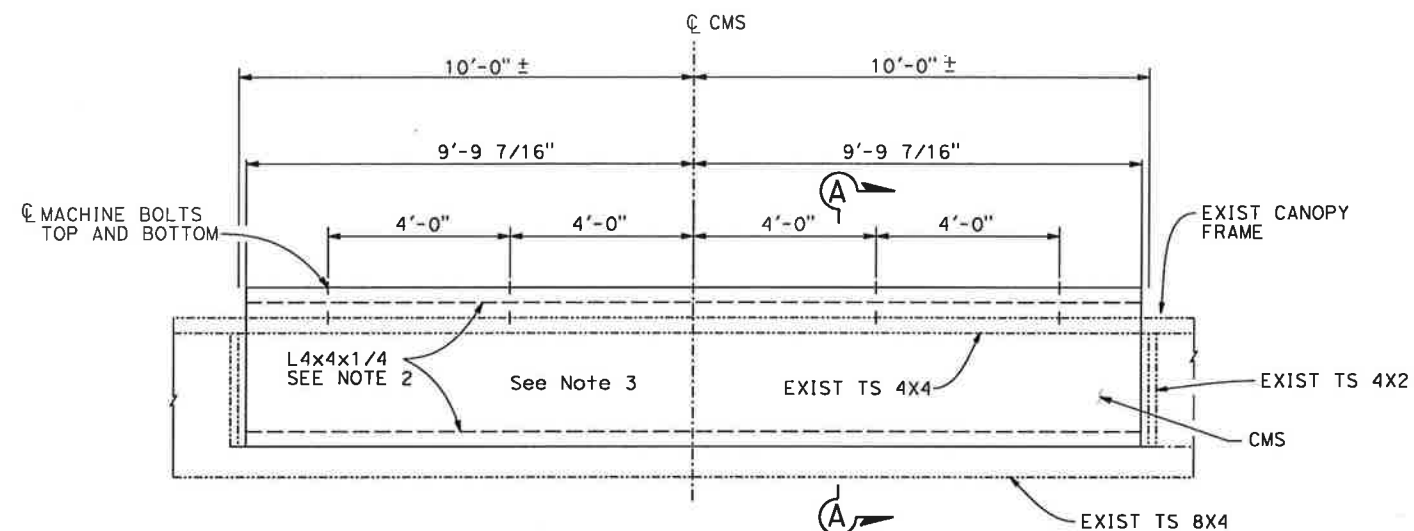

### CMS SUPPORT ELEVATION

SCALE: 1/2" = 1'-0"

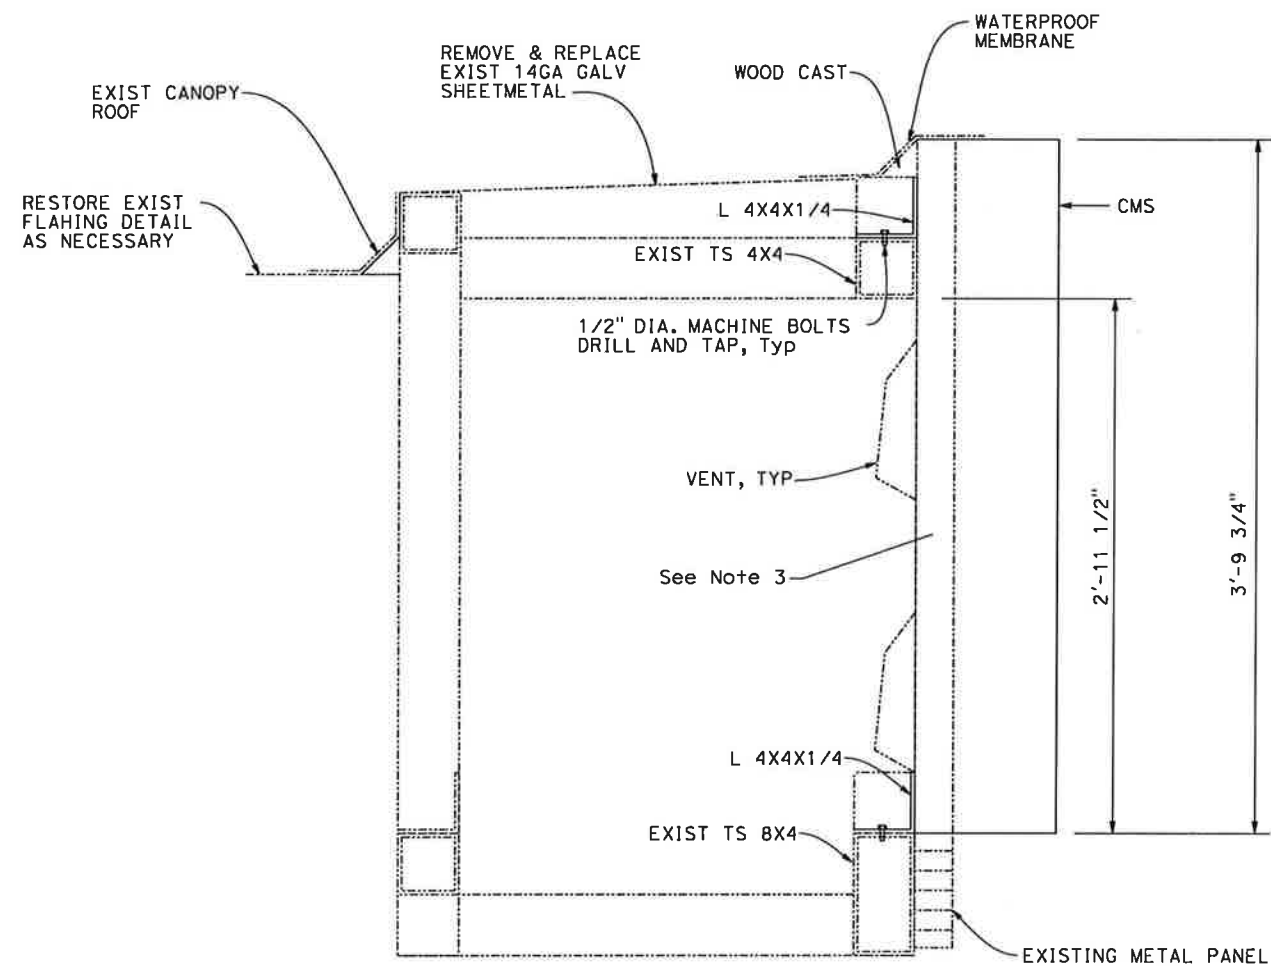

### SECTION A-A

SCALE: 2" = 1'-0"

#### Notes:

- For location and number of new CMS panels, see layout sheet L-11.
- The angle sections are part of the CMS panel.
- Remove existing CMS, curtains, sliding screen carrier, track and corner glide, etc., prior to installing new CMS.

#### Legend:

- Indicates New Structure
- Indicates Exist Structure

Note:  
The Contractor shall verify all controlling field dimensions before ordering or fabricating any material.

DESIGN OVERSIGHT	DESIGN BY G. Xu	CHECKED	PREPARED FOR THE STATE OF CALIFORNIA DEPARTMENT OF TRANSPORTATION	BRIDGE NO.	SFOBB TOLL PLAZA	SHEET
SIGN OFF DATE	DETAILS BY E. Garnica	CHECKED	CU EA	POST MILE	CMS SUPPORT	S-1
DESIGN DETAIL SHEET (ENGLISH) (REV. 2/25/05)	QUANTITIES BY	CHECKED	FILE => ...\\Structural\\Structual_CMS-1.dgn	1.99	REVISION DATES (PRELIMINARY STAGE ONLY)	1 1
ORIGINAL SCALE IN INCHES FOR REDUCED PLANS				DISREGARD PRINTS BEARING EARLIER REVISION DATES		

[illegible]



SHEET NOTES:

- 1 (E) 1" CONDUIT
- 2 REMOVE AND REPLACE (E) 3 #8 WITH 2 #10 & 1 #12G (120V, CLOCK)
- 3 REMOVE AND REPLACE (E) 6 #8 WITH 4 #10 & 2 #12G (120V, CLOCK)
- 4 CONNECT (N) 2 #10 & 1 #12G (120 V) IN (E) 1" TYPE 4 CONDUIT TO NEW CMS CLOCK PANEL #1
- 5 INSTALL CMS CLOCK COMM CABLE(S)
- 6 INSTALL (N) 2" TYPE 1 CONDUIT
- 7 INSTALL (N) 1" TYPE 4 CONDUIT WITH CABLES
- 8 INSTALL (N) TYPE 1 JB
- 9 INSTALL (N) CMS PANEL
- 10 (E) 3" CONDUIT
- 11 (E) 20"X20"X8" TYPE 1 JB

Dist

COUNTY

ROUTE

POST MILES  
TOTAL PROJECT

SHEET  
No.

TOTAL  
SHEETS

04

Ala

80

1.99/2.1

94

123

REGISTERED CIVIL ENGINEER

3/12/10  
DATE

PLANS APPROVAL DATE

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URS CORPORATION  
55 SOUTH MARKET STREET  
SUITE 1500  
SAN JOSE, CA 95113-2332

BAY AREA TOLL AUTHORITY  
101 EIGHTH STREET  
OAKLAND, CA 94607

REGISTERED PROFESSIONAL ENGINEER

RAMSEY J.  
HISSEN

No. C-39608

Exp. 12/31/10

CIVIL

STATE OF CALIFORNIA

NOTES:

1. CONTRACTOR TO FIELD VERIFY ALL EXISTING CONDUIT AND JUNCTION BOXES FOR USE ON THIS PROJECT. CONTRACTOR SHALL PROVIDE AND INSTALL NEW CONDUIT AND JUNCTION BOXES AS NEEDED OR REQUIRED.

2. ALL INSTALLED CMS PANELS ARE TO BE CONNECTED TO THE BUILDING GROUND SYSTEM.

ELEVATION VIEW

TUNNEL TO CANOPY CONDUIT ROUTING

(SHEET 1 OF 2)

(SAN FRANCISCO-OAKLAND BAY BRIDGE)

THIS PLAN ACCURATE FOR ELECTRICAL WORK ONLY

NO SCALE

BORDER LAST REVISED 4/11/2008

RELATIVE BORDER SCALE  
IS IN INCHES

0 1 2 3

USERNAME=> \$USER\$  
DGN FILE=> \$FILE\$

CU 00000

EA TBD (BATA-0006)

E-3

SHEET OF

3 10

LAST REVISION

00-00-00

SHEET NOTES:

- ① (E) 1" CONDUIT
- ② REMOVE AND REPLACE (E) 3 #8 WITH 2 #10 & 1 #12G (120V, CLOCK)
- ③ DISCONNECT (E)BRANCH CIRCUITS 4/6, 8/10 AND 5/7 (CMS 6, 7 & 8) AND LABEL CIRCUIT BREAKERS (40A-2P) AS SPARE
- ④ CONNECT (N) CMS CLOCK PANELS 1, 2 & 3 TO (E) 20A-1P CIRCUIT BREAKERS 9, 11 & 12 SEE PANEL SCHEDULE FOR MORE INFORMATION
- ⑤ CONNECT NEW 2 #10 & 1 #12 (120V) IN (E) 1" TYPE 4 CONDUIT TO NEW CLOCK PANEL
- ⑥ PROVIDE NEW REVISED (TYPE WRITTEN) PANEL SCHEDULE
- ⑦ INSTALL CMS CLOCK COMM CABLE(S) IN (E) CONDUIT
- ⑧ INSTALL (N) 2" TYPE 1 CONDUIT
- ⑨ INSTALL (N) 1" TYPE 4 CONDUIT WITH CABLES
- ⑩ INSTALL (N) TYPE 1 JB
- ⑪ (E) 3" CONDUIT
- ⑫ INSTALL (N) CMS PANEL
- ⑬ (E) 20"x20"x8" TYPE 1 JB

Dist	COUNTY	ROUTE	POST MILES TOTAL PROJECT	SHEET No.	TOTAL SHEETS
04	Ala	80	1.99/2.1	95	123

REGISTERED CIVIL ENGINEER

3/12/10  
DATE

PLANS APPROVAL DATE


3/12/10  
DATE

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SUITE 1500  
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BAY AREA TOLL AUTHORITY  
101 EIGHTH STREET  
OAKLAND, CA 94607

REGISTERED PROFESSIONAL ENGINEER  
RAMSEY J. HISEN  
No. C-39608  
Exp. 12/31/10  
CIVIL  
STATE OF CALIFORNIA



NOTES:

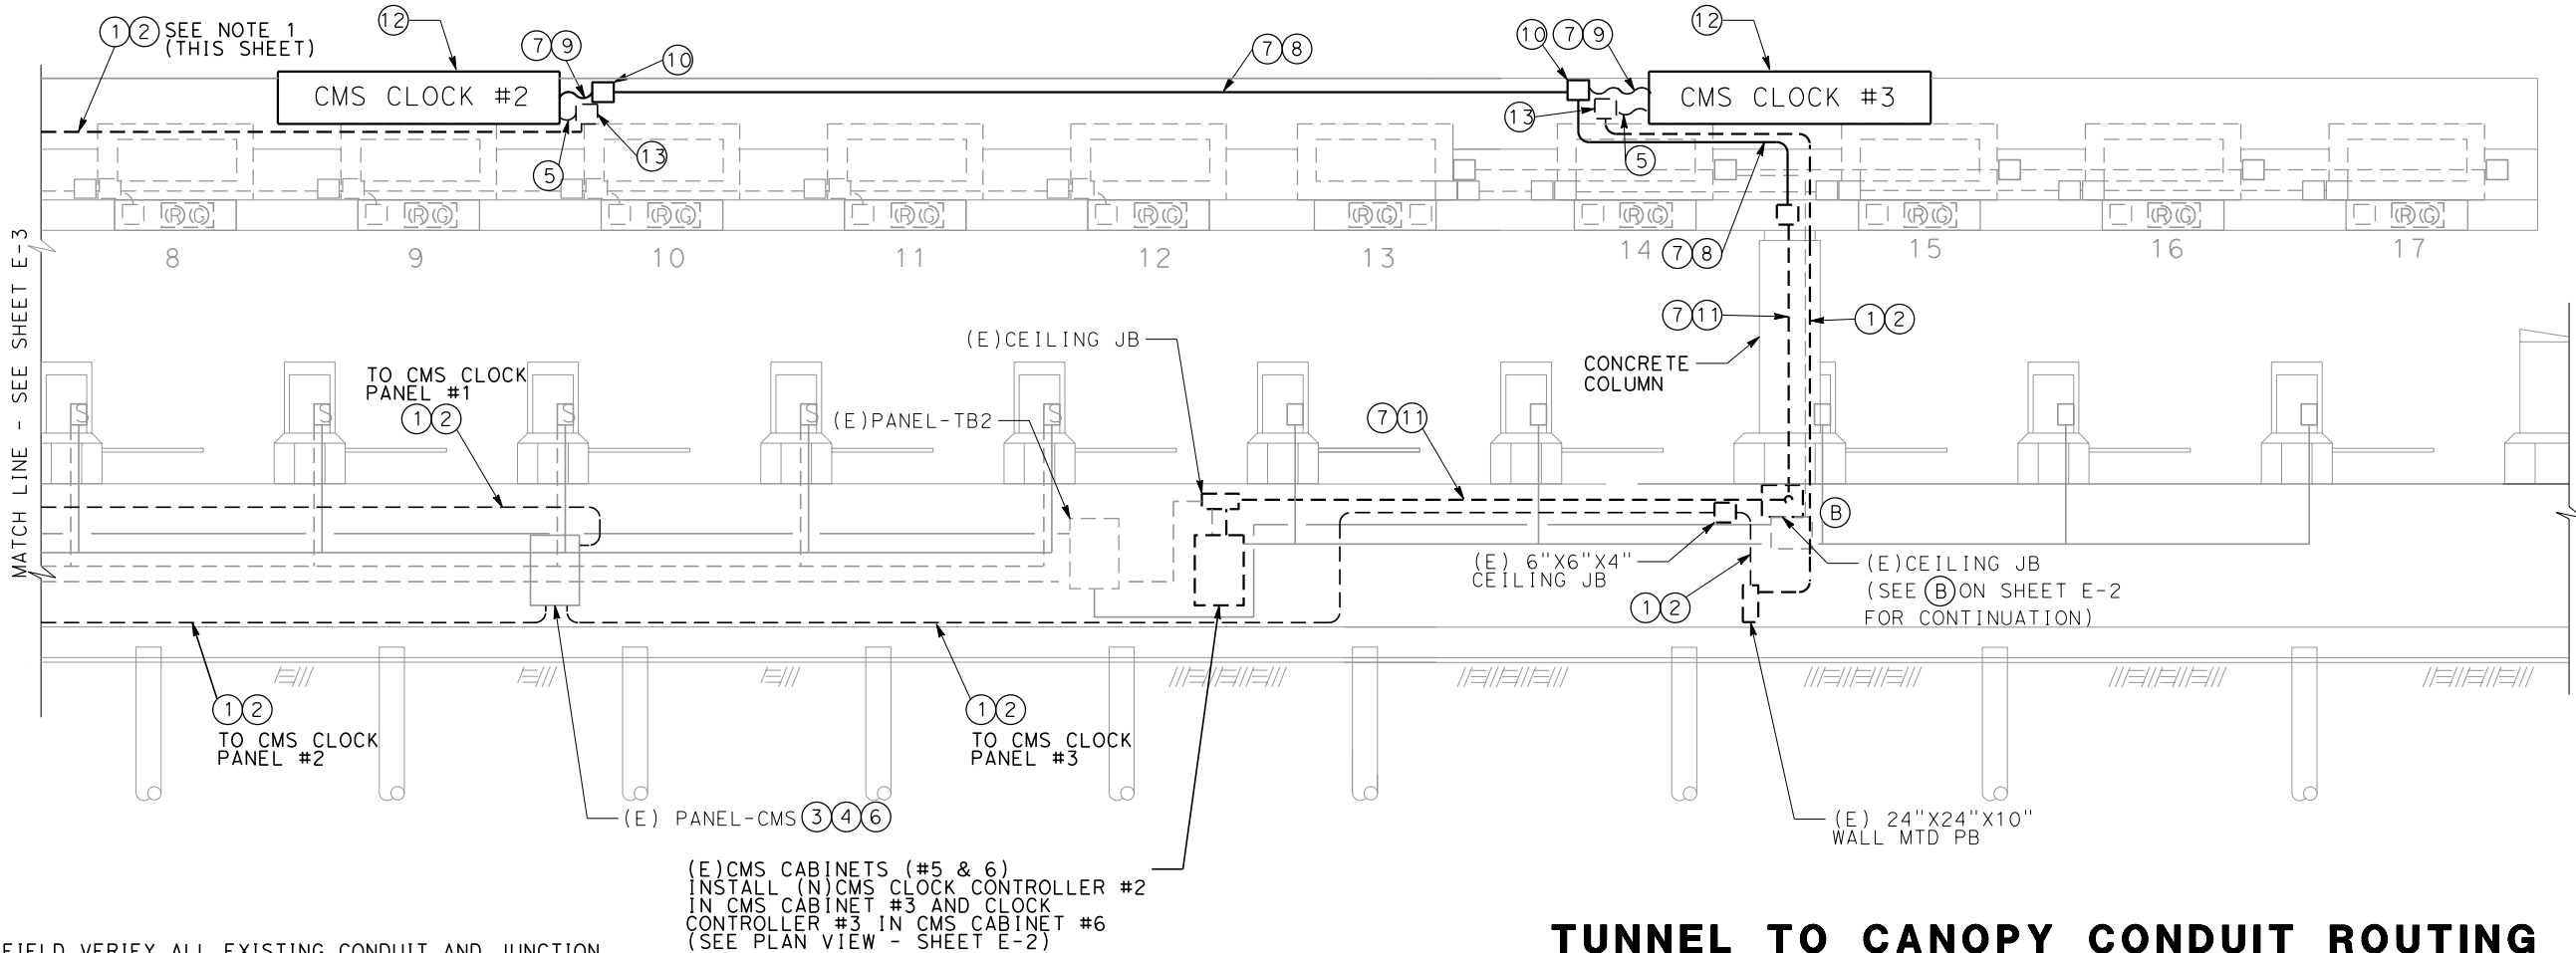1. CONTRACTOR TO FIELD VERIFY ALL EXISTING CONDUIT AND JUNCTION BOXES FOR USE ON THIS PROJECT. CONTRACTOR SHALL PROVIDE AND INSTALL NEW CONDUIT AND JUNCTION BOXES AS NEEDED OR REQUIRED.
2. ALL INSTALLED CMS PANELS ARE TO BE CONNECTED TO THE BUILDING GROUND SYSTEM.

TUNNEL TO CANOPY CONDUIT ROUTING


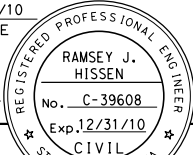
(SHEET 2 OF 2)

(SAN FRANCISCO-OAKLAND BAY BRIDGE)


THIS PLAN ACCURATE FOR ELECTRICAL WORK ONLY

NO SCALE

E-4	
SHEET	OF
4	10

Dist	COUNTY	ROUTE	POST MILES TOTAL PROJECT	SHEET No.	TOTAL SHEETS
04	Ala	80	1.99/2.1	96	123
 REGISTERED CIVIL ENGINEER			3/12/10 DATE		
PLANS APPROVAL DATE					
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BAY AREA TOLL AUTHORITY 101 EIGHTH STREET OAKLAND, CA 94607			URS CORPORATION 55 SOUTH MARKET STREET SUITE 1500 SAN JOSE, CA 95113-2332		

- ## NOTES:
1. INSTALL CMS CLOCK PANEL CONTROLLER #1 IN EXISTING CMS CABINET #4.
  2. ALL CABLING IN CMS CABINETS SHALL BE INSTALLED AND NEATLY DRESSED AND SECURED IN CABINETS.
  3. CONTRACTOR TO INSTALL, CONNECT AND INTEGRATE ALL EQUIPMENT IN CMS CABINETS.
  4. SEE SHEET E-2 FOR CMS CABINET LOCATIONS.
  5. ALL CMS CONTROLLERS TO BE NUMBERED WITH 1.X THROUGH 1.XX (WHERE X=LANE #)

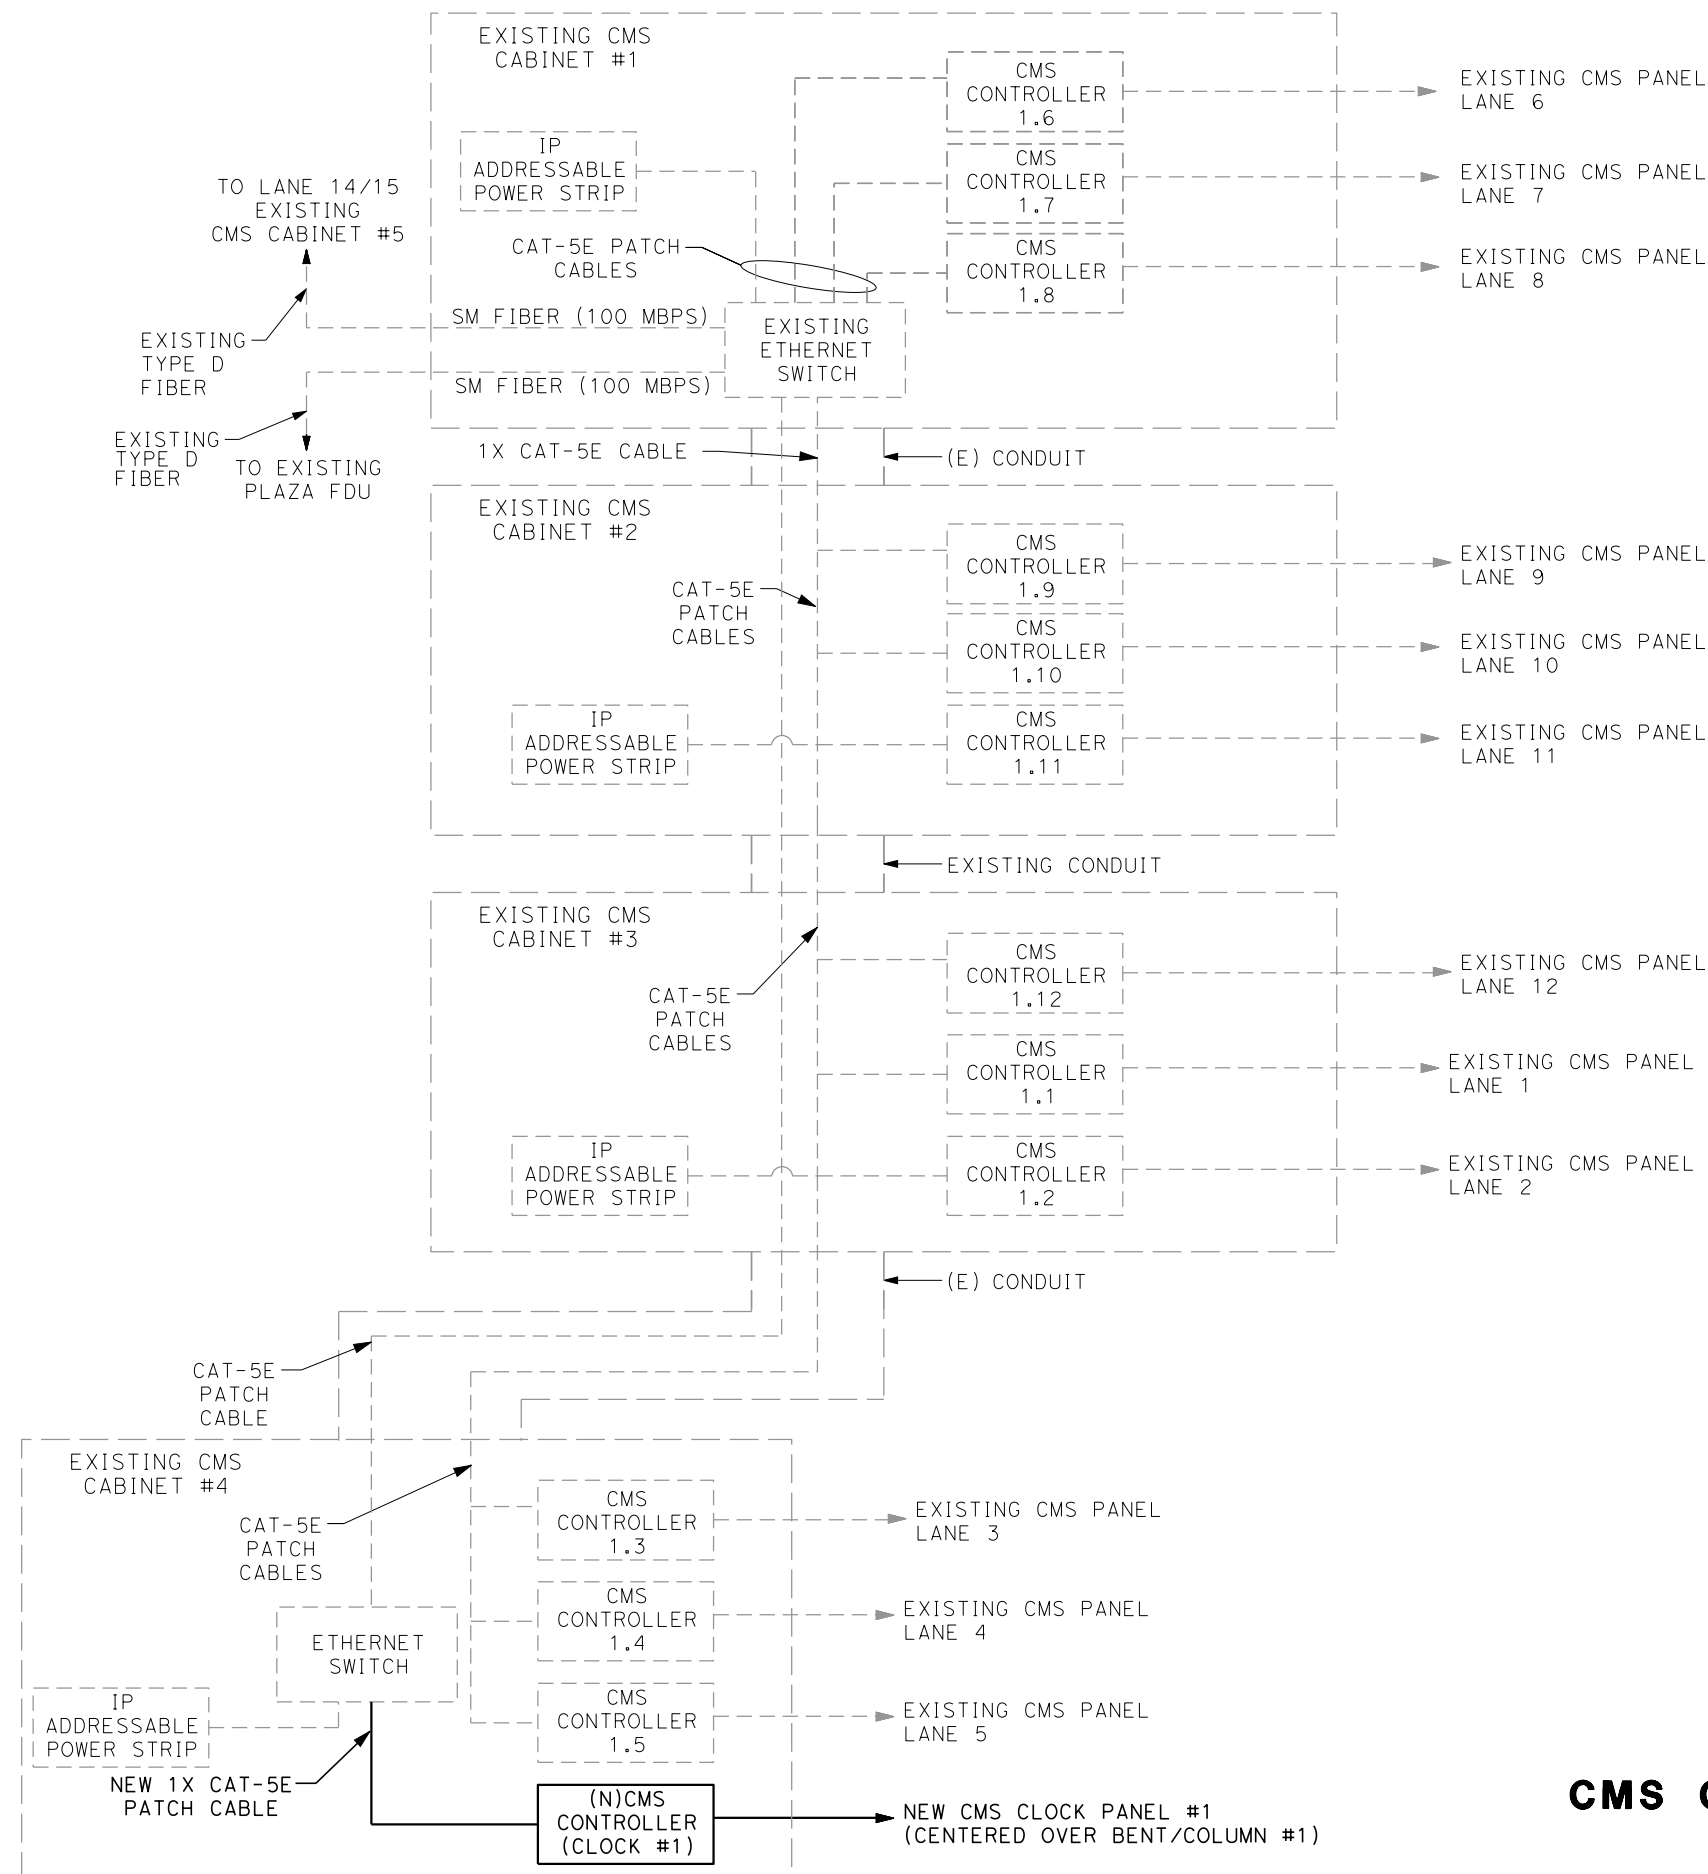

## CMS CLOCK (PANEL #1) SYSTEM SCHEMATIC

### (SAN FRANCISCO-OAKLAND BAY BRIDGE)

E-5

SHEET	OF
5	10

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NO SCALE

BORDER LAST REVISED 4/11/2008

RELATIVE BORDER SCALE  
IS IN INCHES



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DGN FILE=> $FILE$

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EA TBD (BATA-0006)

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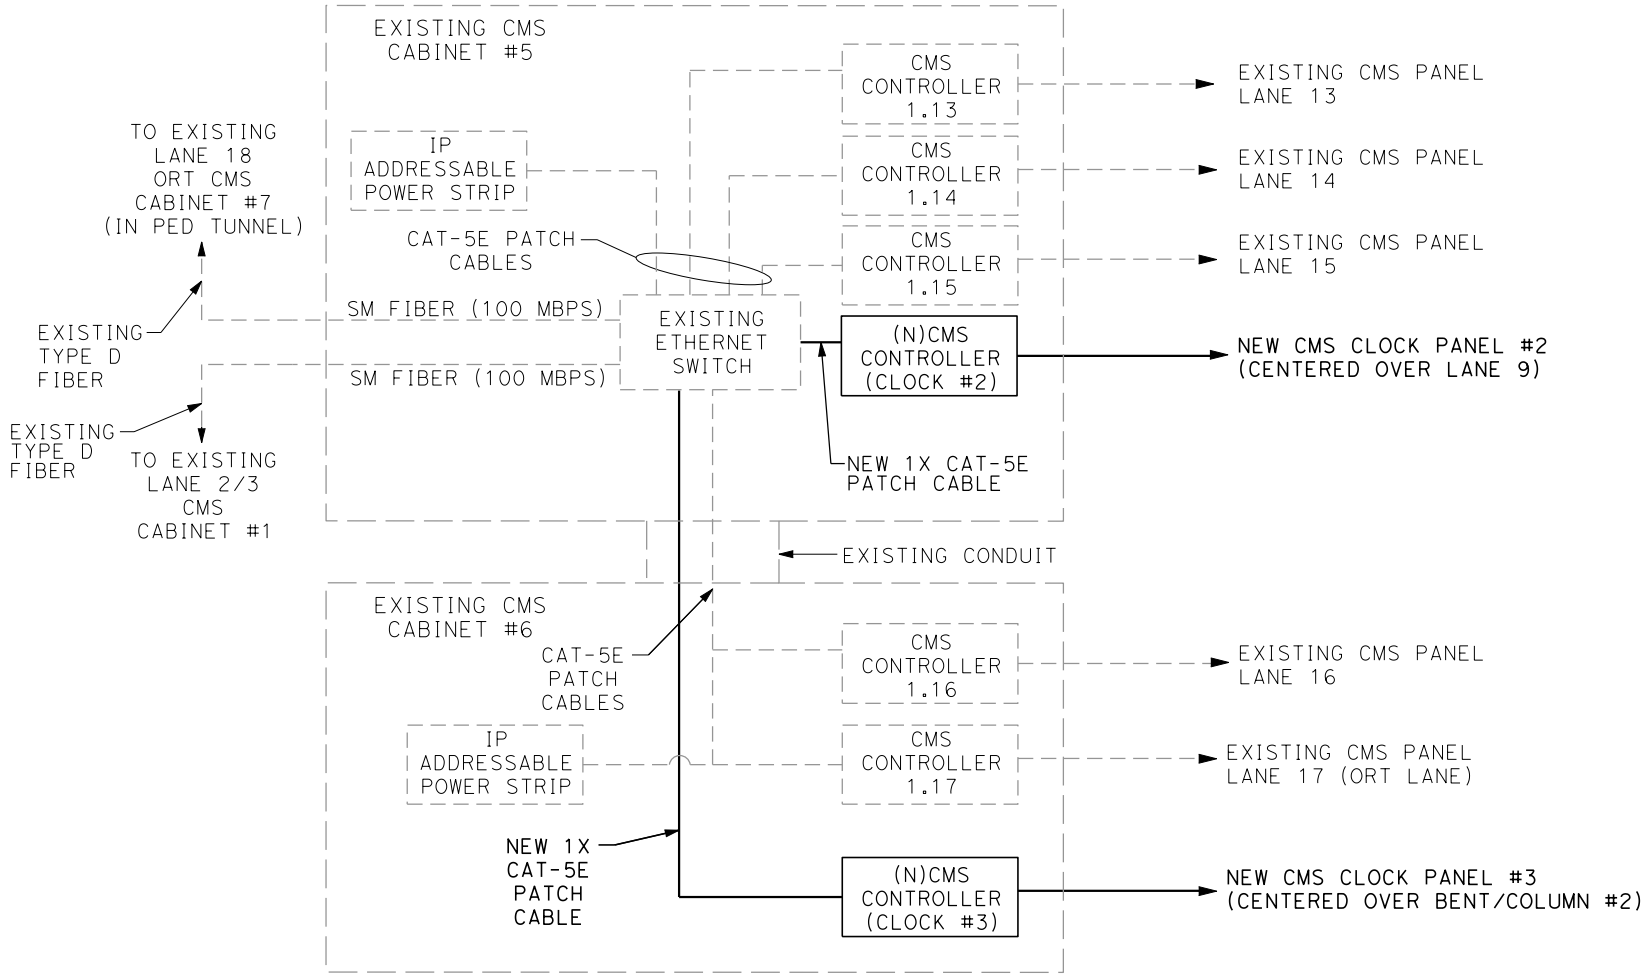
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STATE OF CALIFORNIA - DEPARTMENT OF TRANSPORTATION	CONSULTANT FUNCTIONAL SUPERVISOR				
<b>Caltrans</b>	LARRY JONES	CALCULATED-DESIGNED BY	REVISED BY		
		CHECKED BY	DATE REVISED		





- NOTES:**
1. INSTALL CMS CLOCK PANEL CONTROLLERS 2 & 3 IN EXISTING CMS CABINET #6.
  2. ALL CABLING IN CMS CABINETS SHALL BE INSTALLED AND NEATLY DRESSED AND SECURED IN CABINETS.
  3. CONTRACTOR TO INSTALL, CONNECT, AND INTEGRATE ALL EQUIPMENT IN CMS CABINETS.
  4. SEE SHEET E-2 FOR CMS CABINET LOCATIONS.
  5. ALL CMS CONTROLLERS TO BE NUMBERED WITH 1.X THROUGH 1.XX (WHERE X = LANE #)

**CMS CLOCK (PANELS 2 AND 3) SYSTEM SCHEMATIC**  
**(SAN FRANCISCO-OAKLAND BAY BRIDGE)**

**E-6**

THIS PLAN ACCURATE FOR ELECTRICAL WORK ONLY

NO SCALE

Dist	COUNTY	ROUTE	POST MILES TOTAL PROJECT	SHEET No.	TOTAL SHEETS
04	Ala	80	1.99/2.1	97	123

REGISTERED CIVIL ENGINEER

3/12/10  
DATE


PLANS APPROVAL DATE

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55 SOUTH MARKET STREET  
SUITE 1500  
SAN JOSE, CA 95113-2332

BAY AREA TOLL AUTHORITY  
101 EIGHTH STREET  
OAKLAND, CA 94607



REGISTERED PROFESSIONAL ENGINEER  
RAMSEY J. HISSSEN  
No. C-39608  
Exp. 12/31/10  
CIVIL  
STATE OF CALIFORNIA

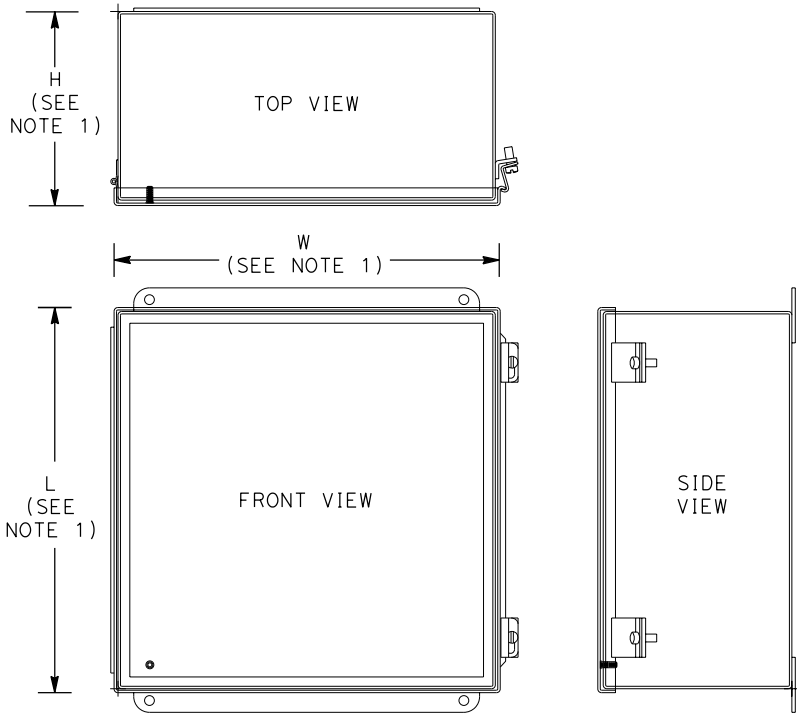

NEMA 4X JUNCTION BOX  
(SHOWN WITH HINGE)

NOTES:

1. TYPE 1 NEMA 4X JUNCTION BOX (12"L X 12"W X 6"D, TYP.) OR AS REQ'D.  
TYPE 3 NEMA 4X JUNCTION BOX (5"L X 6"W X 4"D, TYP.) OR AS REQ'D.
2. MINIMUM SIZES OF JUNCTION BOXES SHOWN. CONTRACTOR SHALL CONFIRM SIZES AND QUANTITIES IN FIELD AND SUBMIT SHOP DRAWINGS TO ENGINEER FOR APPROVAL.
3. FOR JUNCTION BOX MOUNTED ON EXISTING CONCRETE WALLS OR SURFACE FLOR MOUNTED USE 3/8" EXPANSION ANCHORS, TOTAL OF 4 FOR EACH BOX.

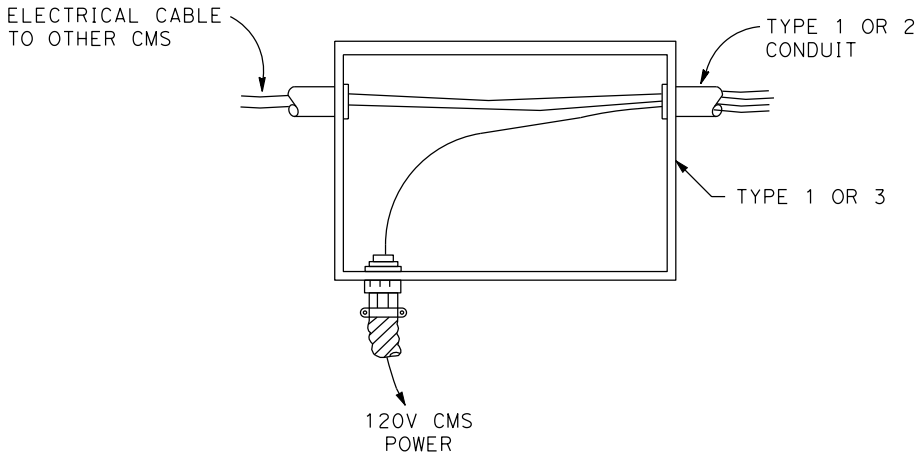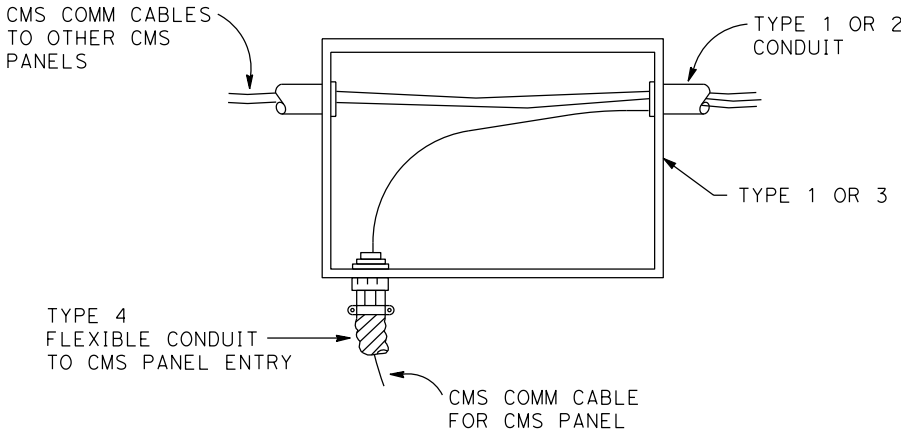


JUNCTION BOX DETAILS (TYPICAL)  
(SAN FRANCISCO-OAKLAND BAY BRIDGE)

E-7

THIS PLAN ACCURATE FOR ELECTRICAL WORK ONLY

NO SCALE

Dist	COUNTY	ROUTE	POST MILES TOTAL PROJECT	SHEET No.	TOTAL SHEETS
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REGISTERED CIVIL ENGINEER

3/12/10  
DATE

PLANS APPROVAL DATE


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OAKLAND, CA 94607

URS CORPORATION  
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SUITE 1500  
SAN JOSE, CA 95113-2332

REGISTERED PROFESSIONAL ENGINEER  
RAMSEY J. HISSSEN  
No. C-39608  
Exp. 12/31/10  
CIVIL  
STATE OF CALIFORNIA



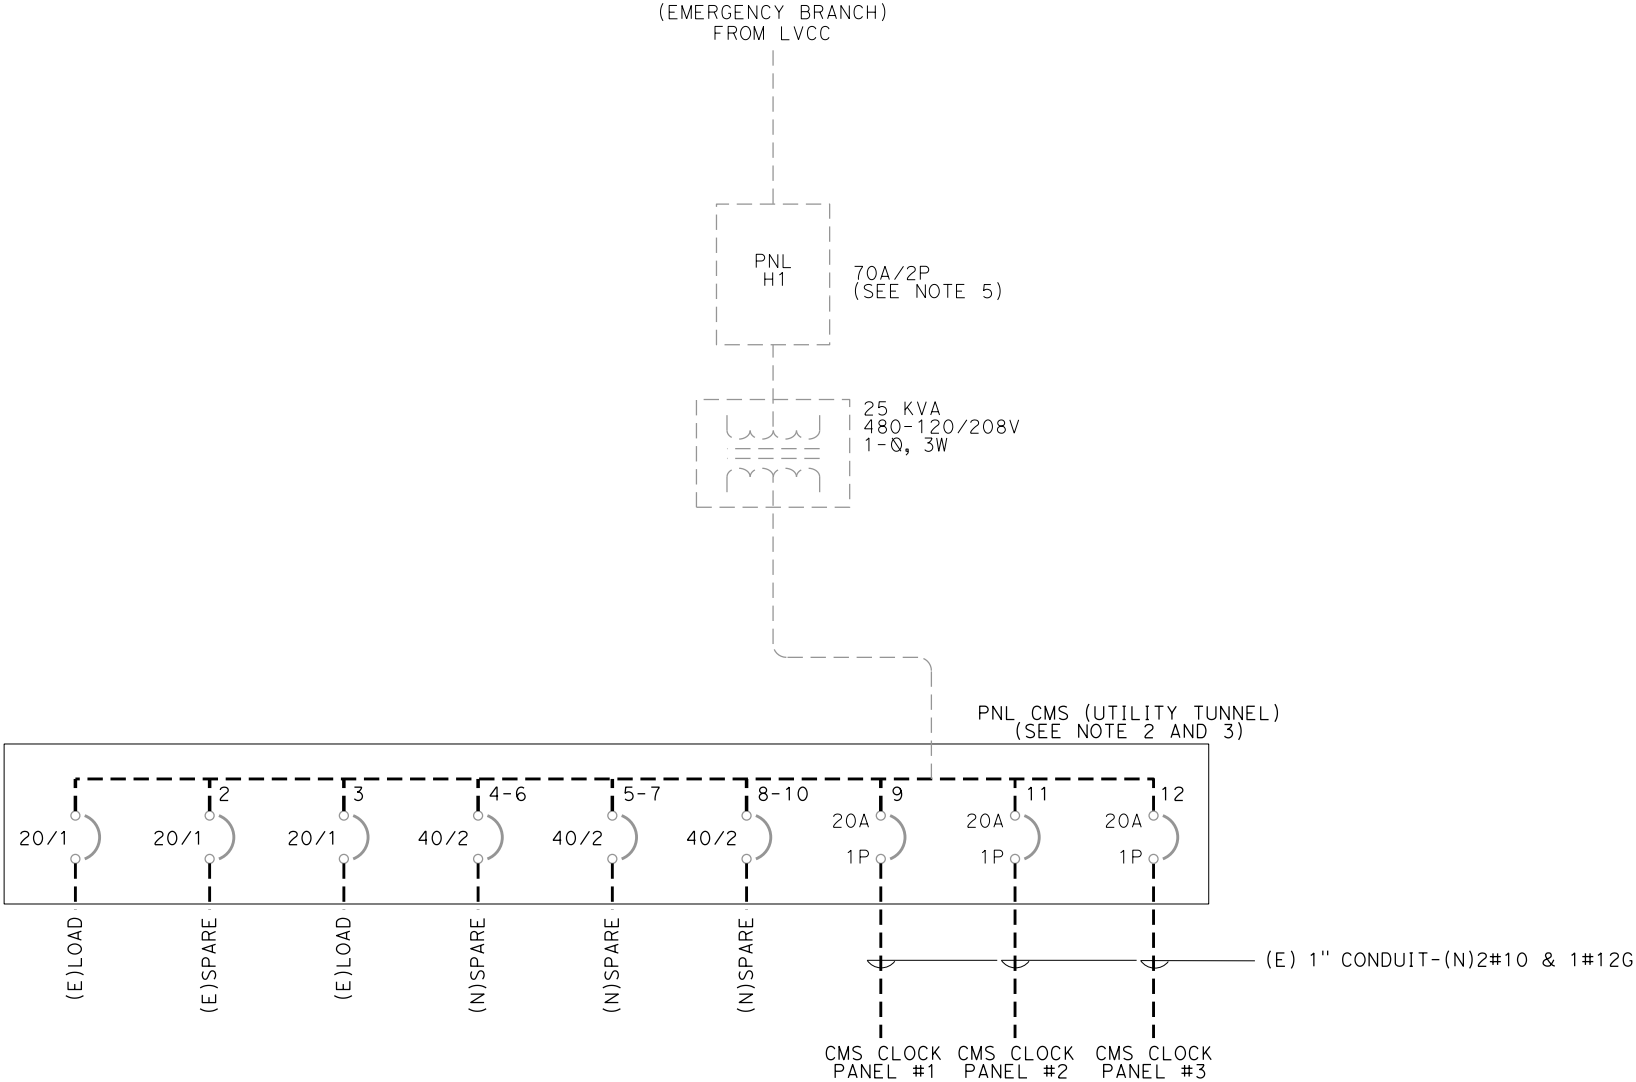

- NOTES:**
- 1. ONE (E) 20A CIRCUIT BREAKER FOR EACH CMS CLOCK PANEL.
  - 2. SEE CMS PANEL SCHEDULE (SHEET E-10) FOR MORE INFORMATION.
  - 3. PROVIDE NEW REVISED (TYPE-WRITTEN) PANEL SCHEDULE.
  - 4. SEE SHEET E-2 FOR ELECTRICAL PANEL LOCATION.
  - 5. CONTRACTOR TO FIELD VERIFY AND PROVIDE GROUNDING TO BUILDING GROUNDING SYSTEM PER CODE FROM PNL H1 TO PNL CMS AS REQUIRED OR NEEDED.
  - 6. ALL METAL PARTS OF THE ELECTRICAL SYSTEM SHALL BE BONDED TOGETHER PER CONTRACT SPECIFICATIONS.
  - 7. THE CMS PANELS SHALL BE CONNECTED TO THE BUILDING GROUNDING SYSTEM BY THE EQUIPMENT/PANEL GROUND CONDUCTOR IN EACH CONDUIT.

**PARTIAL ONE LINE DIAGRAM**  
**(SAN FRANCISCO-OAKLAND BAY BRIDGE) E-9**

NO SCALE

Dist	COUNTY	ROUTE	POST MILES TOTAL PROJECT	SHEET No.	TOTAL SHEETS
04	Ala	80	1.99/2.1	100	123
REGISTERED CIVIL ENGINEER			3/12/10 DATE	<div><div>REGISTERED PROFESSIONAL ENGINEER</div><div>CAROL LIGHT</div><div>No. 10145</div><div>Exp. 09/30/11</div><div>ELECTRICAL</div><div>STATE OF CALIFORNIA</div></div>	
PLANS APPROVAL DATE					
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BAY AREA TOLL AUTHORITY 101 EIGHTH STREET OAKLAND, CA 94607			URS CORPORATION 55 SOUTH MARKET STREET SUITE 1500 SAN JOSE, CA 95113-2332		

PROJECT: SFOBB												(E) PNL- CMS												LOCATION: UTILITY TUNNEL											
																								(FED FROM PANEL- H1 VIA 25KVA XMFR)											
LOAD DESCRIPTION				LTG.	G.P. REC	OTH.	CB						CB		LTG.	G.P. REC	OTH.	LOAD DESCRIPTION																	
							AMP	POLE					AMP	POLE																					
(E) LOAD							20	1	1	A	2	20	1					(E) SPARE																	
(E) LOAD							20	1	3	B	4	40						(N) SPARE																	
(N) SPARE							40		5	A	6		2																						
								2	7	B	8	40						(N) SPARE																	
(N) CMS CLOCK PANEL # 1						1.00	20	1	9	A	10		2																						
(N) CMS CLOCK PANEL # 2						1.00	20	1	11	B	12	20	1				1.00	(N) CMS CLOCK PANEL #3																	
TOTALS SECTION 1				0.00	0.00	2.00											0.00	0.00	1.00																
VOLTAGE: 120/240V  PHASE/WIRE: 1 PHASE, 3 WIRE  RATING:   MAINS: 225A-2P  MOUNTING: SURFACE  A.I.C.:   BUS SIZE:				LOAD SUMMARY								ADDITIONAL FEATURES:																							
				CONNECT LOAD		DEMAND FACTOR		DEMAND LOAD		BALANCE:										(KVA)	%	AMPS:													
										PHASE A:										1.00	33.33	4.81													
										PHASE B:										2.00	66.67	9.62													
										0.00										125% OF LOAD		0.00													
										0.00										NEC 220-13		0.00													
										3.00										1.00		3.00													
										3.00										KVA		3.00 KVA													
										12.5										AMPS		12.5 AMPS													

- NOTES:
- CONTRACTOR TO UPDATE BREAKER PANEL BOARD SCHEDULE AND PROVIDE A NEW REVISED TYPE-WRITTEN PANEL BOARD SCHEDULE.
  - SEAL ALL OPEN BREAKER SPACES AS DIRECTED BY ENGINEER.

PNL CMS PANELBOARD SCHEDULE  
(SAN FRANCISCO-OAKLAND BAY BRIDGE)

E-10

NO SCALE

Dist	COUNTY	ROUTE	POST MILES TOTAL PROJECT	SHEET No.	TOTAL SHEETS
04	Ala	80	1.99/2.1	101	123
<div>Carol Light REGISTERED CIVIL ENGINEER</div>			3/12/10 DATE	<div>REGISTERED PROFESSIONAL ENGINEER CAROL LIGHT No. 10145 Exp. 09/30/11 ELECTRICAL STATE OF CALIFORNIA</div>	
PLANS APPROVAL DATE					
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DIST	COUNTY	ROUTE	POST MILES TOTAL PROJECT	SHEET No	TOTAL SHEETS
04	Ala	92	R2.59	102	123

REGISTERED CIVIL ENGINEER

DATE

3/12/10

GUOPING XU

No. C 63977

Exp. 09/30/10

CIVIL


STATE OF CALIFORNIA

PLANS APPROVAL DATE


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OAKLAND, CALIFORNIA 94607


MGE ENGINEERING, INC.  
7415 GREENHAVEN DRIVE, SUITE 100  
SACRAMENTO, CALIFORNIA 95831

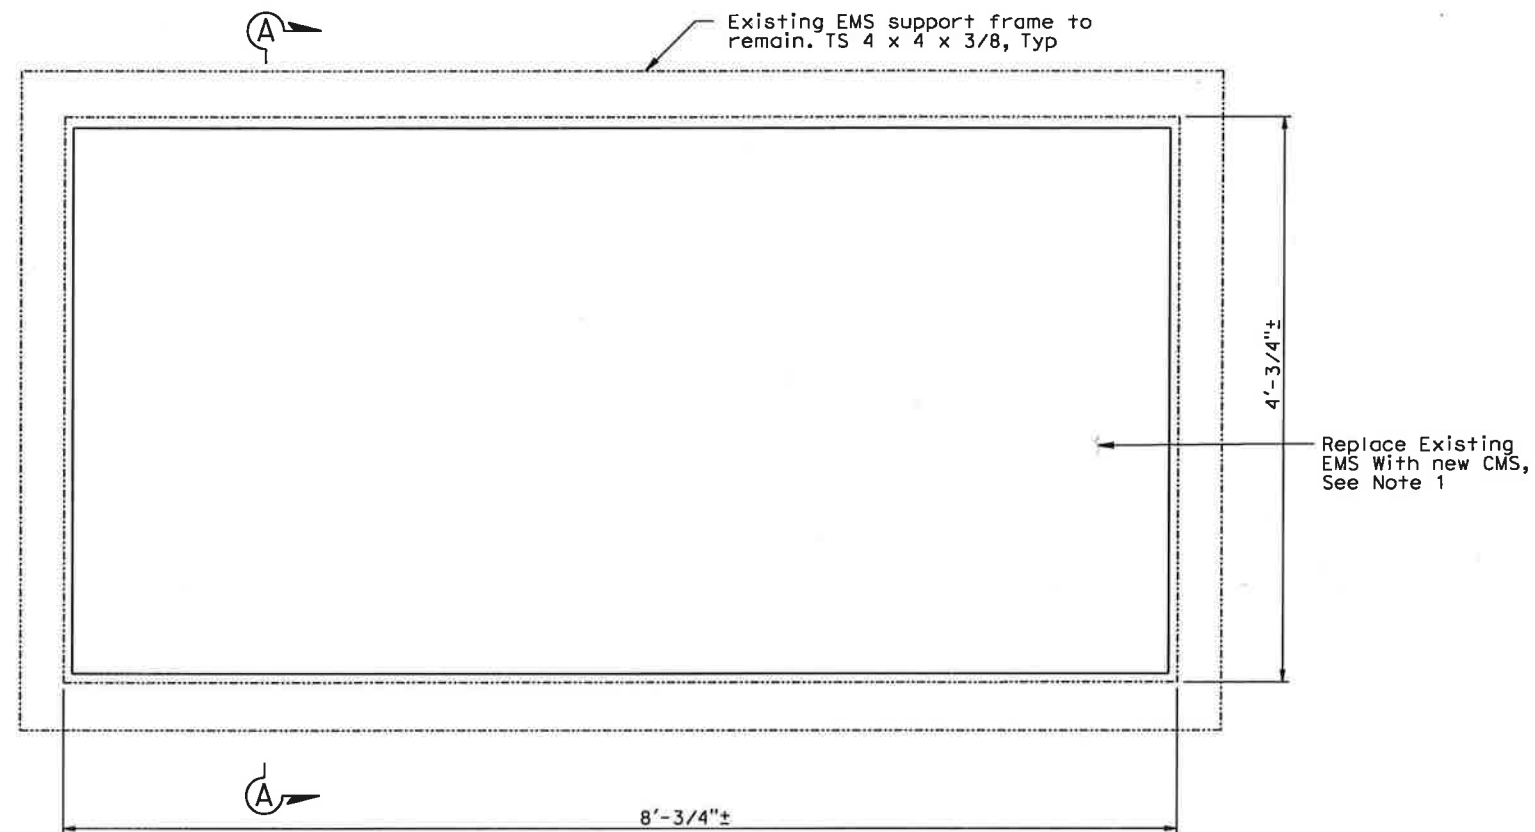


**CMS SUPPORT ELEVATION**  
SCALE: 1 1/2" = 1'-0"

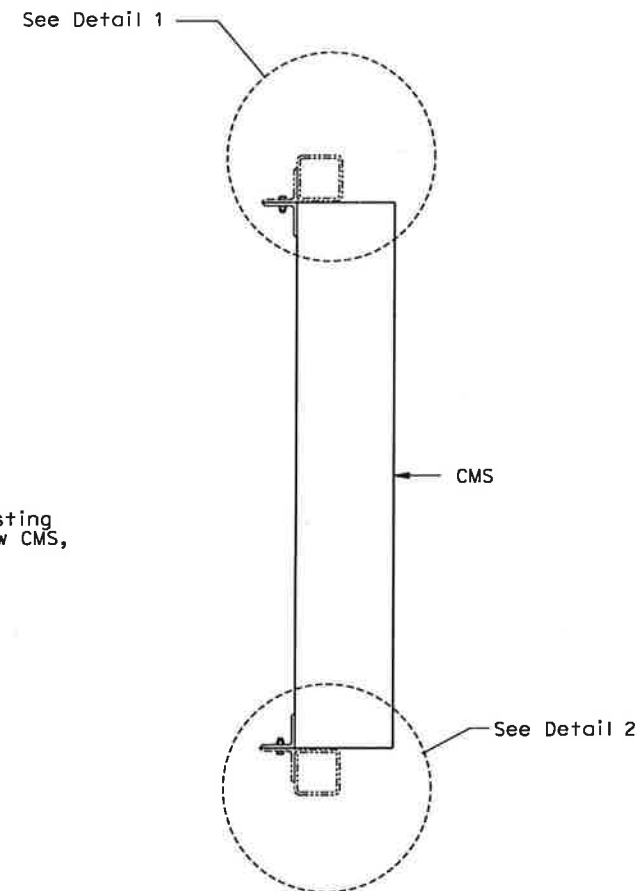

**SECTION A-A**  
SCALE: 1 1/2" = 1'-0"

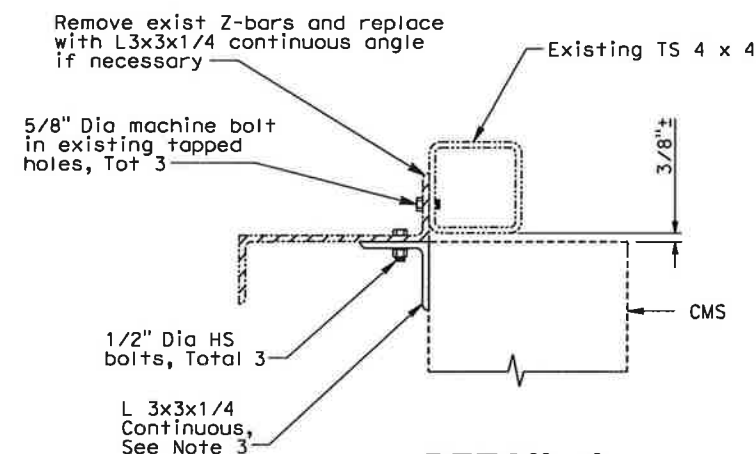

**DETAIL 1**  
SCALE: 3" = 1'-0"

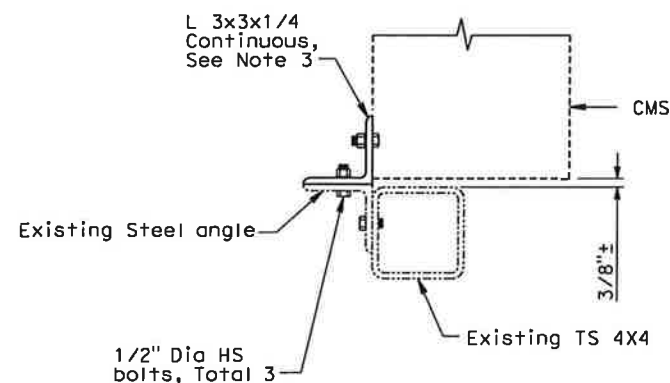

**DETAIL 2**  
SCALE: 3" = 1'-0"

**Notes:**

1. For location and number of CMS panels, see sheet L-13.
2. CMS manufacturer shall verify dimensions of existing EMS connection details.
3. This angle to be prefabricated as part of CMS by CMS manufacturer.
4. All bolts, washers and lock nuts shall be of stainless steel or galvanized.
5. Install CMS in Toll Canopy Booths 6 & 7 (2).

**Legend:**


- Indicates New Structure
- - - Indicates Exist Structure
- ▨ Indicates removal of portion of Exist frame

Note:  
The Contractor shall verify all controlling field dimensions before ordering or fabricating any material.


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SIGN OFF DATE	DETAILS BY E. Garnica	CHECKED			POST MILE	TYPICAL CANOPY CMS INSTALLATION		S-1
DESIGN DETAIL SHEET (ENGLISH) (REV. 2/25/05)	QUANTITIES BY	CHECKED			R2.59			OF
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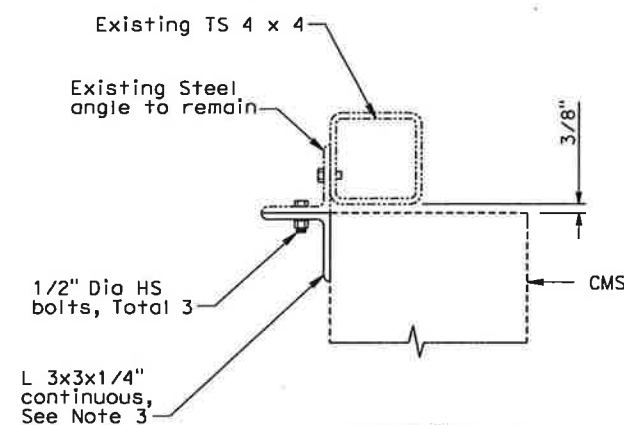
DIST	COUNTY	ROUTE	POST MILES TOTAL PROJECT	SHEET No	TOTAL SHEETS
04	Ala	92	R2.59	103	123
REGISTERED CIVIL ENGINEER			DATE	3/12/10	
PLANS APPROVAL DATE					
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MGE ENGINEERING, INC. 7415 GREENHAVEN DRIVE, SUITE 100 SACRAMENTO, CALIFORNIA 95831					



**CMS SUPPORT ELEVATION**  
SCALE: 1 1/2" = 1'-0"

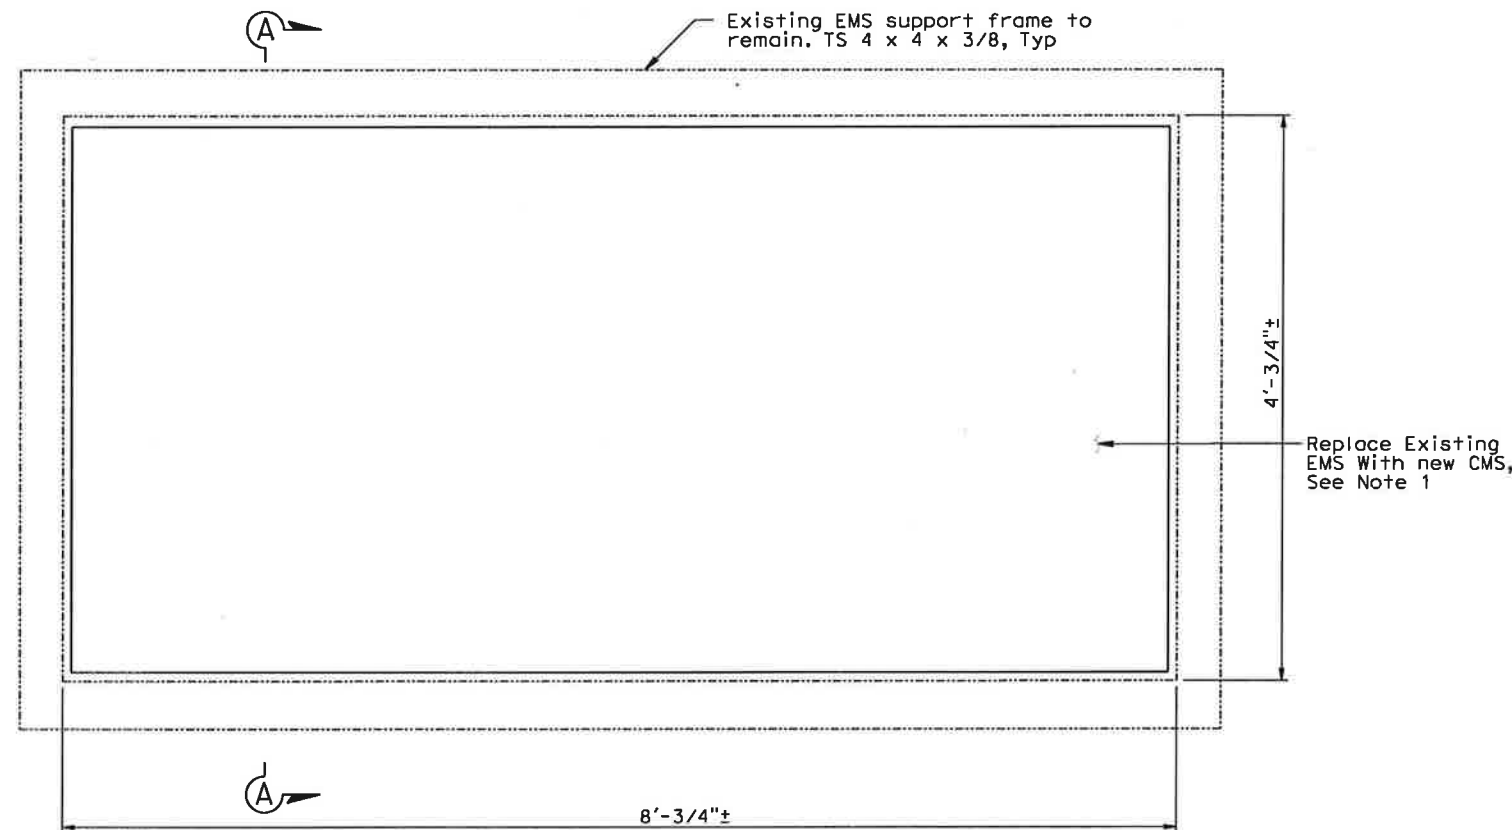

**SECTION A-A**  
SCALE: 1 1/2" = 1'-0"

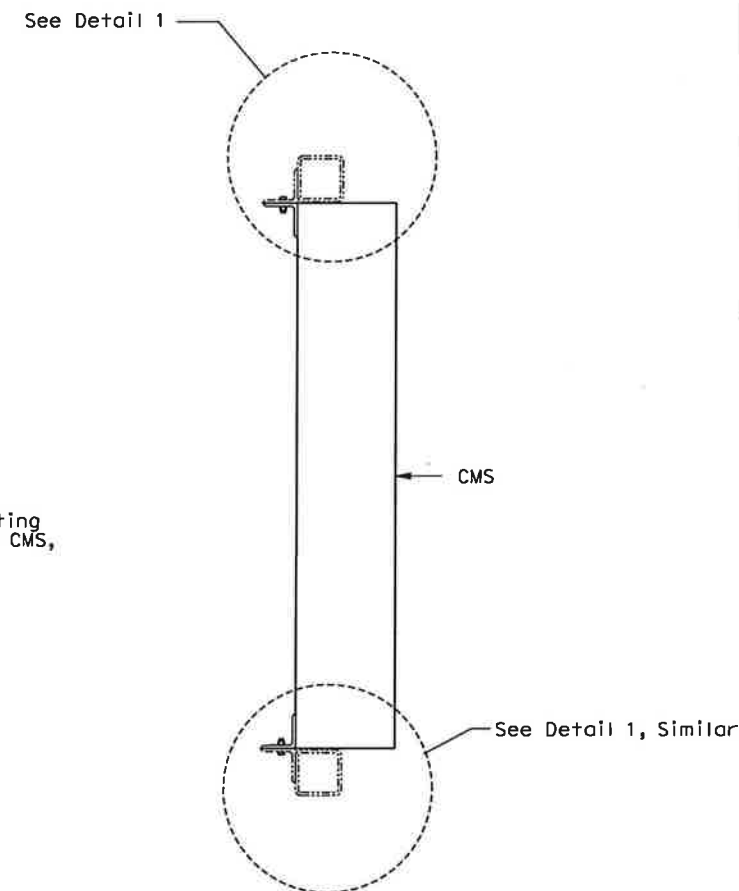

**DETAIL 1**  
SCALE: 3" = 1'-0"

**Notes:**

1. For location and number of CMS panels, see sheet L-13.
2. CMS manufacturer shall verify dimensions of existing EMS and connection details.
3. This angle to be prefabricated by CMS Manufacturer and bolted CMS Casing.
4. Install CMS in Toll Canopy Booths 8-10 (3).

**Legend:**

- Indicates New Structure  
--- Indicates Exist Structure

Note:  
The Contractor shall verify all  
controlling field dimensions before  
ordering or fabricating any material.

DESIGN OVERSIGHT	DESIGN BY G. Xu	CHECKED	PREPARED FOR THE STATE OF CALIFORNIA DEPARTMENT OF TRANSPORTATION	Guoping Xu PROJECT ENGINEER	BRIDGE NO.	SAN MATEO-HAYWARD MINI TOLL PLAZA		SHEET
SIGN OFF DATE	DETAILS BY E. Gornica	CHECKED			POST MILE	TYPICAL CANOPY CMS INSTALLATION		S-2
DESIGN DETAIL SHEET (ENGLISH) (REV. 2/25/05)	QUANTITIES BY	CHECKED			R2.59			
ORIGINAL SCALE IN INCHES FOR REDUCED PLANS				CU EA	DISREGARD PRINTS BEARING EARLIER REVISION DATES			
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					03/12/10			
					2 2			

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x

#REQUEST

STATE OF CALIFORNIA - DEPARTMENT OF TRANSPORTATION




CALCULATED-  
DESIGNED BY

CHECKED BY

REVISED BY

DATE REVISED

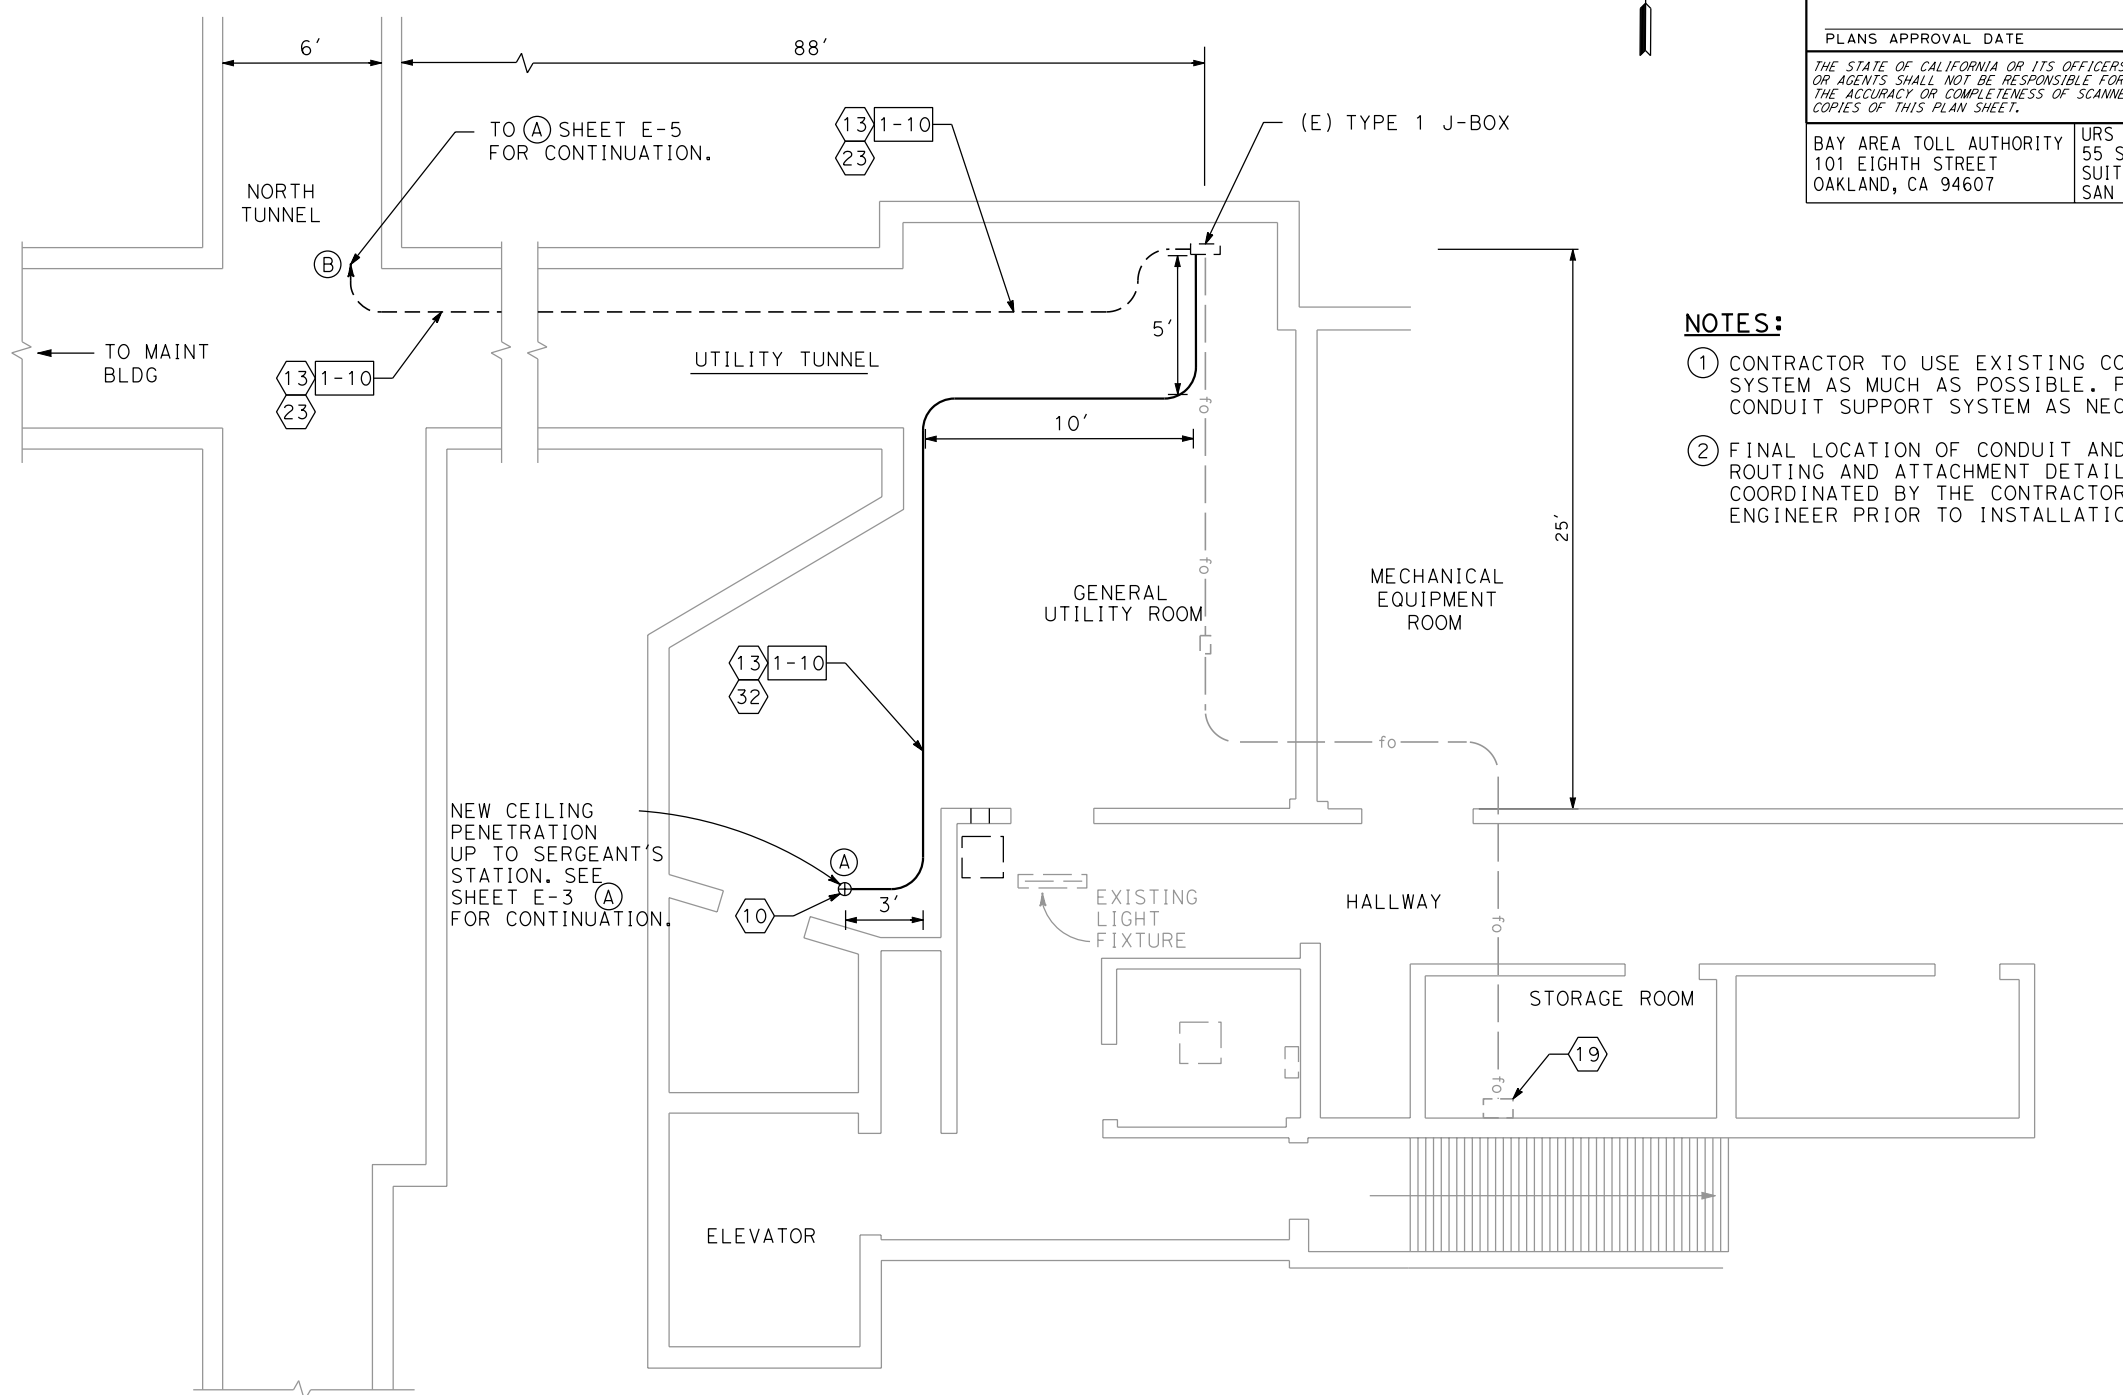

PLAN

TOLL PLAZA OPERATIONS BUILDING  
LOWER LEVEL CONDUIT ROUTING  
(SAN MATEO - HAYWARD BRIDGE)

NO SCALE

E-4

SHEET	OF
4	20

Dist	COUNTY	ROUTE	POST MILES TOTAL PROJECT	SHEET NO.	TOTAL SHEETS
04	Ala	92	R2.59	107	123

REGISTERED CIVIL ENGINEER

3/12/10  
DATE

PLANS APPROVAL DATE

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REGISTERED PROFESSIONAL ENGINEER  
RAMSEY J. HISSEN  
No. C-39608  
Exp. 12/31/10  
CIVIL  
STATE OF CALIFORNIA

BAY AREA TOLL AUTHORITY 101 EIGHTH STREET OAKLAND, CA 94607	URS CORPORATION 55 S. MARKET STREET SUITE 1500 SAN JOSE, CA 95113
---	--

- NOTES:
- 1 CONTRACTOR TO USE EXISTING CONDUIT SUPPORT SYSTEM AS MUCH AS POSSIBLE. PROVIDE NEW CONDUIT SUPPORT SYSTEM AS NECESSARY.
  - 2 FINAL LOCATION OF CONDUIT AND JUNCTION BOX ROUTING AND ATTACHMENT DETAILS SHALL BE COORDINATED BY THE CONTRACTOR WITH THE ENGINEER PRIOR TO INSTALLATION.







ITEM	COMPONENT
①	NEW CMS CONTROLLERS
②	NEW 14-PORT RACK MOUNTABLE ETHERNET SWITCH WITH 2 FIBER PORTS.
③	NEW FIBER PATCH PANEL
④	NEW RACK MOUNTABLE IP ADDRESSABLE POWER STRIP
⑤	ONE (1) NEW PANEL MOUNT 1/2 AMP PUSH BUTTON BREAKER (120 VAC)
⑥	NEW ELECTRICAL PANEL

ITEM	COMPONENT
⑦	ONE (1) NEW 2 AMP BREAKER (120 VAC)
⑧	NEW 15 AMP GFI OUTLET
⑨	ONE (1) NEW NEC CLASS 3, 100 WATT 1:1, 120 VAC TRANSFORMER
⑩	INSTALL NEW PULL OUT DRAWER FOR WIRING OF NEW INDICATOR LIGHT RELAYS. SEE SHEET E-20 FOR CABINET DRAWER LAYOUT.
⑪	ONE (1) NEW PANEL MOUNT DPDT TOGGLE SWITCH
⑫	NEW PANEL MOUNT BLUE LED INDICATOR LIGHT (120VAC) FOR POWER INDICATION

SHEET NOTES:

- CONTRACTOR TO ROUTE NEW CONDUITS BEHIND EXISTING CABINETS AND PROVIDE CONDUIT SUPPORTS.
- REMOVE AND SCRAP (E) EMS DIMMING CONTROL CABLES BACK TO (E) MINI TOLL PLAZA CABINET #2.
- EXISTING TYPE 2 (1½" C) CONDUIT WITH 6 #12 & 3 #12G (120V, CMS SIGN POWER), TO (E) PANEL-Q.
- ALL CABLING IN CMS CABINETS SHALL BE INSTALLED AND NEATLY DRESSED AND SECURED IN CABINETS. SPARE COILED CABLING SHALL BE PROVIDED IN JUNCTION BOXES.
- CONTRACTOR TO INSTALL, CONNECT, AND INTEGRATE ALL EQUIPMENT IN CMS CABINETS (I.E., TRANSFORMERS, BREAKERS, ETC.).
- CABINET AND EQUIPMENT TO MEET CALTRANS TEES REQUIREMENTS.
- DO NOT CONNECT POWER STRIP TO GFI. CONNECT TO CABINET POWER SOURCE DIRECTLY BY MEANS OF A SEPARATE NEMA 5-15 SOCKET.
- CONTRACTOR TO LEAVE ONE (1) RACK UNIT OF SPACE AT BOTTOM OF CABINET.

Dist	COUNTY	ROUTE	POST MILES TOTAL PROJECT	SHEET NO.	TOTAL SHEETS
04	Ala	92	R2.59	111	123

REGISTERED CIVIL ENGINEER

3/12/10  
DATE


RAMSEY J. HISSON  
No. C-39608  
Exp. 12/31/10  
CIVIL  
STATE OF CALIFORNIA

PLANS APPROVAL DATE

THE STATE OF CALIFORNIA OR ITS OFFICERS OR AGENTS SHALL NOT BE RESPONSIBLE FOR THE ACCURACY OR COMPLETENESS OF SCANNED COPIES OF THIS PLAN SHEET.

BAY AREA TOLL AUTHORITY  
101 EIGHTH STREET  
OAKLAND, CA 94607

URS CORPORATION  
55 S. MARKET STREET  
SUITE 1500  
SAN JOSE, CA 95113

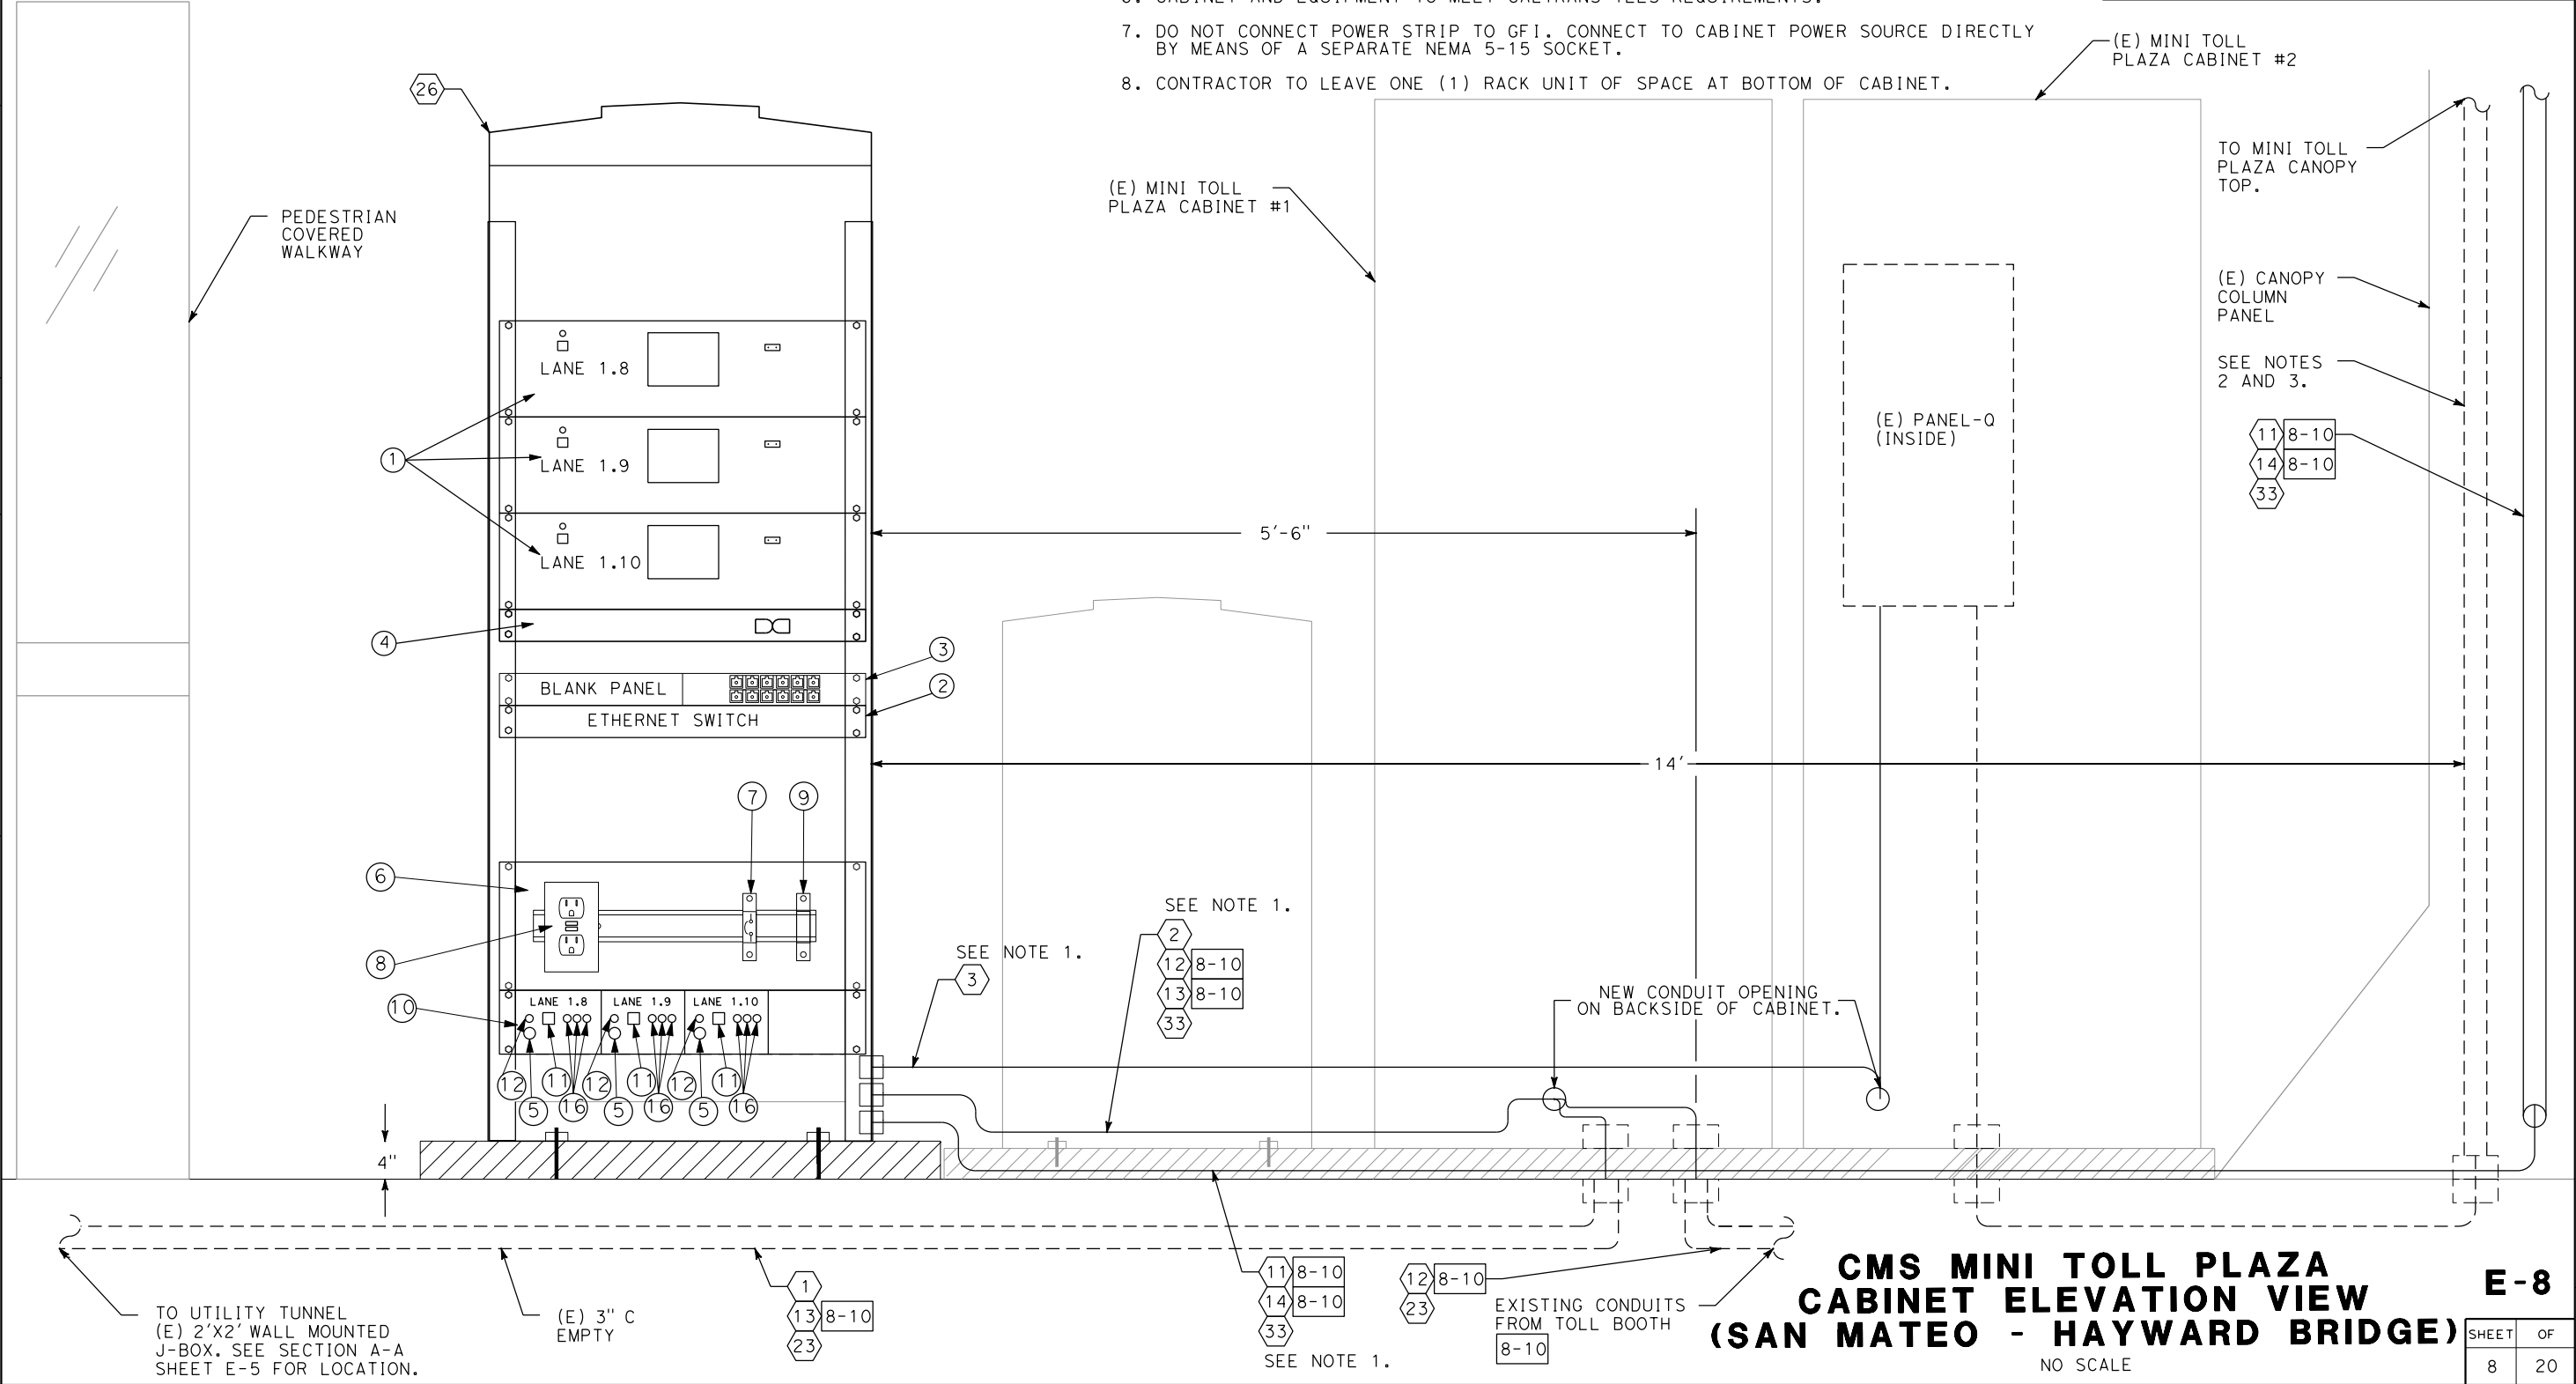







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\$#REQUEST

STATE OF CALIFORNIA - DEPARTMENT OF TRANSPORTATION



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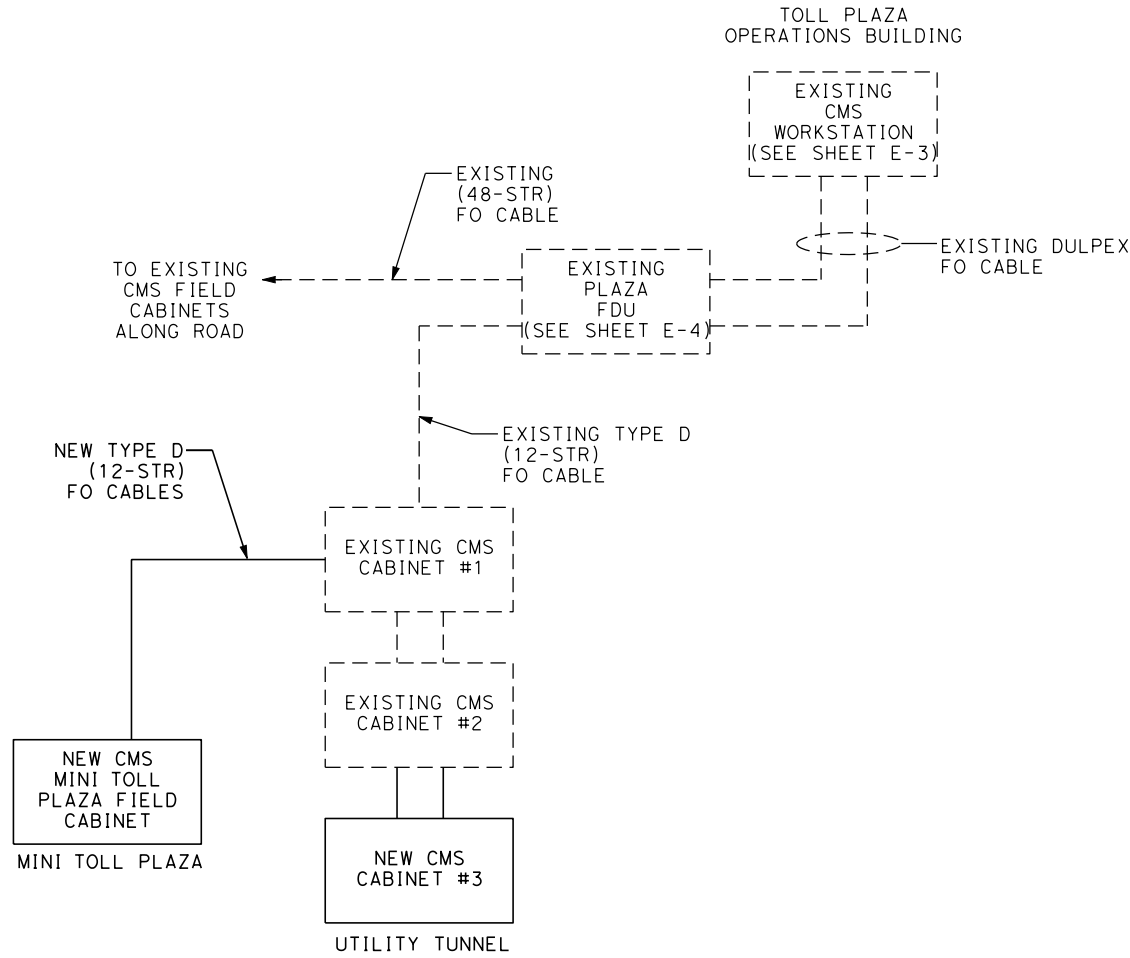
CONSULTANT FUNCTIONAL SUPERVISOR

REVISED BY


DATE REVISED

BORDER LAST REVISED 2/1/2008

DETAIL A: CMS SYSTEM FIBER CABLE PLAN



DETAIL B: CMS SYSTEM LOGICAL ARCHITECTURE

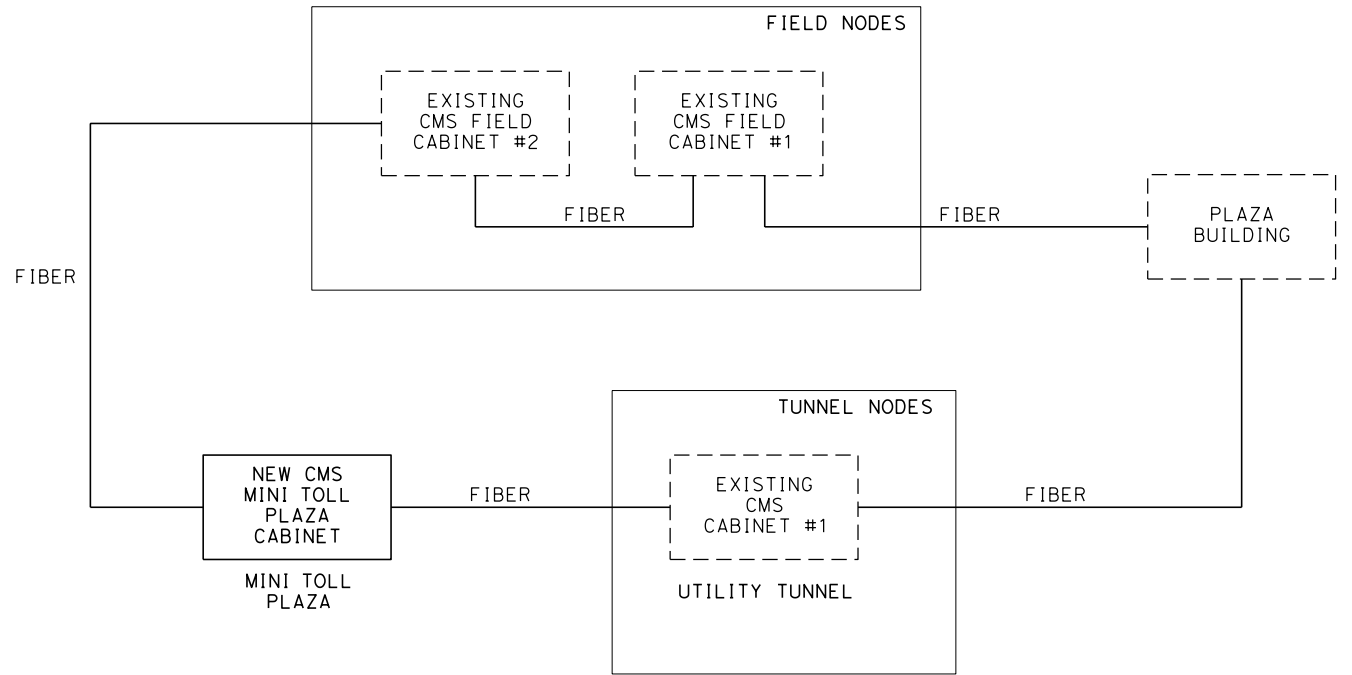

CMS SYSTEM NETWORK DETAILS  
(SAN MATEO - HAYWARD BRIDGE)

NO SCALE

E-11

SHEET	OF
11	20

LAST REVISION  
00-00-00  
DATE PLOTTED => \$DATE  
TIME PLOTTED => \$TIME

Dist	COUNTY	ROUTE	POST MILES TOTAL PROJECT	SHEET No.	TOTAL SHEETS
04	Ala	92	R2.59	114	123
REGISTERED CIVIL ENGINEER			3/12/10 DATE		
PLANS APPROVAL DATE			REGISTERED PROFESSIONAL ENGINEER RAMSEY J. HISSEN No. C-39608 Exp. 12/31/10 CIVIL STATE OF CALIFORNIA		
BAY AREA TOLL AUTHORITY 101 EIGHTH STREET OAKLAND, CA 94607			URS CORPORATION 55 S. MARKET STREET SUITE 1500 SAN JOSE, CA 95113		


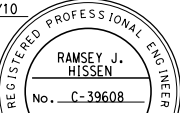
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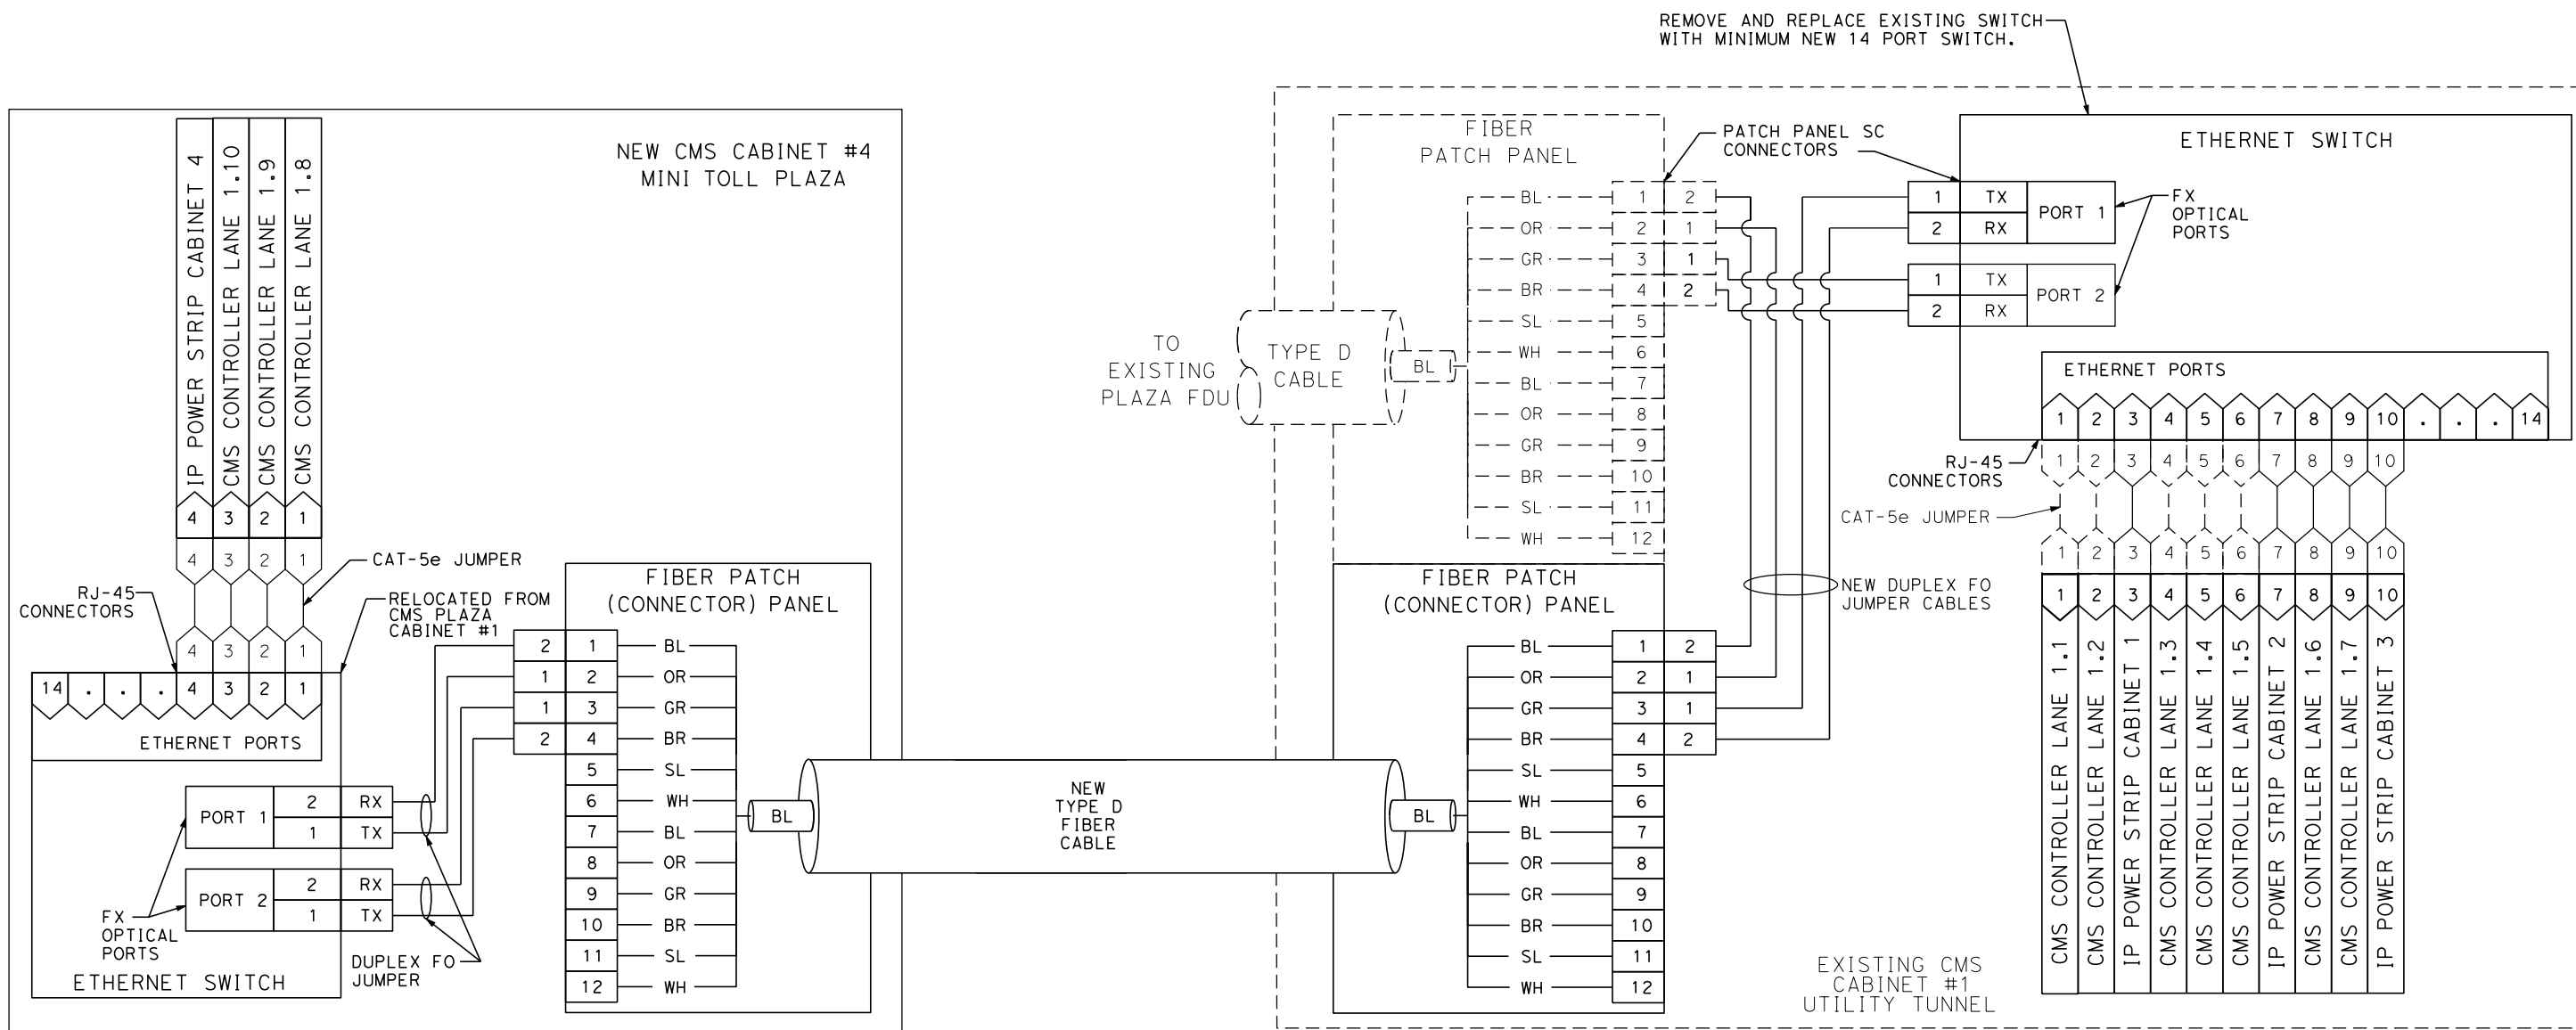
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EA TBD (BATA-0006)

Dist	COUNTY	ROUTE	POST MILES TOTAL PROJECT	SHEET TOTAL SHEETS
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 REGISTERED CIVIL ENGINEER			3/12/10 DATE	
PLANS APPROVAL DATE				
<p><i>THE STATE OF CALIFORNIA OR ITS OFFICERS OR AGENTS SHALL NOT BE RESPONSIBLE FOR THE ACCURACY OR COMPLETENESS OF SCANNED COPIES OF THIS PLAN SHEET.</i></p>				
BAY AREA TOLL AUTHORITY 101 EIGHTEEN STREET OAKLAND, CA 94607			URS CORPORATION 55 S. MARKET STREET SUITE 1500 SAN JOSE, CA 95113	

NOTES:

1. CONTRACTOR SHALL COORDINATE CLOSELY WITH BATA ON RE-CONFIGURATION OF CMS ETHERNET SWITCHES AND NETWORK OPERATIONS.
2. CONTRACTOR TO FIELD VERIFY THAT ALL TX/RX PORTS ARE MATCHED FOR PROPER OPERATIONS THROUGHOUT CMS NETWORK.



## CMS SYSTEM FIBER ASSIGNMENTS (SAN MATEO - HAYWARD BRIDGE)

NO SCALE

**E - 12**

SHEET	OF
12	20



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#REQUEST

STATE OF CALIFORNIA - DEPARTMENT OF TRANSPORTATION



REVISD BY

DATE REVISED

CALCULATED-  
DESIGNED BY


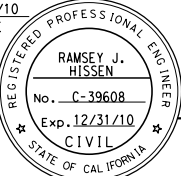
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CONSULTANT FUNCTIONAL SUPERVISOR

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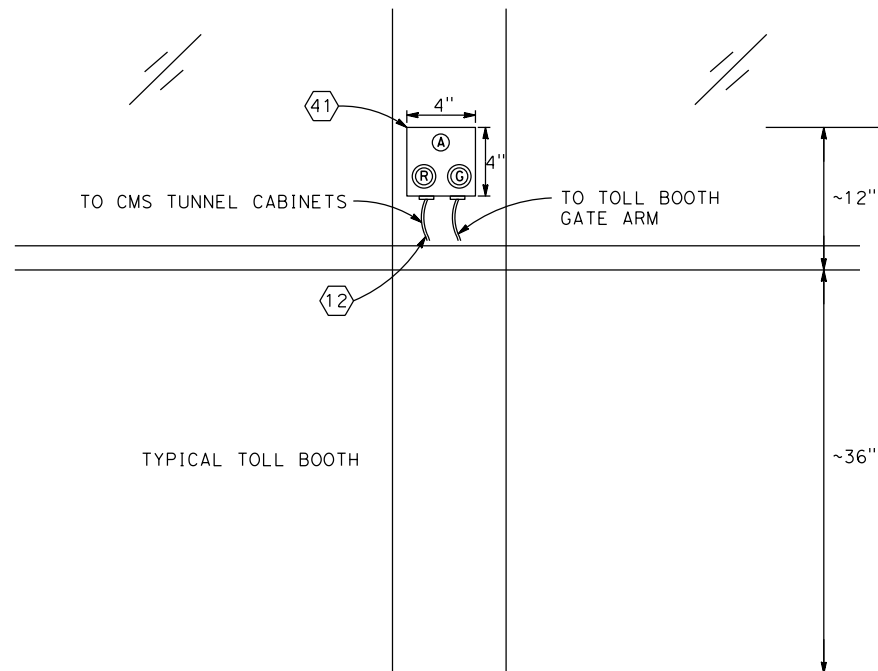
- ① CONTRACTOR TO UPDATE BREAKER PANEL BOARD SCHEDULE AND PROVIDE A NEW TYPED WRITTEN PANEL BOARD SCHEDULE.

PROJECT: BATA TO12 PLAZA CMS INSTALLATION										(E) PANEL- PE										LOCATION: SAN MATEO BRIDGE NORTH TUNNEL									
LOAD DESCRIPTION		LTG.	G.P. REC	OTH.	CB						CB		LTG.	G.P. REC	OTH.	LOAD DESCRIPTION													
					AMP	POLE					AMP	POLE																	
(E) LN1 CMS SIGN & TRAFFIC LT	0.10			0.50	20	1	1	A	2		20	1	0.10			0.50	(E) LN 2 CMS SIGN & TRAFFIC LT												
(E) LN 3 CMS SIGN & TRAFFIC LT	0.10			0.50	20	1	3	B	4		20	1	0.10			0.50	(E) LN 4 CMS SIGN & TRAFFIC LT												
(E) LN 5 CMS SIGN & TRAFFIC LT	0.10			0.50	20	1	5	C	6		20	1	0.10			0.50	(N) LN 6 CMS SIGN & TRAFFIC LT												
(N) LN 7 CMS SIGN & TRAFFIC LT	0.10			0.50	20	1	7	A	8		20	1					(E) SPARE												
(E) TOLL BOOTH 1- LT & REC					20	1	9	B	10		20	1					(E) TOLL BOOTH #2 LT & RECEP												
(E) TOLL BOOTH 3- LT & REC					20	1	11	C	12		20	1					(E) TOLL BOOTH #4 LT & RECEP												
(E) TOLL BOOTH 5- LT & REC					20	1	13	A	14		20	1					(E) TOLL BOOTH #6 LT & RECEP												
(E) TOLL BOOTH 7- LT & REC					20	1	15	B	16		20	1					(E) SPARE												
(E) DAMPER MOTORS					20	1	17	C	18		20	1					(E) TOLL BOOTH FAN CONTROL PNL												
					60		19	A	20		50																		
(E) CONDENSER UNIT- BOOTHS							21	B	22								(E) AIR HANDLING UNIT (ISOLATION X FMR)												
						3	23	C	24			3																	
					100		25	A	26		60																		
(E) ELEVATOR #2							27	B	28								(E) PANEL- Q (MINI PLAZA)												
						3	29	C	30			3																	
(E) REC- SUMP PUMP ELEV PIT					20	1	31	A	32		20	1					(E) LTS NORTH TUNNEL LT & REC ELEV RM.												
(E) REC- SUMP PUMP NORTH TUNNEL					20	1	33	B	34		20	1					(E) ELEVATOR #2 CAB LIGHT												
(E) TOLL BOOTH COOLING CONTROL PNL					20	1	35	C	36		20	1					(E) SPARE												
(E) SPARE					20	1	37	A	38		15	1			0.60		(E) CMS CONTROL CABINET CMS SIGN 1 & 2												
(E) SPARE					20	1	39	B	40		15	1			0.70		(E) CMS CONTROL CABINET CMS SIGN 3, 4, 5												
(E) SPARE					20	1	41	C	42		15	1			0.60		(N) CMS CONTROL CABINET CMS SIGN 6, 7												
TOTALS SECTION 1	0.40	0.00	2.00								0.30	0.00	3.40																
VOLTAGE: 120/208V	LOAD SUMMARY										ADDITIONAL FEATURES:																		
PHASE/WIRE: 3 PHASE / 4 WIRE	CONNECT LOAD	DEMAND FACTOR	DEMAND LOAD	BALANCE: (KVA) % AMPS:																									
RATING: 225A	0.70	125% OF LOAD	0.88	PHASE A: 2.40 39.34 6.67																									
MAINS: 150A-3P	0.00	NEC 220-13	0.00	PHASE B: 1.90 31.15 5.28																									
	5.40	1.00	5.40	PHASE C: 1.80 29.51 5.00																									
MOUNTING:	6.10 KVA		6.28 KVA																										
A.I.C.:	16.9 AMPS		17.4 AMPS																										
BUS SIZE:																													
S&L JOB #: 28016																													


Dist	COUNTY	ROUTE	POST MILES TOTAL PROJECT	SHEET No.	TOTAL SHEETS
04	Ala	92	R2.59	118	123
 REGISTERED CIVIL ENGINEER			3/12/10 DATE		
PLANS APPROVAL DATE _____					
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BAY AREA TOLL AUTHORITY 101 EIGHTEEN STREET OAKLAND, CA 94607			URS CORPORATION 55 S. MARKET STREET SUITE 1500 SAN JOSE, CA 95113		

NOTES:

1. SIZE OF CONSOLE SWITCH PANEL WILL BE FIELD DETERMINED BY CONTRACTOR TO ACCOMMODATE NUMBER OF LANES.
2. SEE SHEET E-3 FOR LOCATION OF INDICATOR LIGHT SWITCH CONSOLE PANEL.
3. SEE SHEETS E-16 AND E-17 FOR PROPOSED WIRING CONFIGURATION.
4. CONTRACTOR TO LABEL PUSH BUTTON SWITCH WITH R, G, AND A LETTERS FOR RED, GREEN, AND AMBER LANE INDICATION.




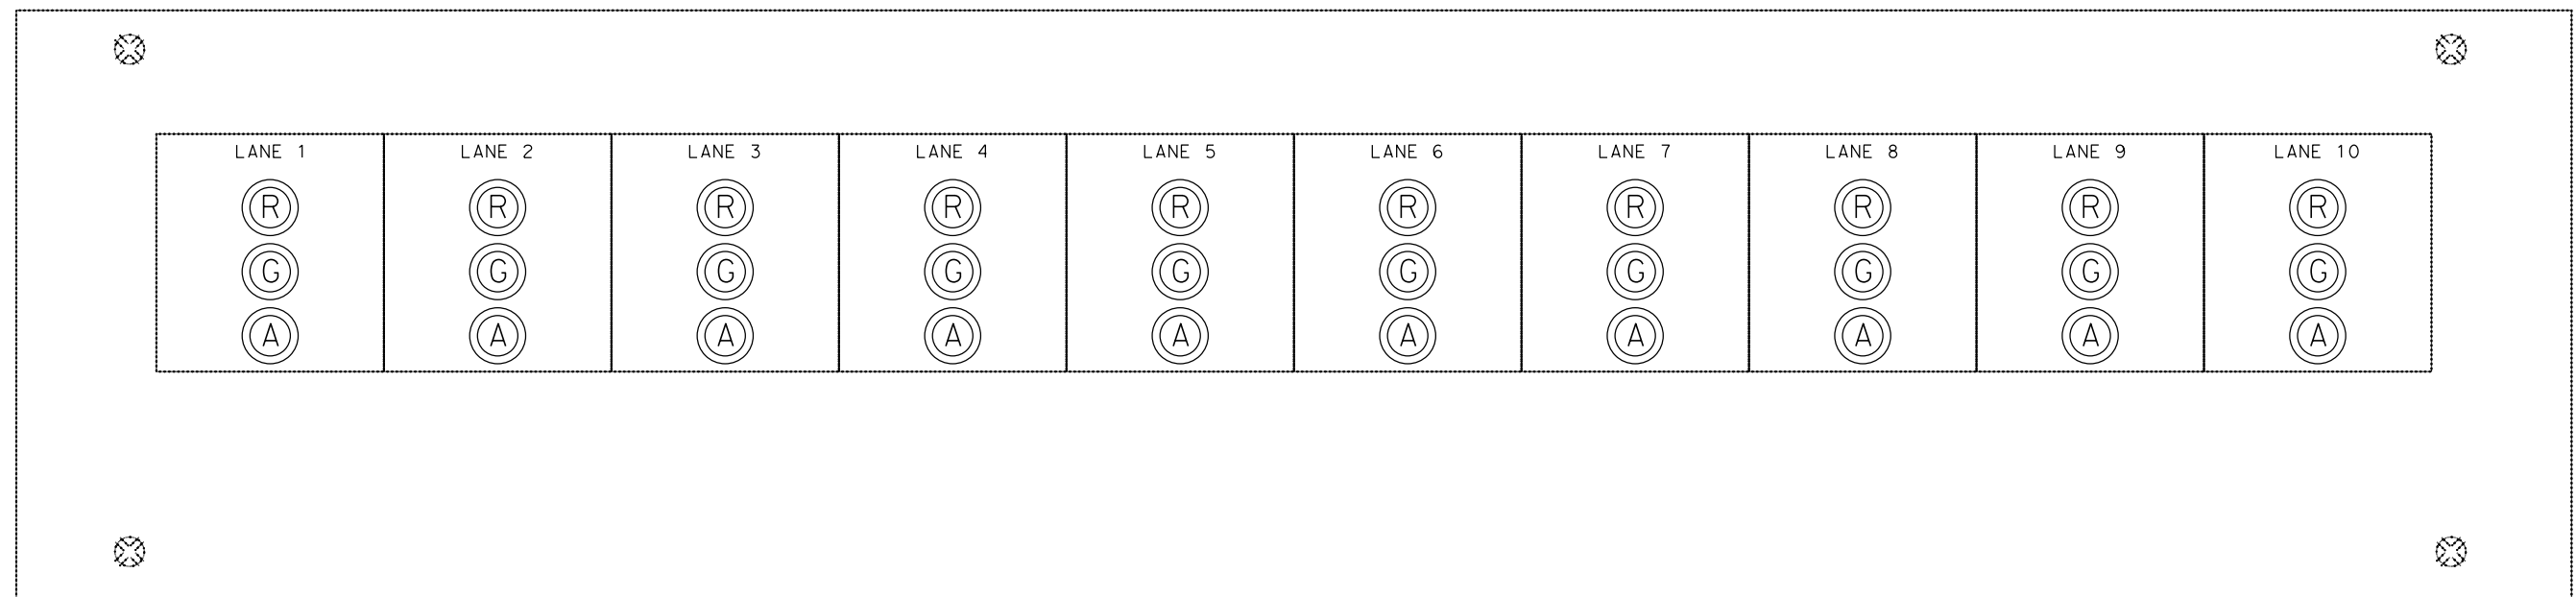


NEW TOLL BOOTH INDICATOR LIGHT SWITCH BOX



## NEW INDICATOR LIGHT SWITCH CONSOLE PANEL

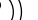LEGEND

- |   |   |
|---|---|
|  | PANEL MOUNT MOMENTARY RED LED<br>ILLUMINATED PUSH BUTTON SWITCH   |
|  | PANEL MOUNT MOMENTARY GREEN LED<br>ILLUMINATED PUSH BUTTON SWITCH |
|  | PANEL MOUNT MOMENTARY AMBER LED<br>ILLUMINATED PUSH BUTTON SWITCH |
|  | AMBER INDICATOR LED LIGHT   |

**INDICATOR LIGHT SWITCH CONSOLE PANEL  
AND TOLL BOOTH INDICATOR SWITCH BOX  
(SAN MATEO - HAYWARD BRIDGE)**

NO SCALE

E-15

SHEET	OF	LAST REVISION
15	20	

TIME PLOTTED => \$TIME	SAME PLOTTED => \$DATE
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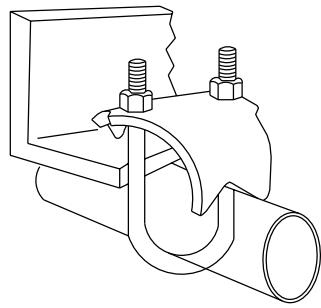





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				DATE REVISED	
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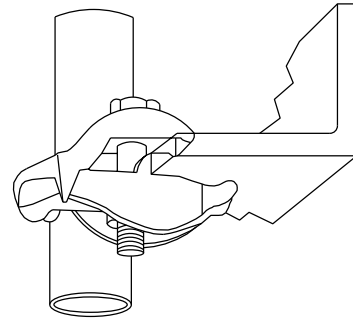
BORDER LAST REVISED 2/1/2008




FOR MOUNTING PIPES OR CONDUIT AT RIGHT ANGLES TO THE BEAM DETAIL




FOR MOUNTING PIPES OR CONDUIT PARALLEL TO THE BEAM DETAIL

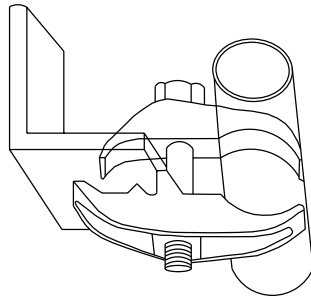

FOR MOUNTING PIPES OR CONDUIT VERTICALLY ACROSS BEAM EDGE DETAIL

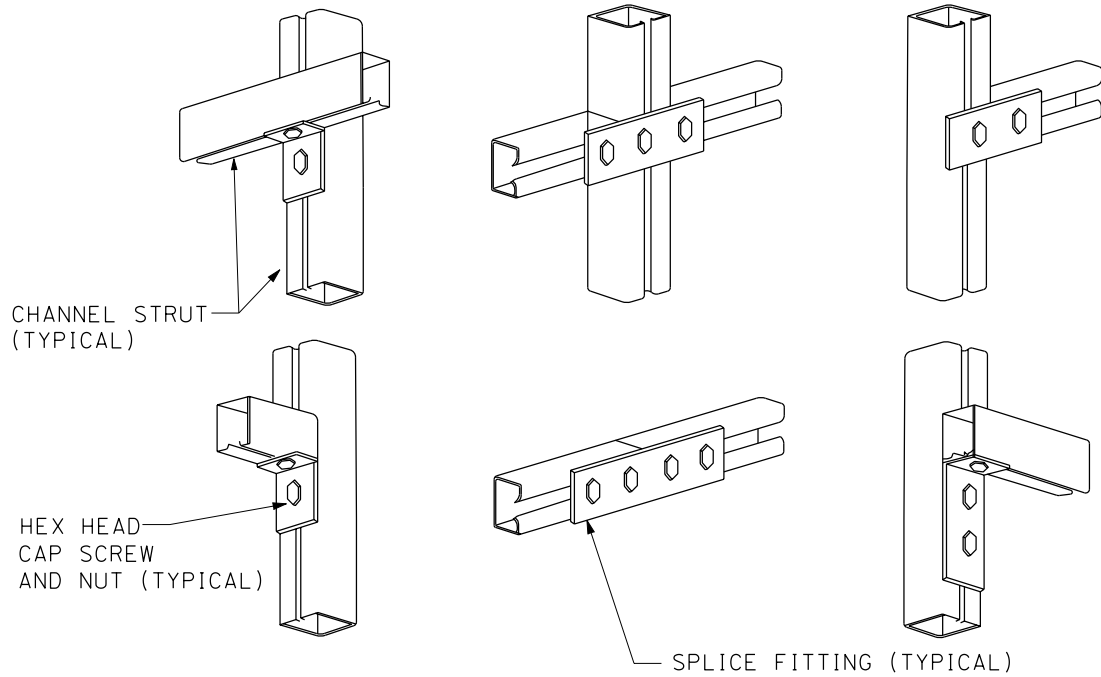

TYPICAL EQUIPMENT SUPPORT CHANNEL, FITTINGS AND FASTENERS

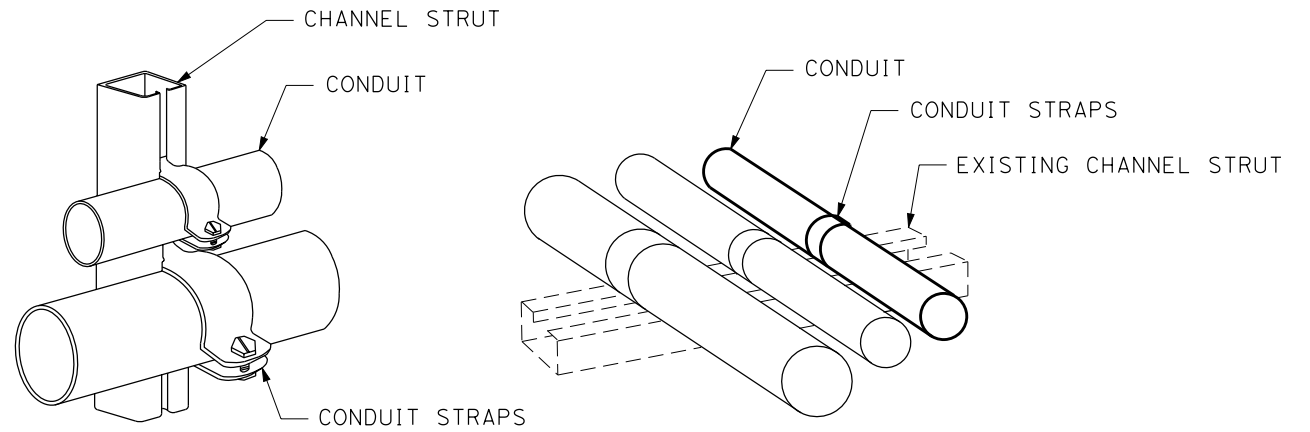

MOUNTING ON STRUT DETAILS

## CONDUIT MOUNTING AND ATTACHMENT DETAILS (SAN MATEO - HAYWARD BRIDGE)

NO SCALE

DIST	COUNTY	ROUTE	POST MILES TOTAL PROJECT	SHEET NO.	TOTAL SHEETS
04	Ala	92	R2.59	122	123
REGISTERED CIVIL ENGINEER			3/12/10 DATE	<div>REGISTERED PROFESSIONAL ENGINEER RAMSEY J. HISSEN No. C-39608 Exp. 12/31/10 CIVIL STATE OF CALIFORNIA</div>	
PLANS APPROVAL DATE					
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E-19

SHEET	OF
19	20

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TIME PLOTTED => \$TIME

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DGN FILE => \$REQUEST

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